




ISSUES	DATE
ENTITLEMENT APPLICATION	03/24/2022
ENTITLEMENT APPLICATION #2	08/19/2022
ENTITLEMENT APPLICATION #3	12/09/2022
ENTITLEMENT APPLICATION #4	09/18/2023

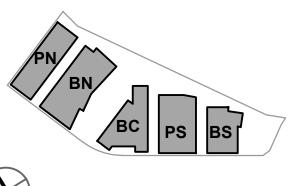



Bayshore Project Tree Data

Tag #	Botanic Name	Common Name	Diameter (in)	Circumference (in)	Height (ft)	Spread (ft)	Health	Risk	Regulated Tree
	Eucalyptus	Red Ironbark Gum					Fair	Law	
401	sideroxylon Eucalyptus	Red Horibark Guill	21.8	68.5	40	70	ган	Low	X
402	sideroxylon	Red Ironbark Gum	23.5	73.8	40	70	Poor	Low	X
	Eucalyptus								
403	lehmanii	Bushy Yate	10.5	33.0	30	30	Fair	Low	
404	Eucalyptus lehmanii	Bushy Yate	12.0	37.7	30	25	Fair	Low	
404	Eucalyptus	busily rate	12.0	31.1	30	33	raii	Low	
405	lehmanii	Bushy Yate	9.5	29.8	25	25	Fair	Low	
-	Eucalyptus	•							
406	sideroxylon	Red Ironbark Gum	18.7	58.7	40	40	Poor	Low	x
40=	Eucalyptus	De dite de la C		00.5			- .		
407	sideroxylon	Red Ironbark Gum	21.3	66.9	30	40	Fair	Low	Х
408	Eucalyptus sideroxylon	Red Ironbark Gum	20.2	63.5	40	25	Poor	Low	x
700	Eucalyptus	TOG HOHDGIN OUIII	20.2	00.0	40	23	. 001	LUVV	^
409	sideroxylon	Red Ironbark Gum	12.8	40.2	25	25	Very Poor	Low	
	Eucalyptus								
410	sideroxylon	Red Ironbark Gum	10.1	31.7	25	20	Very Poor	Low	
411	Acacia Baileyana	Bailey's Acacia	5.2	16.3	10	15	Dead	Low	
	Eucalyptus		0.2	1010				2011	
412	sideroxylon	Red Ironbark Gum	19.9	62.5	40	40	Good	Low	x
	Eucalyptus								
413	sideroxylon	Red Ironbark Gum	21.3	66.9	40	40	Good	Low	X
444	Eucalyptus	Dad Iranhault Court	40.0	04.0	40	00	Door	Laure	
414	sideroxylon Eucalyptus	Red Ironbark Gum	19.6	61.6	40	30	Poor	Low	Х
415	sideroxylon	Red Ironbark Gum	28.7	90.2	30	40	Poor	Low	x
	Populus nigra		20.1	30.2	- 55	-70			^
416	'Italica'	Lombardy Poplar	32.0	100.5	60	30	Fair	Low	X
	Populus nigra								
417	'Italica'	Lombardy Poplar	6.2	19.5	50	10	Fair	Low	
418	Pyracantha spp.	Firethorn	5.5	17.3	15	15	Dead	Low	
710	Populus nigra	. Houldin	5.5	17.3	13	13	2000	LUVV	
419	'Italica'	Lombardy Poplar	44.9	141.1	60	50	Fair	Low	X
		, ,							
420	Pyracantha spp.	Firethorn	5.3	16.7	15	15	Fair	Low	
	Ligustrum								
421	lucidum	Glossy Privet	6.0	18.8	15		Fair	Low	
422	Unknown	Unknown	9.1	28.6	25	20	Very Poor	Low	

Tree Management Experts 2021

Tree Management Experts 2021

Page 1 of 5

Bayshore Project

Tag #	Botanic Name	Common Name	Diameter (in)	Circumference (in)	Height (ft)	Spread (ft)	Health	Risk	Regulated Tree
423	Eucalyptus sideroxylon	Red Ironbark Gum	24.8	77.9	35		Fair	Low	х
424	Eucalyptus sideroxylon	Red Ironbark Gum	20.2	63.5	25	25	Poor	Low	x
425	Eucalyptus sideroxylon	Red Ironbark Gum	24.9	78.2	30	30	Good	Low	x
426	Eucalyptus sideroxylon	Red Ironbark Gum	25.0	78.5	30	30	Fair	Low	x
427	Eucalyptus sideroxylon	Red Ironbark Gum	25.3	79.5	30	30	Fair	Low	x
428	Persea americana	Avocado	4.1	12.9	20	20	Excellent	Low	
429	Araucaria columnaris Araucaria	Cook Pine	6.5	20.4	15	15	Good	Low	
430	columnaris Araucaria	Cook Pine	7.0	22.0	15	15	Good	Low	
431	columnaris Metrosideros	Cook Pine New Zealand	8.0	25.1	15	15	Good	Low	
432	excelsa	Christmas Tree	8.7	27.3	15	10	Fair	Low	
433	Acacia Baileyana	Bailey's Acacia	1.0	3.1	8	4	Excellent	Low	
434	Acacia Baileyana Tristaniopsis	Bailey's Acacia	7.6	23.9	18	20	Fair	Low	
435	laurina Trachycarpus	Small-Leaf Tristania	2.3	7.2	10	6	Good	Low	
436	fortunei Trachycarpus	Windmill Palm	8.8	27.6	8	6	Good	Low	
437	fortunei Trachycarpus	Windmill Palm	7.6	23.9	6		Fair	Low	
438	fortunei Trachycarpus	Windmill Palm	8.8	27.6			Fair	Low	
439	fortunei Trachycarpus	Windmill Palm	9.2	28.9			Fair	Low	
440	fortunei Trachycarpus	Windmill Palm	5.3				Fair	Low	
441	fortunei Trachycarpus	Windmill Palm	9.2	28.9			Fair	Low	
442	fortunei Trachycarpus	Windmill Palm	8.8	27.6			Fair	Low	
443	fortunei Myoporum	Windmill Palm	8.9	28.0			Poor	Low	
444	laetum	Ngaio	15.5	48.7	20	20	Very Poor	Low	X

Bayshore Project Tree Data

2.1 6.6 10 8 Good Low

16.3 51.2 30 30 Good Low

11.6 36.4 25 20 Very Poor Low

14.2 44.6 20 30 Very Poor Low

20.1 63.1 25 25 Very Poor Moderate x

45 Fair

Low

Low

18.1 56.9 30 30 Fair

21.0 66.0 50 40 Fair

23.2 72.9 50

Silver-Dollar Gum 16.3 51.2 30 20 Good Low

Silver-Dollar Gum 13.0 40.8 20 25 Fair Low

Hollywood Juniper 8.0 25.1 20 15 Good Low

Hollywood Juniper 4.0 12.6 15 Good Low

Tree Management Experts 2021

Botanic Name

Dodonaea viscosa 'Purpurea'

Schinus

terebinthifolia

terebinthifolia

Pinus radiata

Pinus radiata

Pinus radiata

polyanthemos Eucalyptus polyanthemos

Pinus radiata Juniperus chinensis 'Torulosa'

Juniperus chinensis

'Torulosa'

Eucalyptus

Dodonaea viscosa 'Purpurea' Pinus radiata Common Name

Purple Hopseed

Brazilian Pepper

Brazilian Pepper

Monterey Pine

Monterey Pine

Monterey Pine

Monterey Pine

Page 2 of 5

		Ва	yshore Pr Tree Dat						
Tag #	Botanic Name	Common Name	Diameter (in)	Circumference (in)	Height (ft)	Spread (ft)	Health	Risk	Regulated Tree
ray #	Myoporum	Common Name		<u> </u>	T)	t)	ricaiiii	IXISK	Φ
445	laetum	Ngaio	8.8	27.6	15	18	Very Poor	Low	
	Myoporum								
446	laetum	Ngaio	9.3	29.2	15	15	Dead	Low	
	Myoporum								
447	laetum	Ngaio	11.8	37.1	20	25	Very Poor	Low	
4.40	Myoporum	Nania	44.4	05.0	00	00	\/ D		
448	laetum	Ngaio	11.4	35.8	20	20	Very Poor	Low	
449	Myoporum laetum	Ngaio	11.8	37.1	25	25	Very Poor	Low	
743	Myoporum	INGAIO	11.0	37.1	23	23	very roof	LOW	
450	laetum	Ngaio	8.1	25.4	25	25	Very Poor	Low	
.00	Myoporum	1.195.19	0.1	201	20	20	7 5. 7 . 001		
451	laetum	Ngaio	10.0	31.4	25	25	Very Poor	Low	
	Myoporum						,		
452	laetum	Ngaio	11.8	37.1	25	25	Very Poor	Low	
	Myoporum								
453	laetum	Ngaio	9.1	28.6	20	20	Very Poor	Low	
	Myoporum			_			_		
454	laetum	Ngaio	11.3	35.5	20	20	Very Poor	Low	
455	Myoporum	Nacio	0.0	20.0	0.5	0.5	Vam. Daar		
455	laetum	Ngaio	9.8	30.8	25	25	Very Poor	LOW	
456	Myoporum laetum	Ngaio	9.7	30.5	25	25	Very Poor	LOW	
430	Myoporum	Ngaio	3.1	30.3	23	23	very r cor	LOW	
457	laetum	Ngaio	10.2	32.0	20	25	Very Poor	Low	
	Myoporum	3		02.0					
458	laetum	Ngaio	7.2	22.6	15	15	Dead	Low	
	Myoporum	-							
459	laetum	Ngaio	11.9	37.4	20	20	Very Poor	Low	
	Myoporum								
460	laetum	Ngaio	10.4	32.7	15	15	Dead	Low	
101	Myoporum	Nonein		40-			D '		
461	laetum	Ngaio	5.9	18.5	10	10	Dead	Low	
462	Myoporum laetum	Ngaio	11 0	27.4	20	O.F.	Very Poor	Low	
402	Myoporum	ingalu	11.8	37.1	20	25	very Foor	LOW	
463	laetum	Ngaio	11.9	37.4	20	25	Very Poor	Low	
.00	Myoporum	1. 195.15	11.0	51.4	20	20	20.7 1 001		
464	laetum	Ngaio	10.5	33.0	20	20	Very Poor	Low	
	Myoporum						•		
465	laetum	Ngaio	12.0	37.7	20	25	Very Poor	Low	
	Myoporum								
466	laetum	Ngaio	13.7	43.0	20	25	Very Poor	Low	

Tree Management Experts 2021 Page 3 of 5

8/1/2022 5:48:22 PM

Bayshore Project


Tag #	Botanic Name	Common Name	Diameter (in)	Circumference (in)	Height (ft)	Spread (ft)	Health	Risk	Regulated Tree
467	Myoporum laetum	Ngaio	10.7	33.6	20		Very Poor	Low	
468 469	Myoporum laetum Metrosideros excelsa	Ngaio New Zealand Christmas Tree	15.2 5.3	47.8 16.7	20		Very Poor	Low	
470	Juniperus chinensis 'Torulosa'	Hollywood Juniper	11.0	34.6	15		Good	Low	
471	Magnolia soulangeana	Saucer Magnolia	7.2	22.6	20	25	Good	Low	
472	Myoporum laetum Chamaerons	Ngaio Mediterranean Fan	7.2	22.6	25	15	Very Poor	Low	
473	Chamaerops humilis	Palm	12.8	40.2	10	15	Fair	Low	
474	Pyrus Calleryana 'Aristocrat'	Aristocrat Callery Pear	14.3	44.9	30	30	Good	Low	
475	Yucca gloriosa	Spanish Dagger	20.0	62.8	30	20	Good	Low	х
476	Eucalyptus polyanthemos Juniperus	Silver-Dollar Gum	16.4	51.5	25	35	Fair	Low	x
477	chinensis 'Torulosa'	Hollywood Juniper	6.1	19.2	15	15	Very Poor	Low	
478	Juniperus chinensis 'Torulosa'	Hollywood Juniper	7.4	23.2	15	15	Very Poor	Low	
479	Juniperus chinensis 'Torulosa'	Hollywood Juniper	9.2	28.9	20	20	Very Poor	Low	
480	Eucalyptus polyanthemos	Silver-Dollar Gum	19.6	61.6	35	25	Good	Low	x
481	Callistemon viminalis	Weeping Bottlebrush	20.0	62.8	30	30	Good	Low	x
482	Eucalyptus polyanthemos Callistemon	Silver-Dollar Gum Weeping	3.0	9.4	15	6	Good	Low	
483	viminalis Callistemon	Bottlebrush	9.6	30.2	25	10	Fair	Low	
484	viminalis	Weeping Bottlebrush	13.0	40.8	30	25	Fair	Low	
485	Callistemon viminalis	Weeping Bottlebrush	12.0	37.7	30	25	Fair	Low	
486	Pinus thunbergiana	Japanese Black Pine	14.8	46.5	30	30	Poor	Low	

Page 4 of 5

Tree Management Experts 2021

WRNSSTUDIO

501 SECOND STREET 4TH FLOOR, STE. 402 SAN FRANCISCO CALIFORNIA 94107 415.489.2224 TEL 415.358.9100 FAX WWW.WRNSSTUDIO.COM

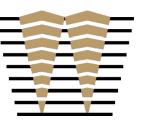

WATRY DESIGN, INC.

CMG






WATT

ISSUES	DATE
ENTITLEMENT APPLICATION	03/24/2022
ENTITLEMENT APPLICATION #2	08/19/2022
ENTITLEMENT APPLICATION #3	12/09/2022
ENTITLEMENT APPLICATION #4	09/18/2023

Peninsula Crossing 1200-1340 Old Bayshore Hwy, Burlingame, CA 94010

KEYPLAN

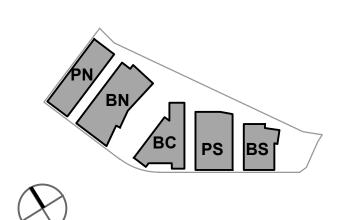

PROJECT NO.: 20045.00 DATE: 08/19/2022 SCALE: N/A

SHEET TITLE:

EXISTING TREE INVENTORY

SHEET NO:


Page 5 of 5

ENT L-002

All drawings and written material appearing herein constitute original and unpublished work of the Architect/Engineer and may not be duplicated, used or disclosed without consent of Architect/Engineer.



501 SECOND STREET 4TH FLOOR, STE. 402 SAN FRANCISCO CALIFORNIA 94107 415.489.2224 TEL 415.358.9100 FAX WWW.WRNSSTUDIO.COM

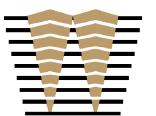

WATRY DESIGN, INC.
Architects • Engineers • Parking Planners







moffatt & nic


WATT

ISSUES	DATE
ENTITLEMENT APPLICATION	03/24/2022
ENTITLEMENT APPLICATION #2	08/19/2022
ENTITLEMENT APPLICATION #3	12/09/2022
ENTITLEMENT APPLICATION #4	09/18/2023

DW Burlingame Venture, LLC

Peninsula Crossing
1200-1340 Old Bayshore Hwy, Burlingame, CA 94010

KEYPLAN

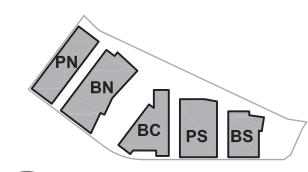



PROJECT NO.: 20045.00 DATE: 08/19/2022 SCALE: 1"=50'

SHEET TITLE:

LANDSCAPE SITE PLAN -ILLUSTRATIVE



SHEET NO:



501 SECOND STREET 4TH FLOOR, STE. 402 SAN FRANCISCO CALIFORNIA 94107 415.489.2224 TEL 415.358.9100 FAX WWW.WRNSSTUDIO.COM










WATT

ISSUES	DATE
ENTITLEMENT APPLICATION	03/24/2022
ENTITLEMENT APPLICATION #2	08/19/2022
ENTITLEMENT APPLICATION #3	12/09/2022
ENTITLEMENT APPLICATION #4	09/18/2023

DW Burlingame Venture, LLC

Peninsula Crossing
1200-1340 Old Bayshore Hwy, Burlingame, CA 94010

KEYPLAN

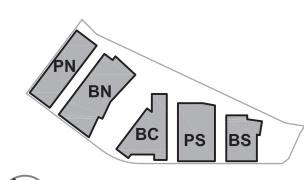




PROJECT NO.: 20045.00 DATE: 08/19/2022

SCALE: 1"=50'

SHEET TITLE:

LANDSCAPE ROOF PLAN - ILLUSTRATIVE



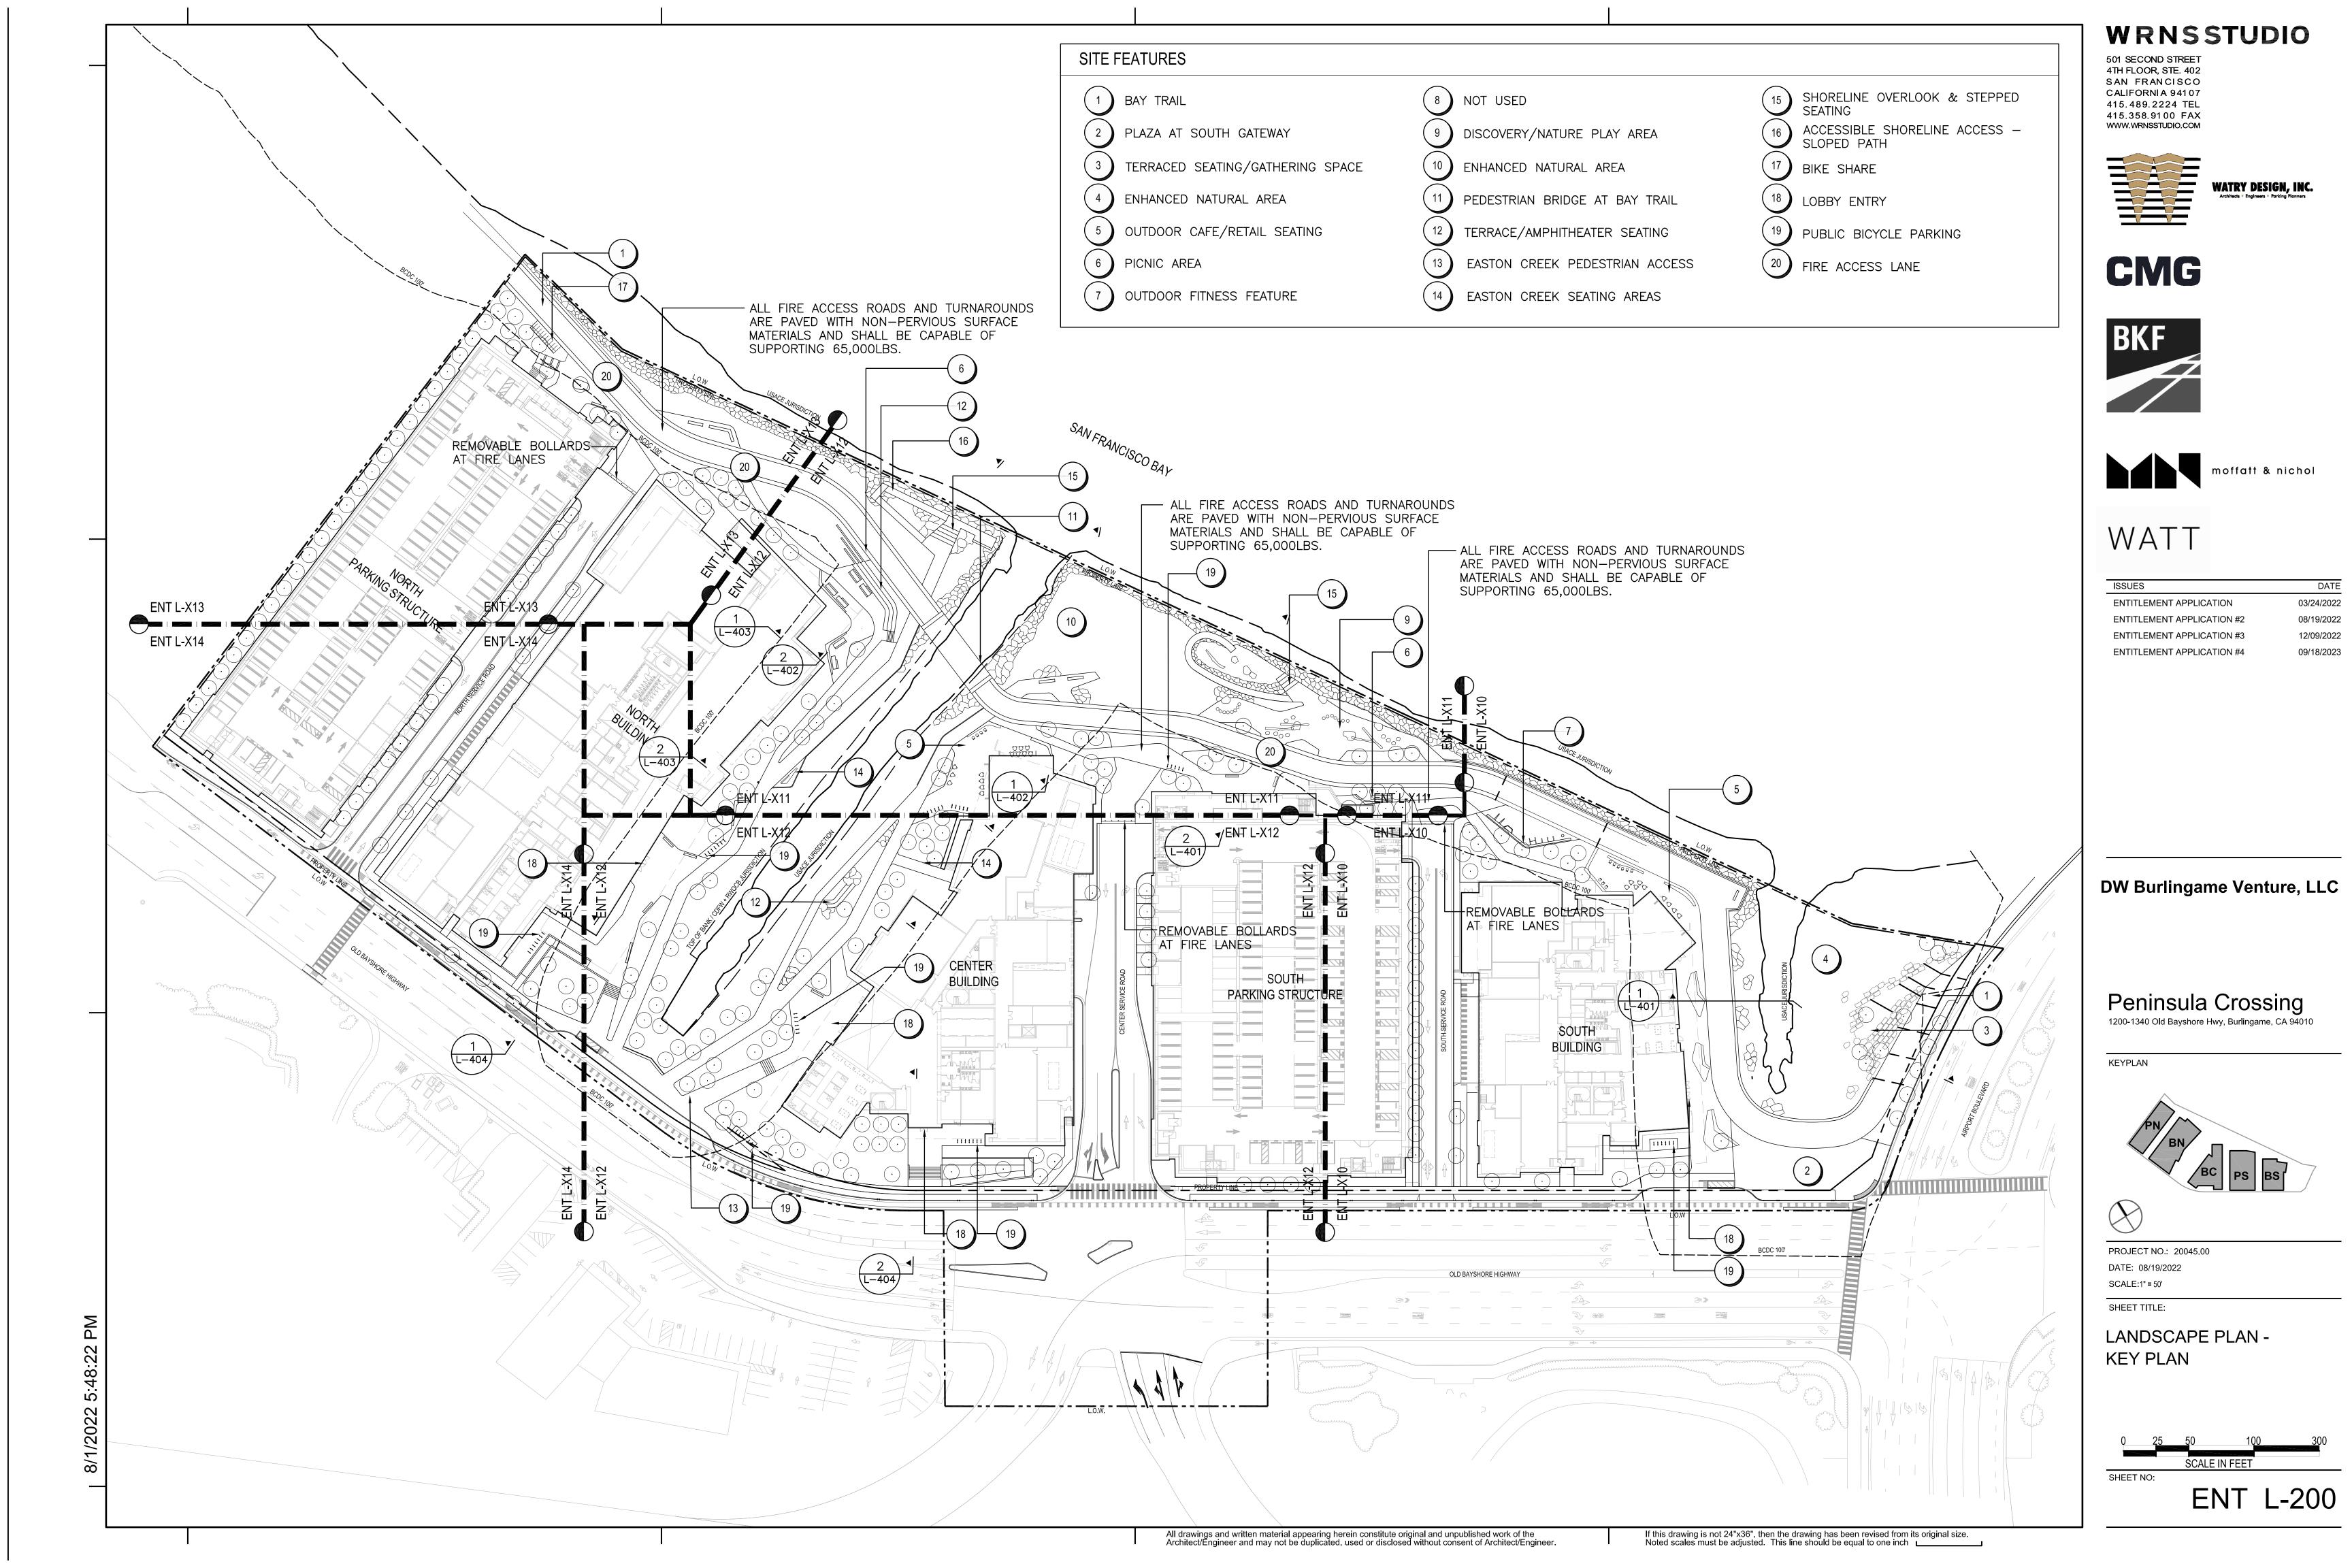


GENERAL NOTES	MATERIALS SCHEDULE					
. SEE CIVIL AND ARCHITECTURE DRAWINGS FOR PARKING LOT PAVING AND STRIPING,	PAVING					
DRIVEWAYS, AND CURBS.	TAG SYMBOL	TYPE	DESCRIPTION	NOTES		
SEE ARCHITECTURAL PLANS FOR ADDITIONAL DETAILS AND DIMENSIONING OF WALLS, RAILING AND FENCES EXTERIOR BIKE PARKING: CALGREEN BUIDING CODE REQUIRES EXTERIOR BIKE PARKING TO	P1A	CIP CONCRETE -PEDESTRIAN	4" CIP CONCRETE OVER 4" AGGREGATE BASE, STANDARD GREY, TOOLED JOINTS			
EQUAL 5% OF PUBLIC CAR PARKING. PROJECT WILL COMPLY WITH GALGREEN BUILDING CODE BIKE PARKING REQUIREMENTS. VEHICULAR PAVING AT ALL FIRE ACCESS LANES TO BE RATED FOR FIRE TRUCK LOADING,	P1B	CIP CONCRETE -VEHICULAR	6" CIP CONCRETE OVER 4" AGGREGATE BASE, STANDARD GREY, TOOLED JOINTS. VEHICULAR CONC. SHALL SUPPORT FIRE TRUCK LOADING — MIN. 65,000 LBS.			
MINIMUM 65,000 LBS.	P2A	SPECIAL CIP CONCRETE -PEDESTRIAN	4" CIP CONCRETE OVER 4" AGGREGATE BASE, INTEGRAL COLOR, TOP SEEDED AGGREGATE, SAW CUT JOINTS. VEHICULAR CONC. SHALL SUPPORT MAINTENANCE VEHICLE LOADING			
	P2B	SPECIAL CIP CONCRETE -VEHICULAR	6" CIP CONCRETE OVER 4" AGGREGATE BASE, INTEGRAL COLOR, TOP SEEDED AGGREGATE, SAW CUT JOINTS. VEHICULAR CONC. SHALL SUPPORT FIRE TRUCK LOADING — MIN. 65,000 LBS.			
EGEND	P3	BAY TRAIL ASPHALT	VEHICULAR ASPHALT PAVING — 5% ASPHALT CEMENT AND 95% AGGREGATES (STONE, SAND, AND GRAVEL).			
PA PLANTING AREA — SEE PLANTING PLANS	P4	GRAVEL AT GRAVEL "BEACH"	MIXED GRAVEL: 50% 3/8 " PEA GRAVEL, 30% \(\frac{1}{4}\)" PEA GRAVEL, 20% CLEAN DRAIN ROCK.			
+17 SPOT ELEVATION USACE UNITED STATES ARMY CORPS OF ENGINEERS JURISDICTION	P5A	STABILIZED CRUSHED STONE PAVING	GRANITECRETE STABILIZED CRUSHED STONE COLOR: NATURAL GOLD			
CALIFORNIA DEPARTMENT OF FISH AND WILDLIFE JURISDICTION REGIONAL WATER QUALITY CONTROL BOARD SAN ERANGISCO BAY CONSERVATION AND DEVELOPMENT	P5B	STABILIZED CRUSHED STONE PAVING -VEHICULAR	GRANITECRETE STABILIZED CRUSHED STONE COLOR: NATURAL GOLD VEHICULAR SCSP SHALL SUPPORT FIRE TRUCK LOADING — MIN. 65,000 LBS.			
BCDC 100' SAN FRANCISCO BAY CONSERVATION AND DEVELOPMENT COMMISSION 100' JURISDICTION	P6	RUBBERIZED SURFACE	POURED-IN-PLACE RUBBER.	FITNESS PLAZA		
	SITE ELEME	NTS				
	TAG	TYPE	DESCRIPTION			
	E1	RIP RAP	FINAL LOCATION OF RIPRAP TO BE LOCATED WHERE NECESSARY TO PREVENT SHORELINE EROSION.	REFER TO SHORELINE ENGINEERING DRAWINGS		
		NATURAL BOULDERS	LARGE SCALE NATIONAL BOULDERS — SONOMA FIELD STONE OR GRANITE BOULDERS			
	E3 E 3	NATURE PLAY FEATURES	LARGE SCALE NATUUAL BOULDERS, STRIPPED AND SANDED LOGS, LOG SEGMENTS. PEDESTRIAN BRIDGE AT EASTON CREEK BAY TRAIL. BEAM BRIDGE			
	E4 E 4	BRIDGE	WITH WOOD DECKING AND GALVANIZED STEEL RAILIINGS			
	E5)	GUARD RAIL	STAINLESS STEEL GUARD RAIL 42" HEIGHT			
	E6)	BIKE SHARE				
	E7	STACKED BLOCKS	CAST-IN-PLACE CONCRETE, PRECAST CONCRETE, OR MONOLITHIC STONE BLOCK FOR TERRACED SEATING.			
		BLEACHER SETAING A BLEACHER SETAING B	CAST—IN—PLACE CONCRETE BLEACHER SEATING CAST—IN—PLACE CONCRETE BLEACHER SEATING WITH STAIRS			
		SEAT WALL	CAST—IN—PLACE CONCRETE SEAT WALL			
	E11	SEA WALL	SEA WALL — SEE SHORELINE ENGINEERING DRAWINGS			
	E12	CUSTOM BENCH	CAST-IN-PLACE CONCRETE WITH WOOD AND STEEL SEAT AND BACK.			
	E13	SLOPED WALK	SLOPED WALK, MAXIMUM 4.8% SLOPE. 6" CURBS ON BOTH SIDES OF WALK			
	E14	STAIRS	CAST-IN-PLACE CONCRETE STAIRS WITH STAINLESS STEEL HAND RAILS AND CIP CHEEK WALL			
	E15	PICNIC TABLE	MANUFACTURED PICNIC TABLE			
	E16	FITNESS EQUIPMENT	EXTERIOR FITNESS STATIONS. SIMILAR TO NATIONAL FITNESS CAMPAIGN "FITNESS COURTS." WELLE CIRCULAR BIKE RACK. GALVANIZED STEEL. ROUND TUBE.			
		BIKE RACK	SURFACE MOUNT.			
	E18 E19	BIKESHARE STATION REMOVABLE BOLLARD	STAINLESS STEEL REMOVEABLE BOLLARD AT EVA LANES			
		FIRE ACCESS LANE	-			

ADA PEDESTRIAN RAMP

WRNSSTUDIO

501 SECOND STREET 4TH FLOOR, STE. 402 SAN FRANCISCO CALIFORNIA 94107 415.489.2224 TEL 415.358.9100 FAX WWW.WRNSSTUDIO.COM

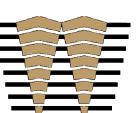

WATRY DESIGN, INC.

Architects • Engineers • Parking Planners

CMG





moffatt & nicho





ISSUES	DATE
ENTITLEMENT APPLICATION	03/24/2022
ENTITLEMENT APPLICATION #2	08/19/2022
ENTITLEMENT APPLICATION #3	12/09/2022
ENTITLEMENT APPLICATION #4	09/18/2023

Peninsula Crossing

1200-1340 Old Bayshore Hwy, Burlingame, CA 94010

KEYPLAN

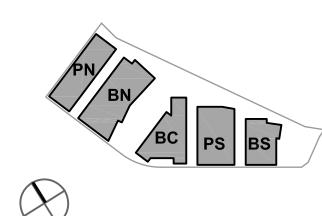


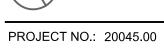

DATE: 08/19/2022 SCALE: N/A

SHEET TITLE:


LANDSCAPE MATERIALS SCHEDULE

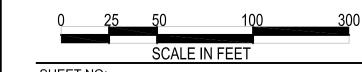



SHEET NO:


ENT L-201


ACCESSIBLE RAMP WITH HANDRAILS - MAX 8.0% SLOPE

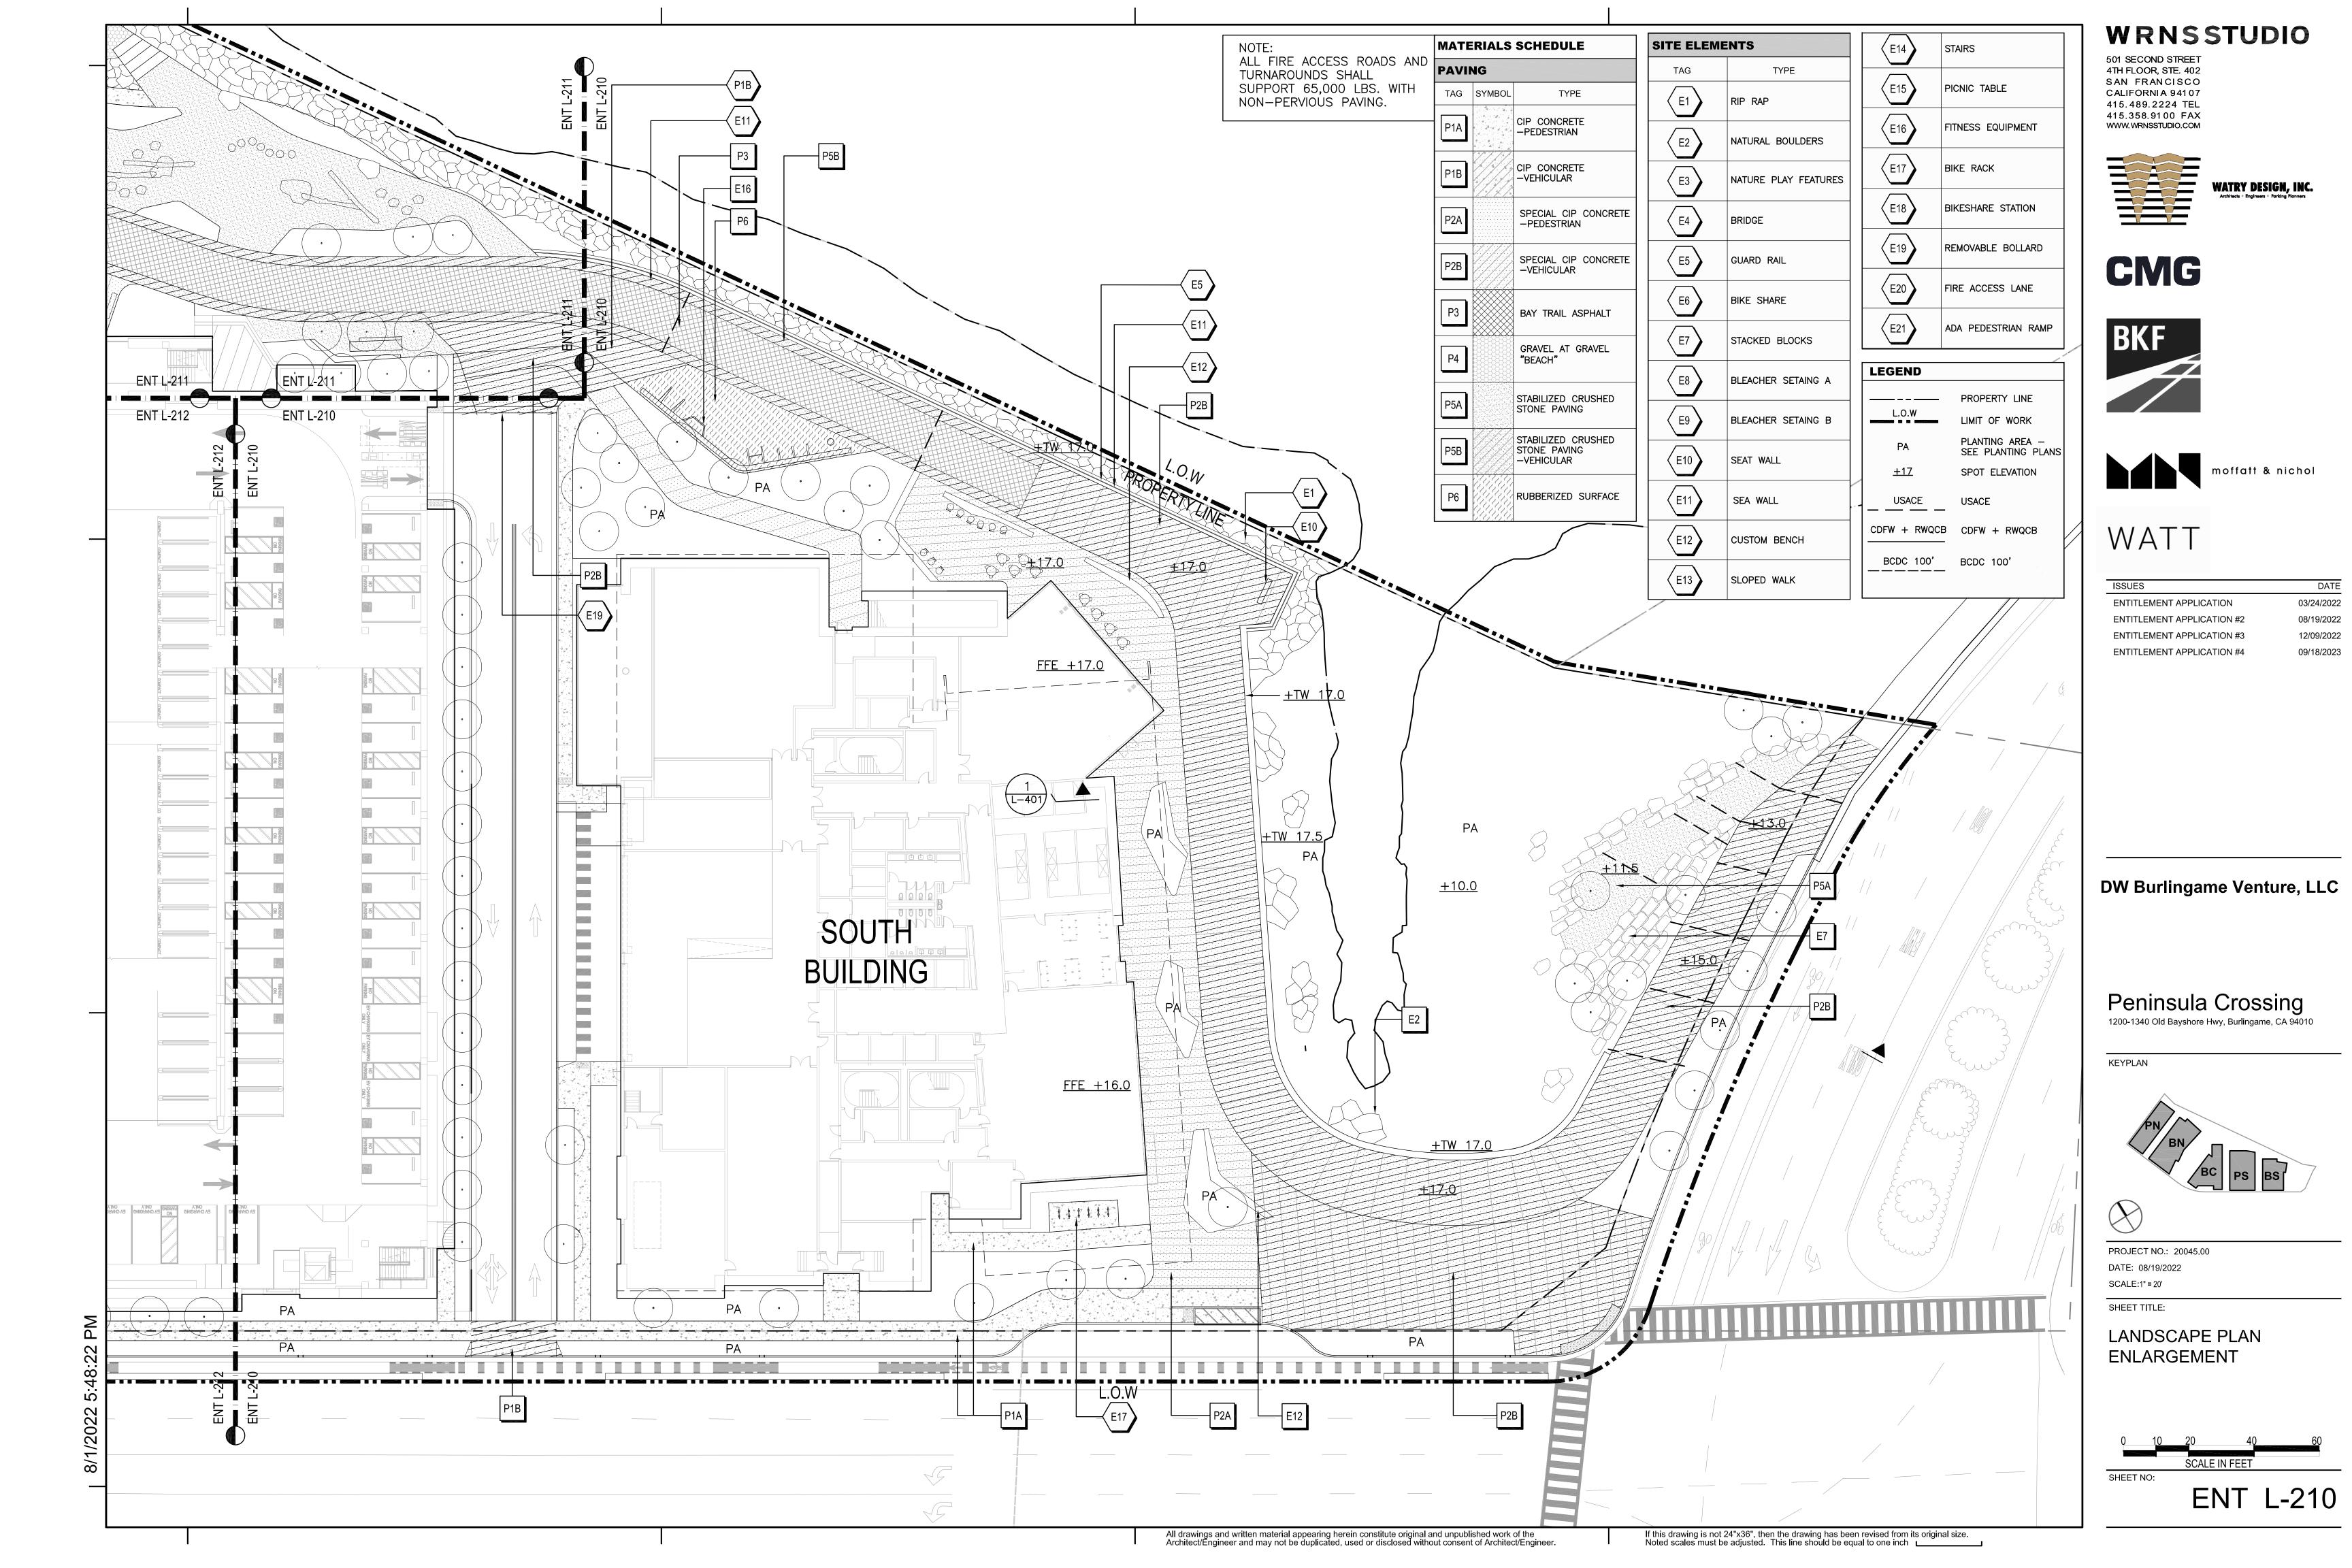


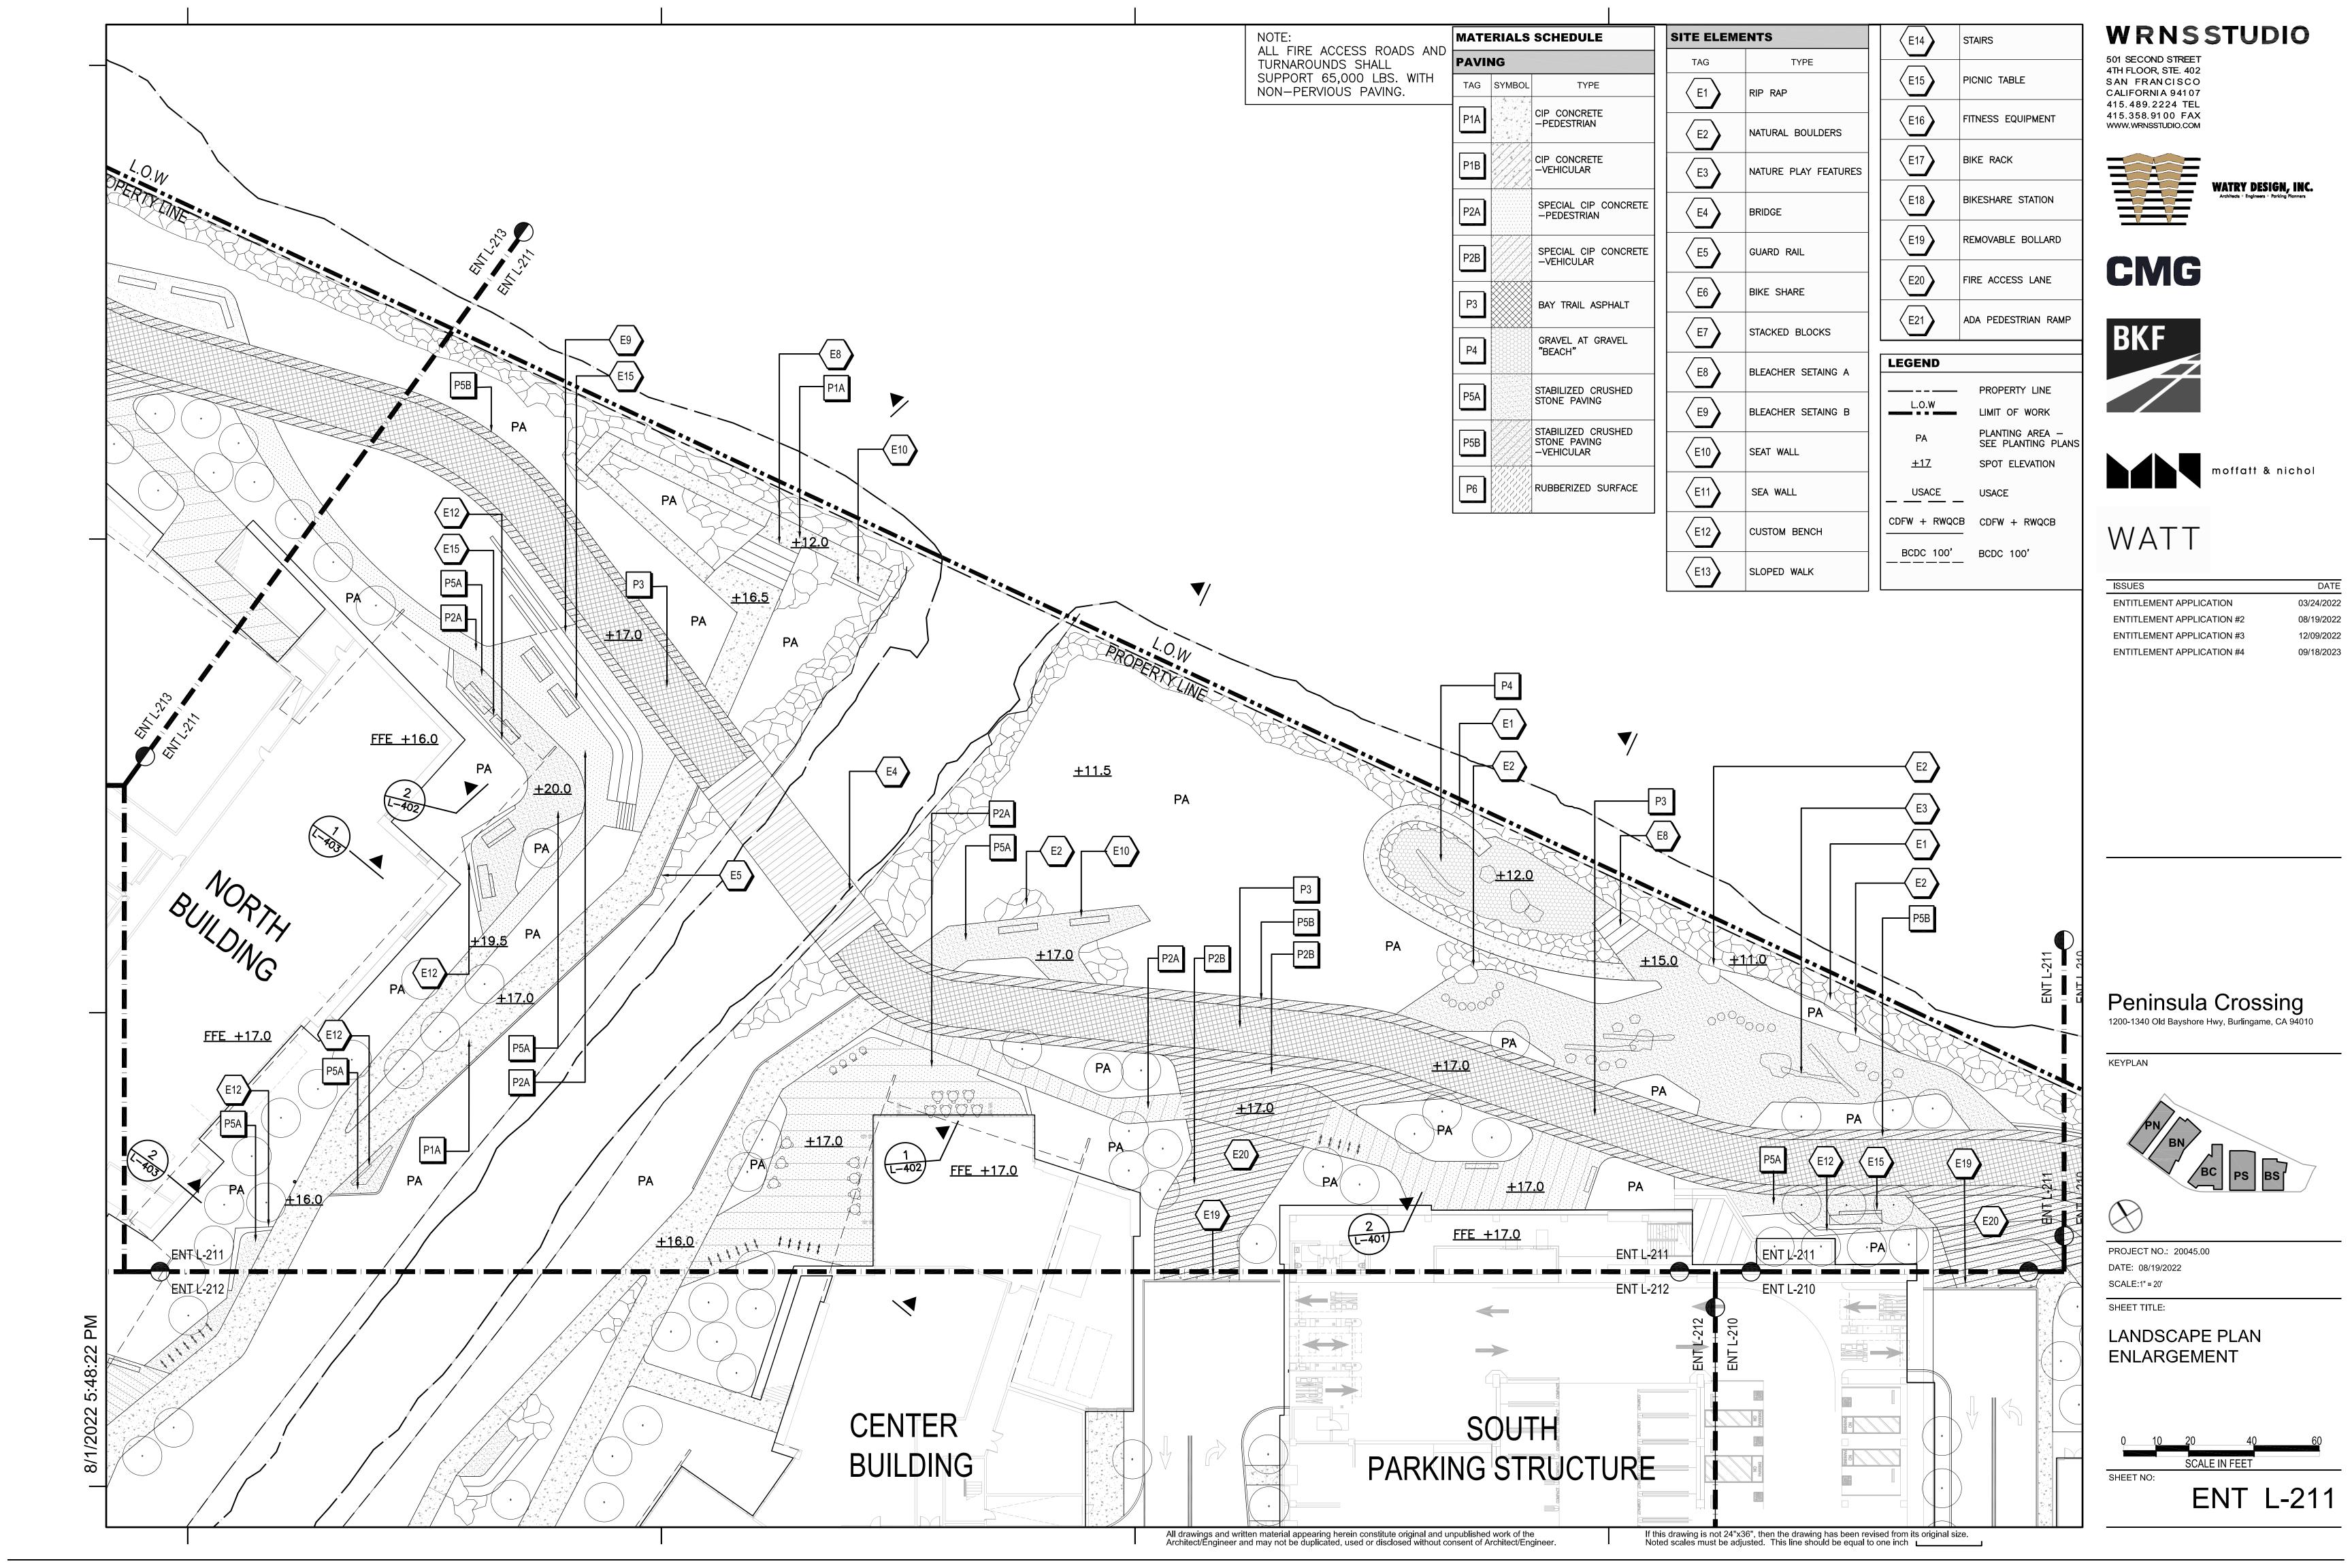

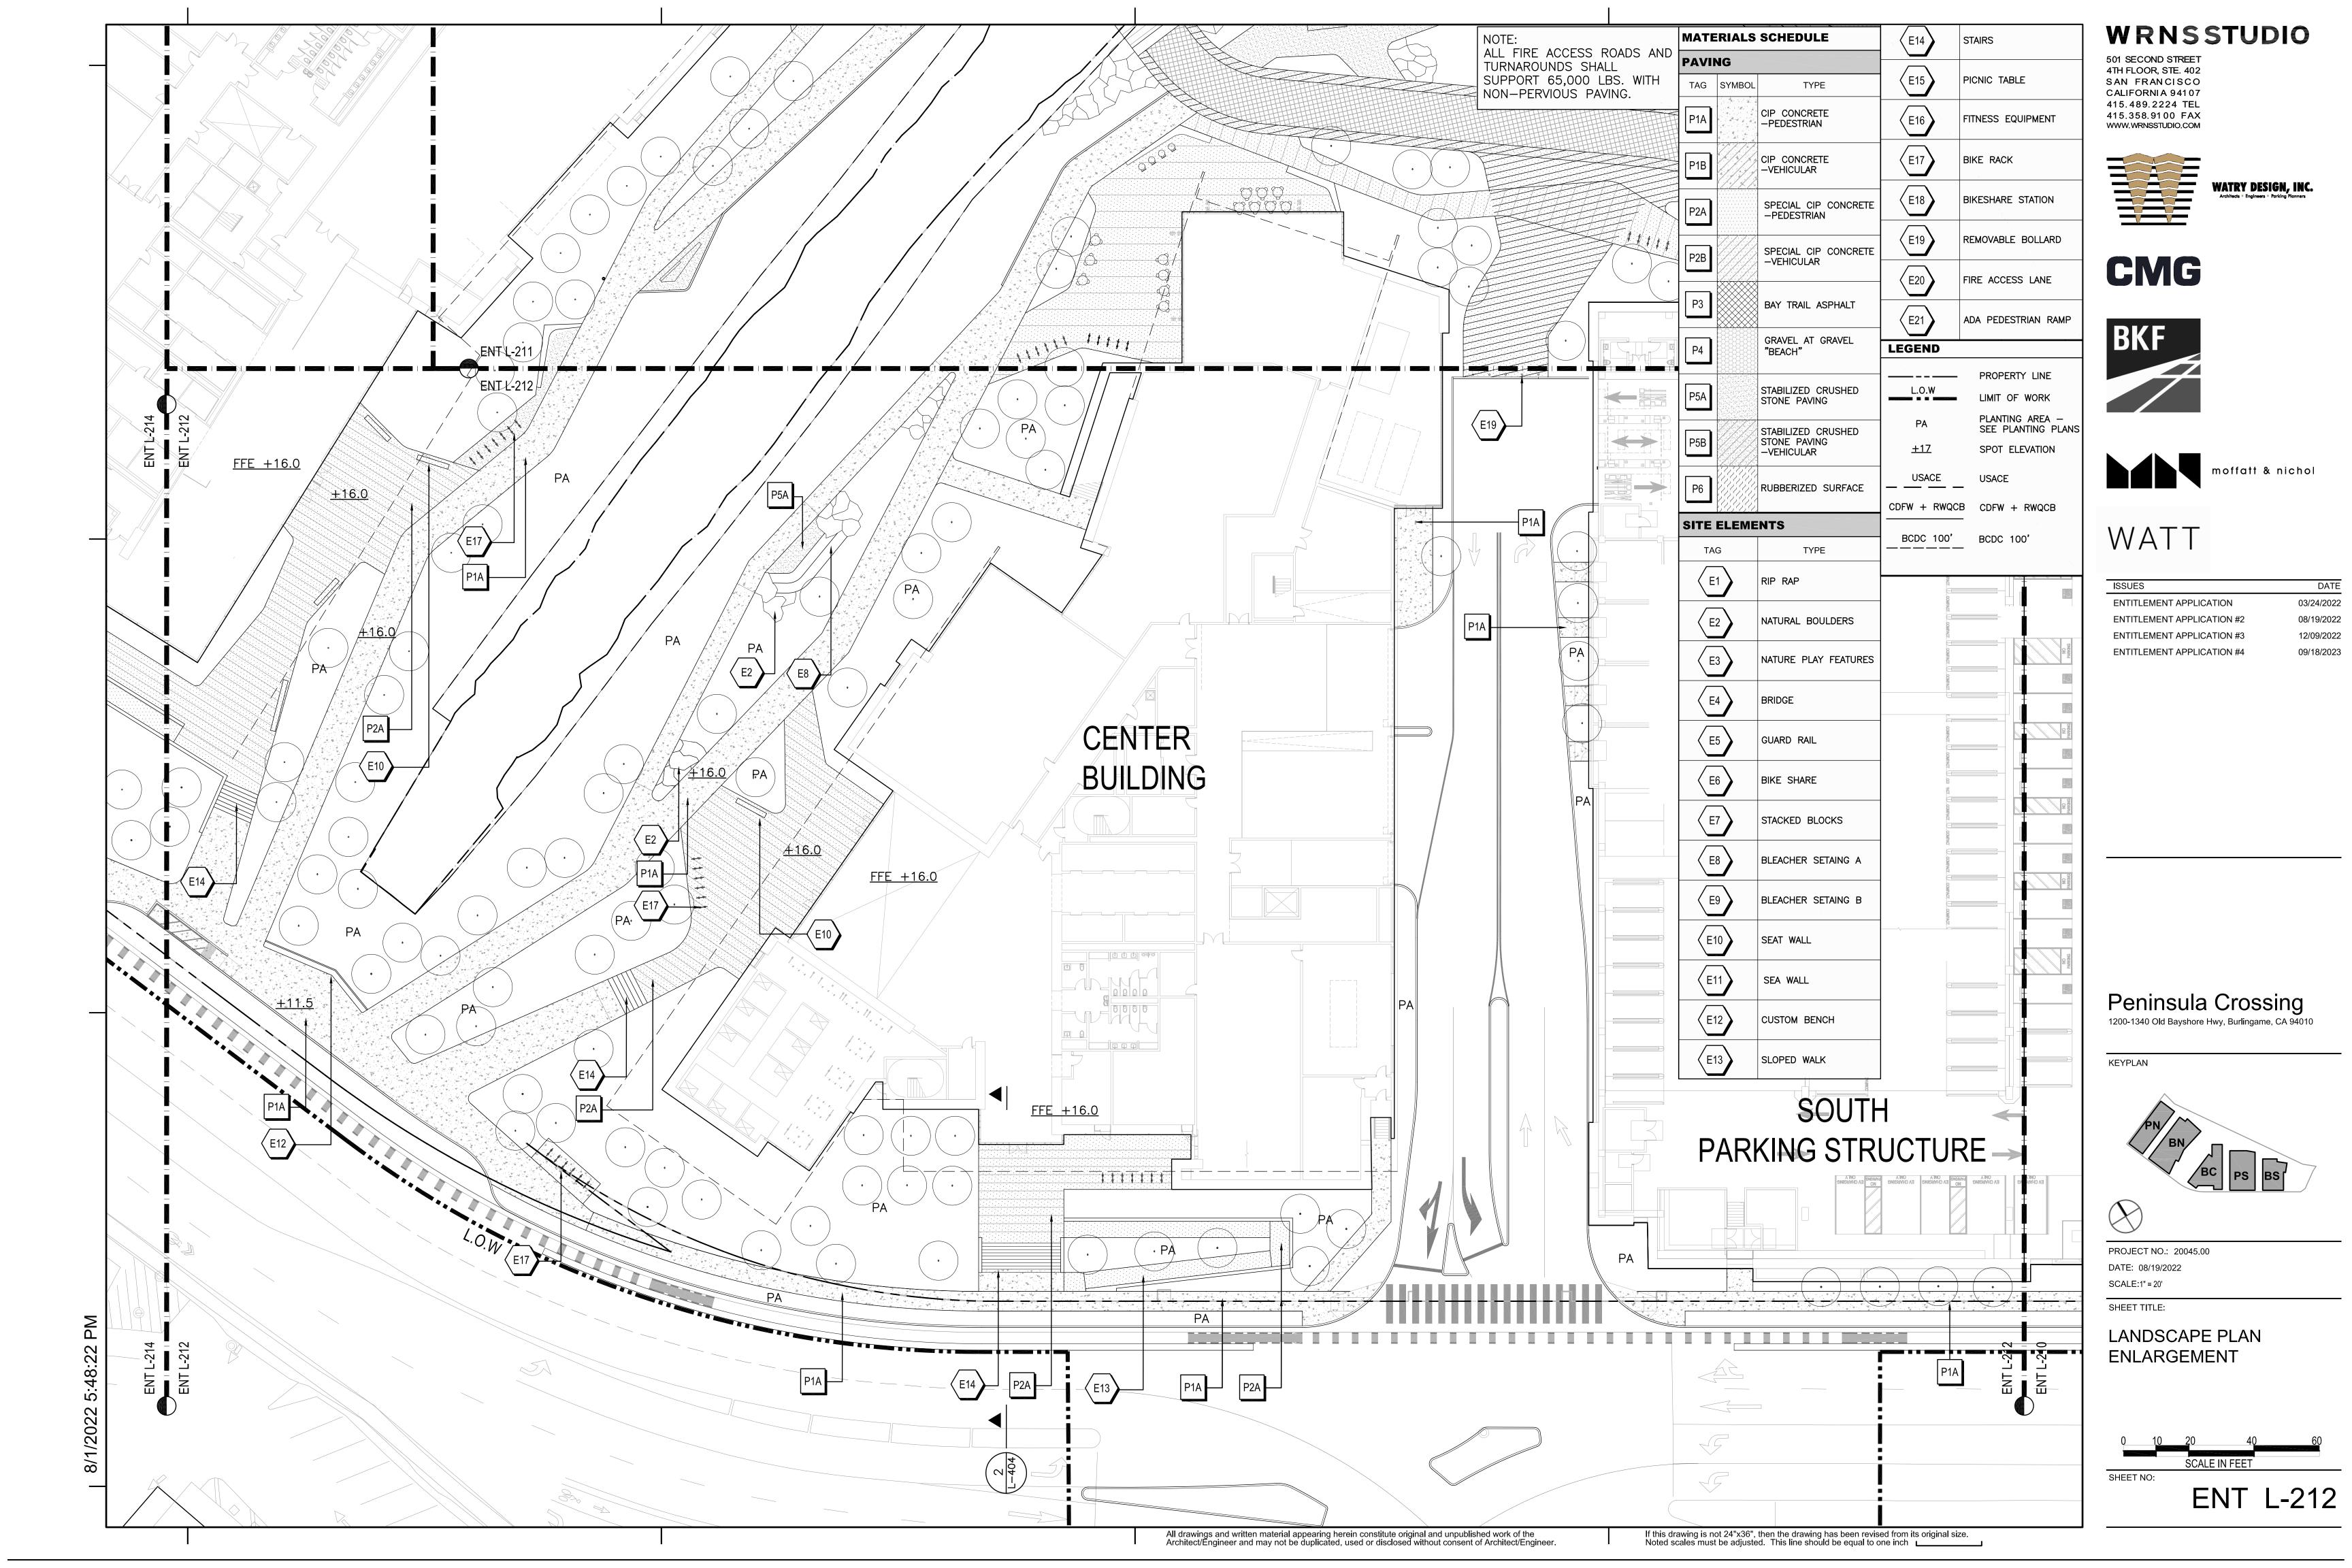

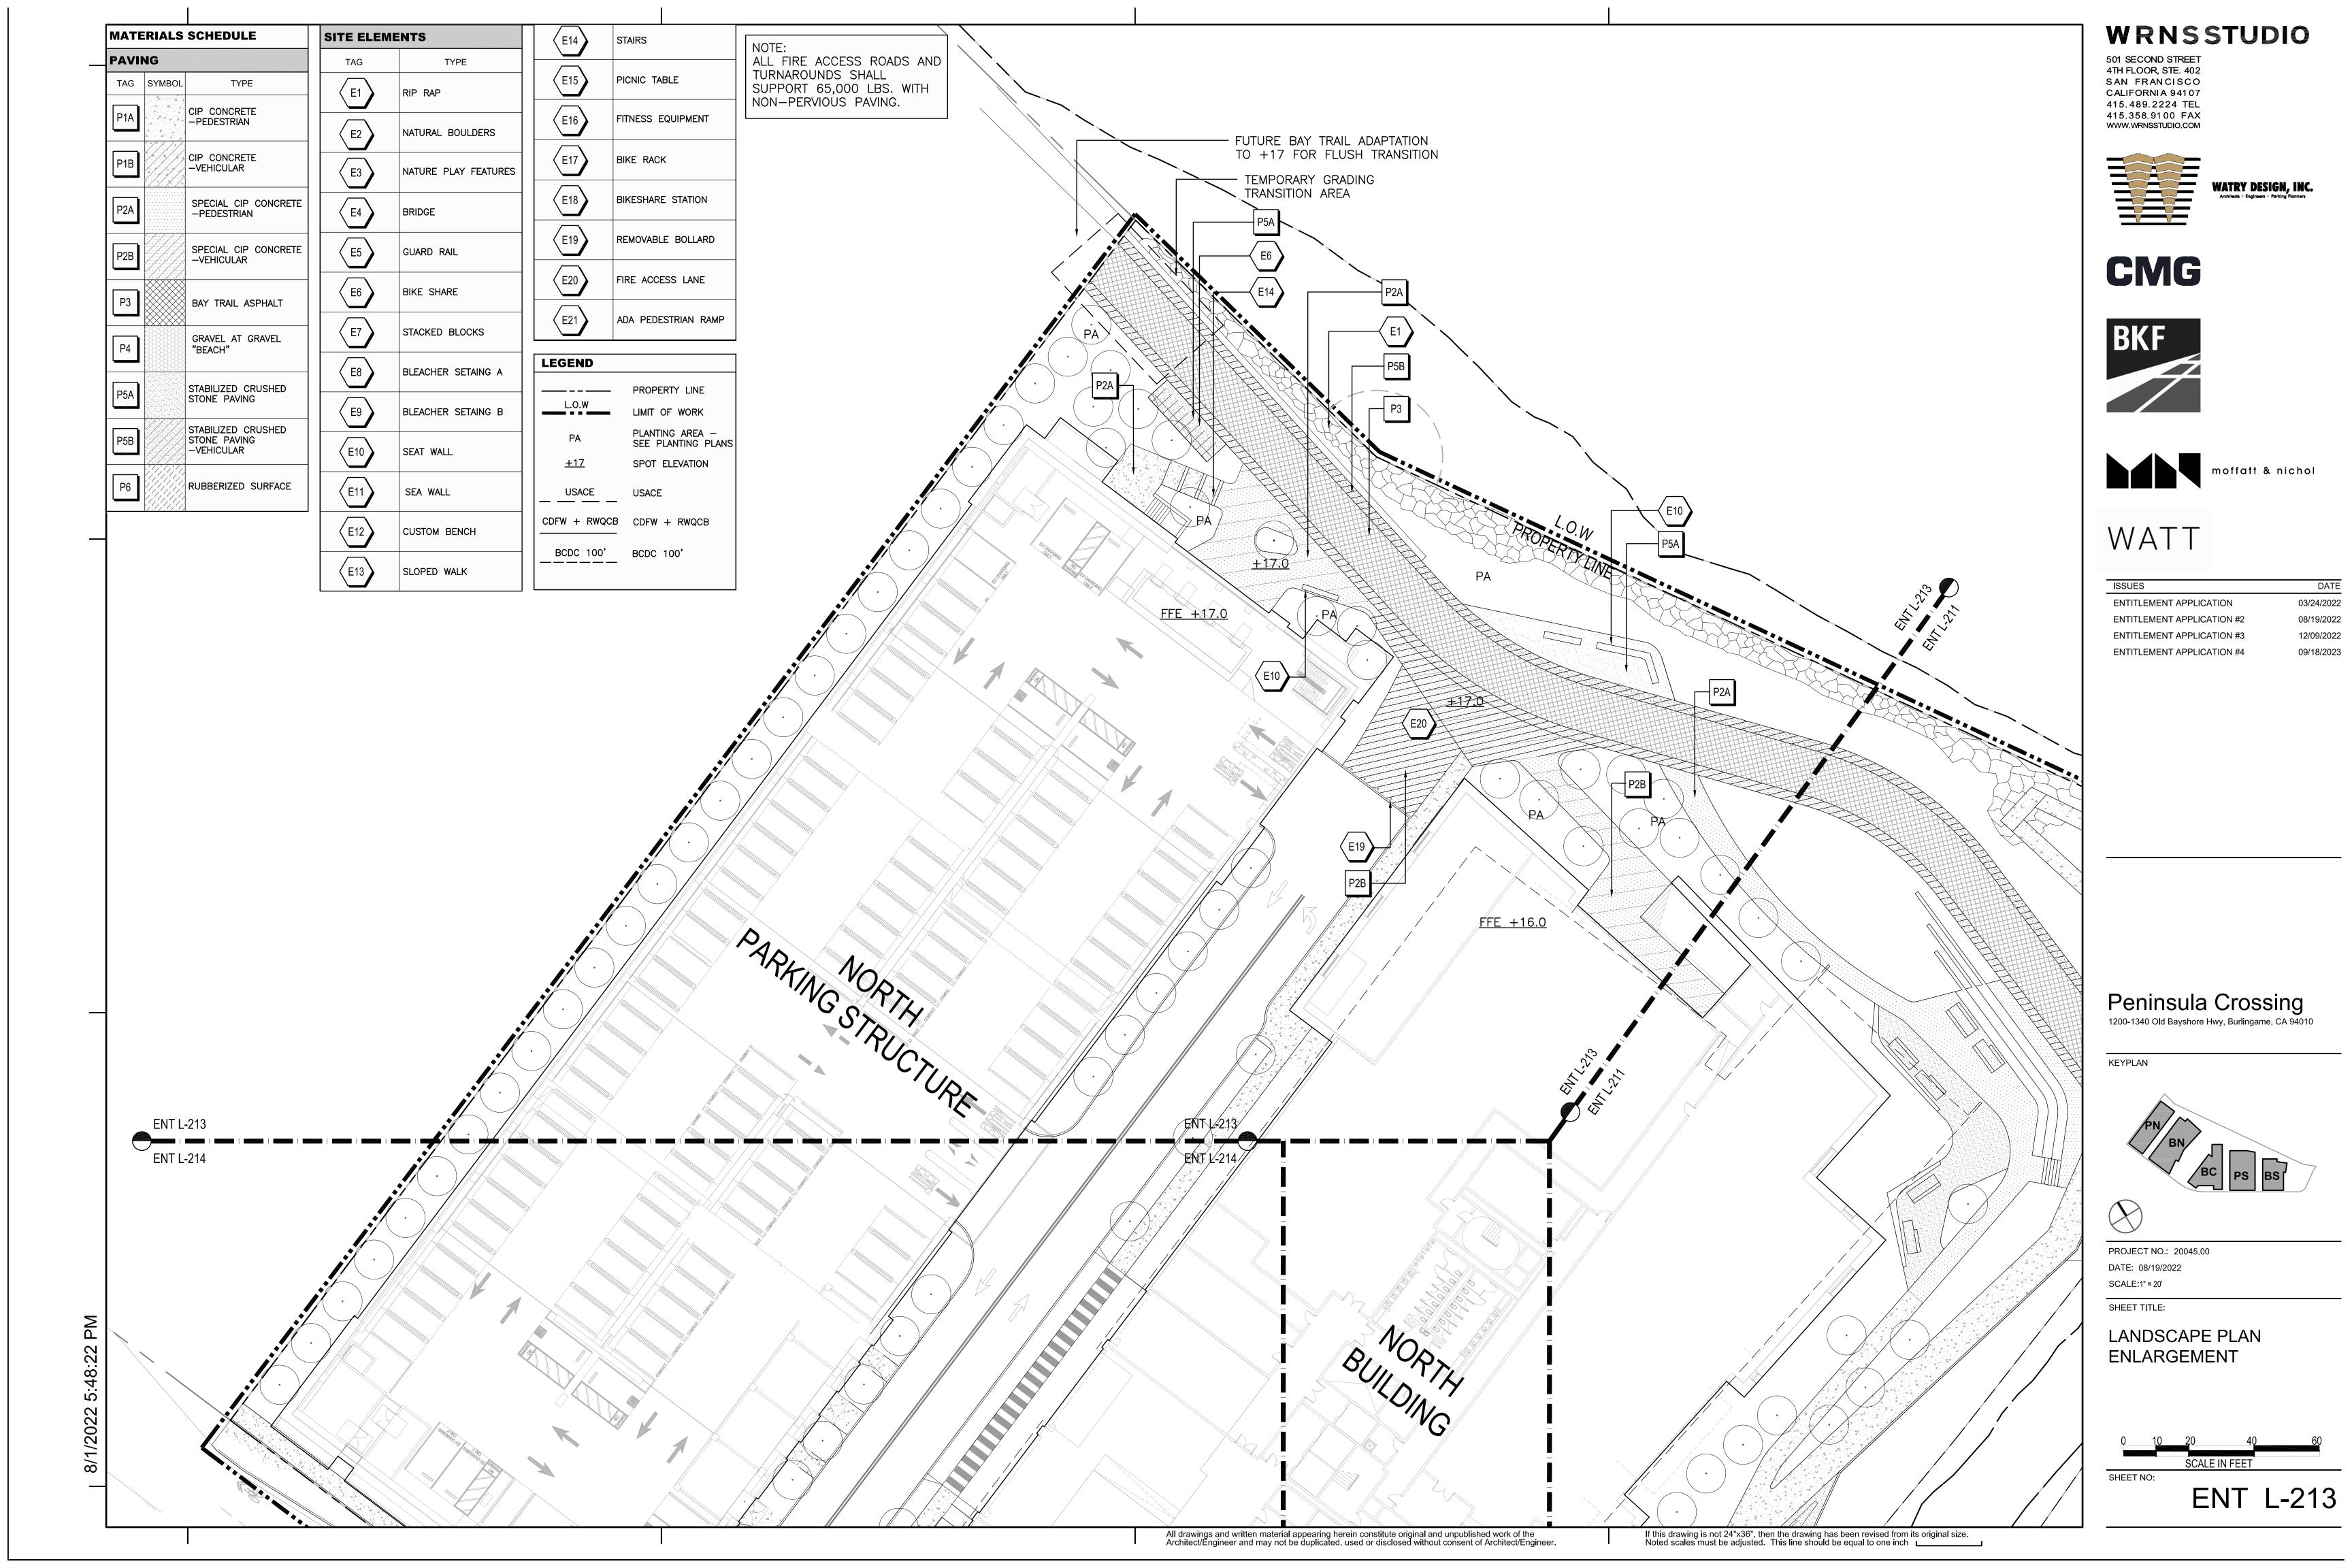

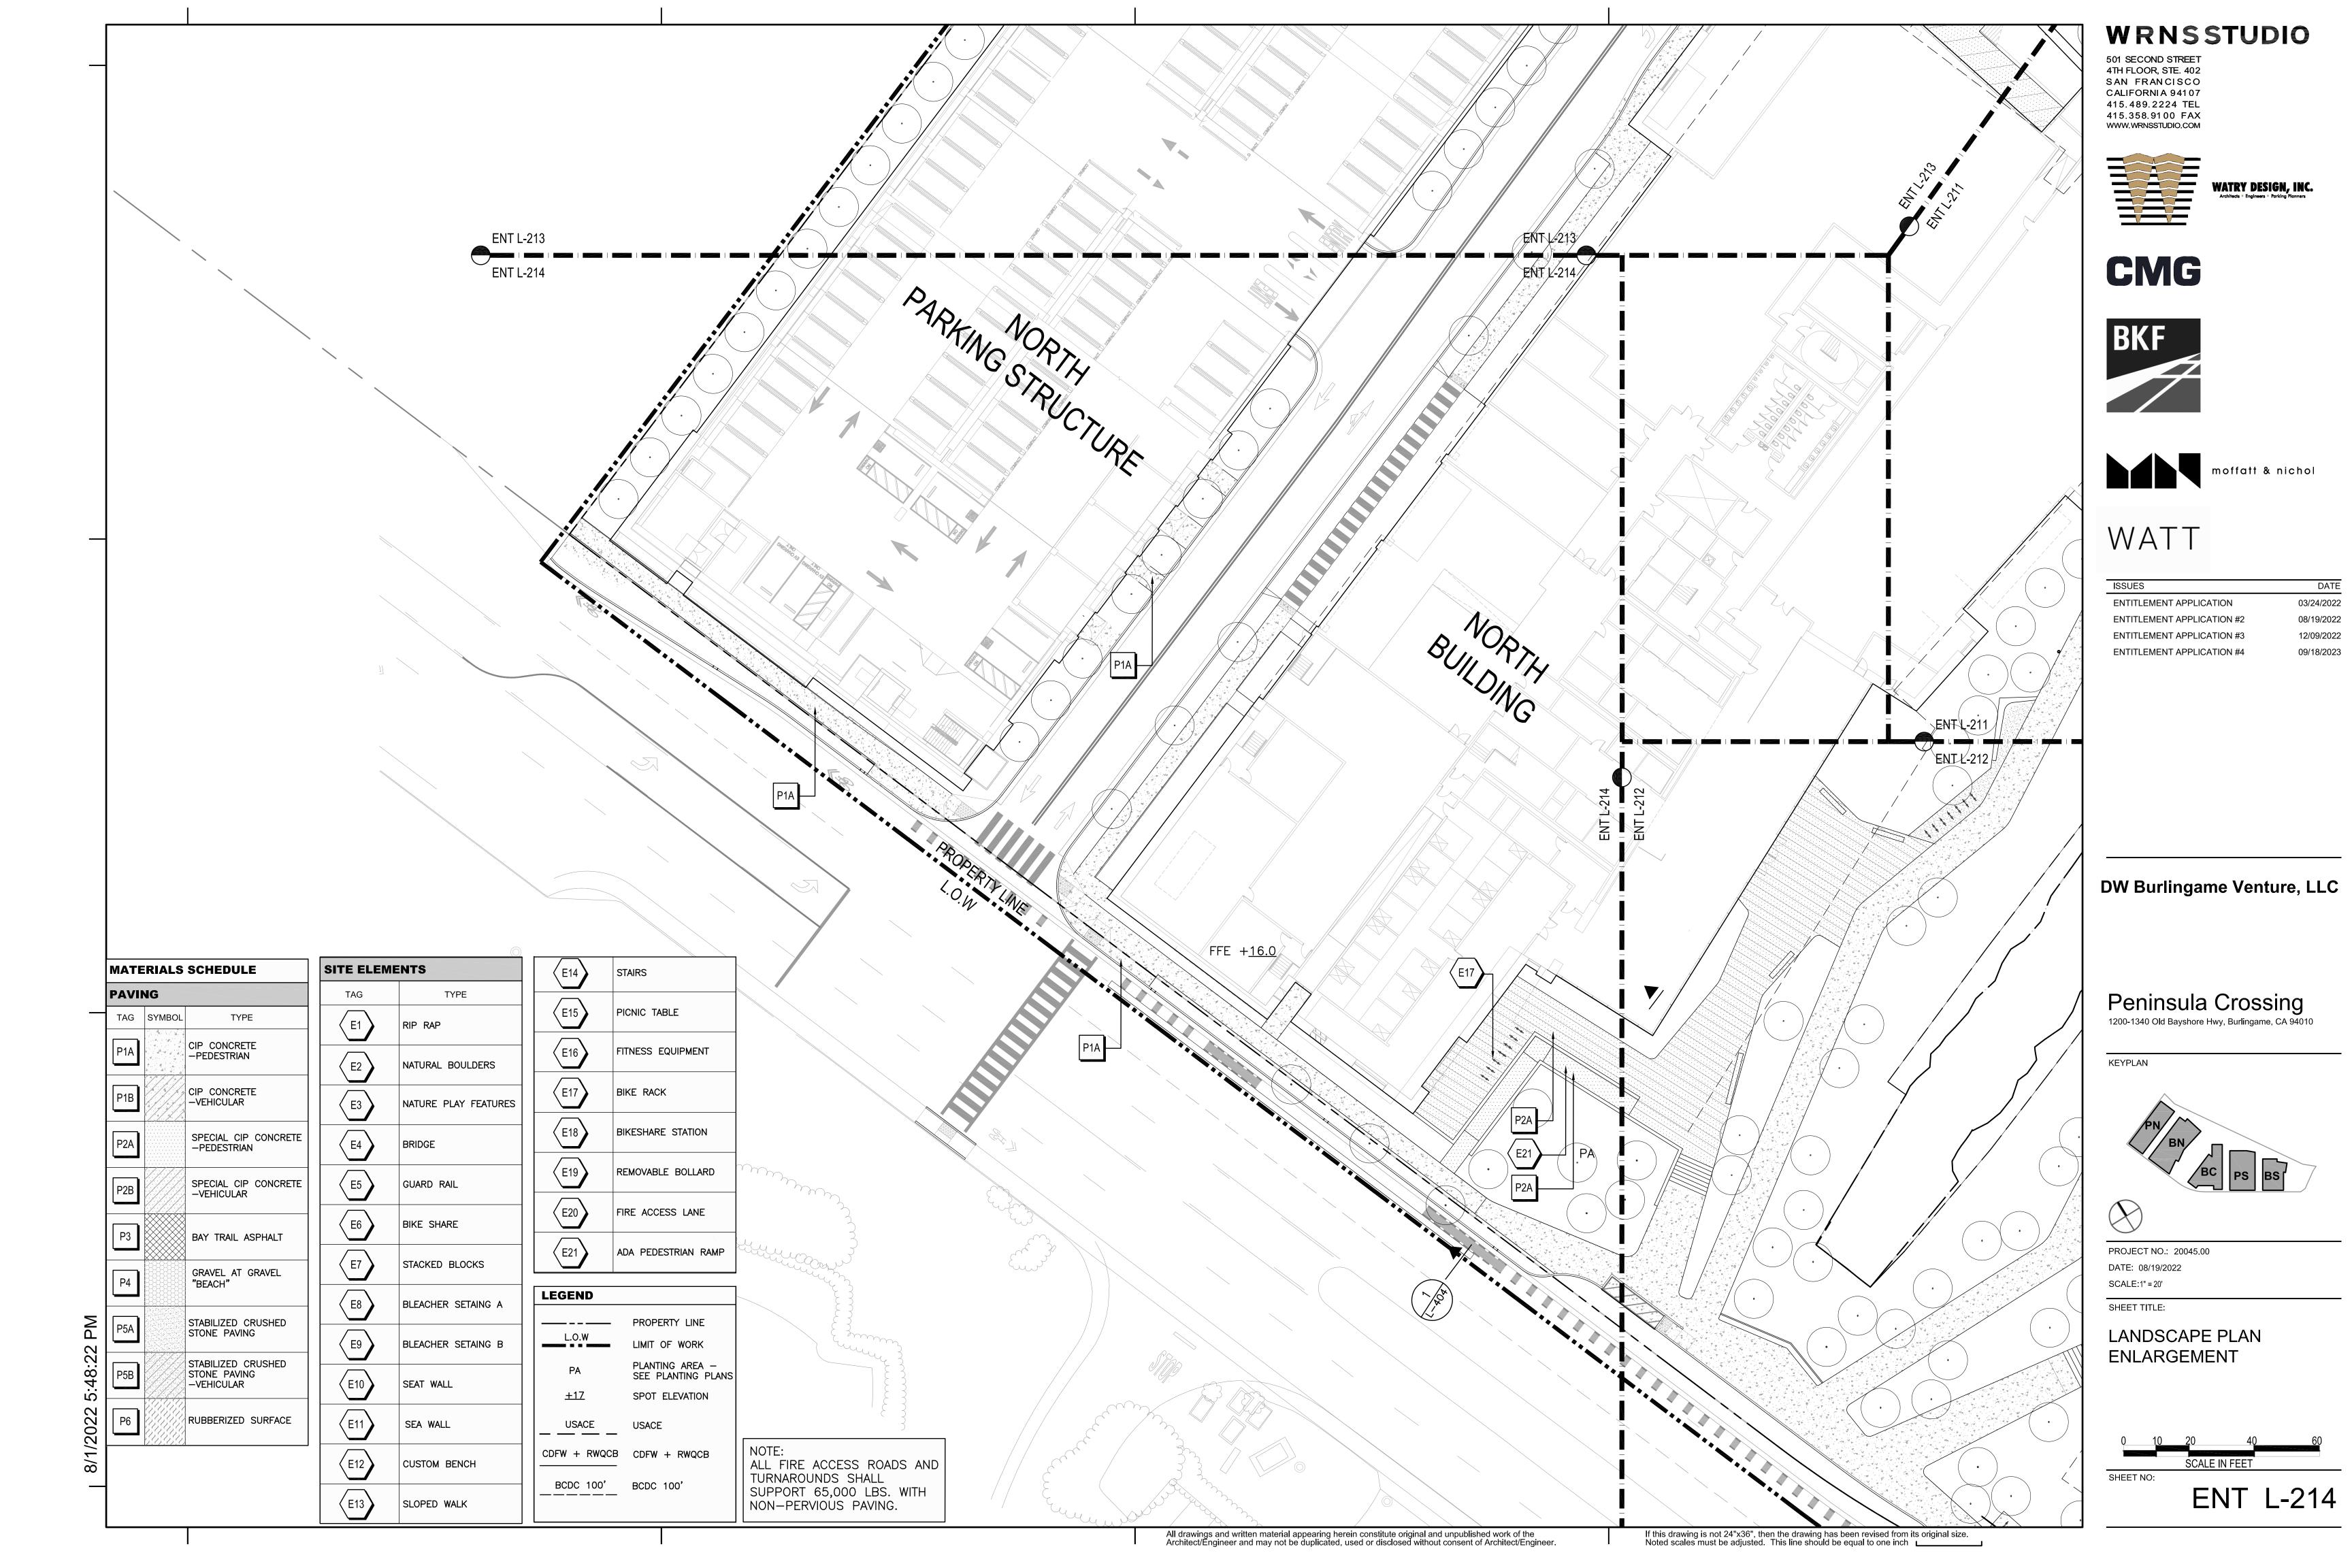

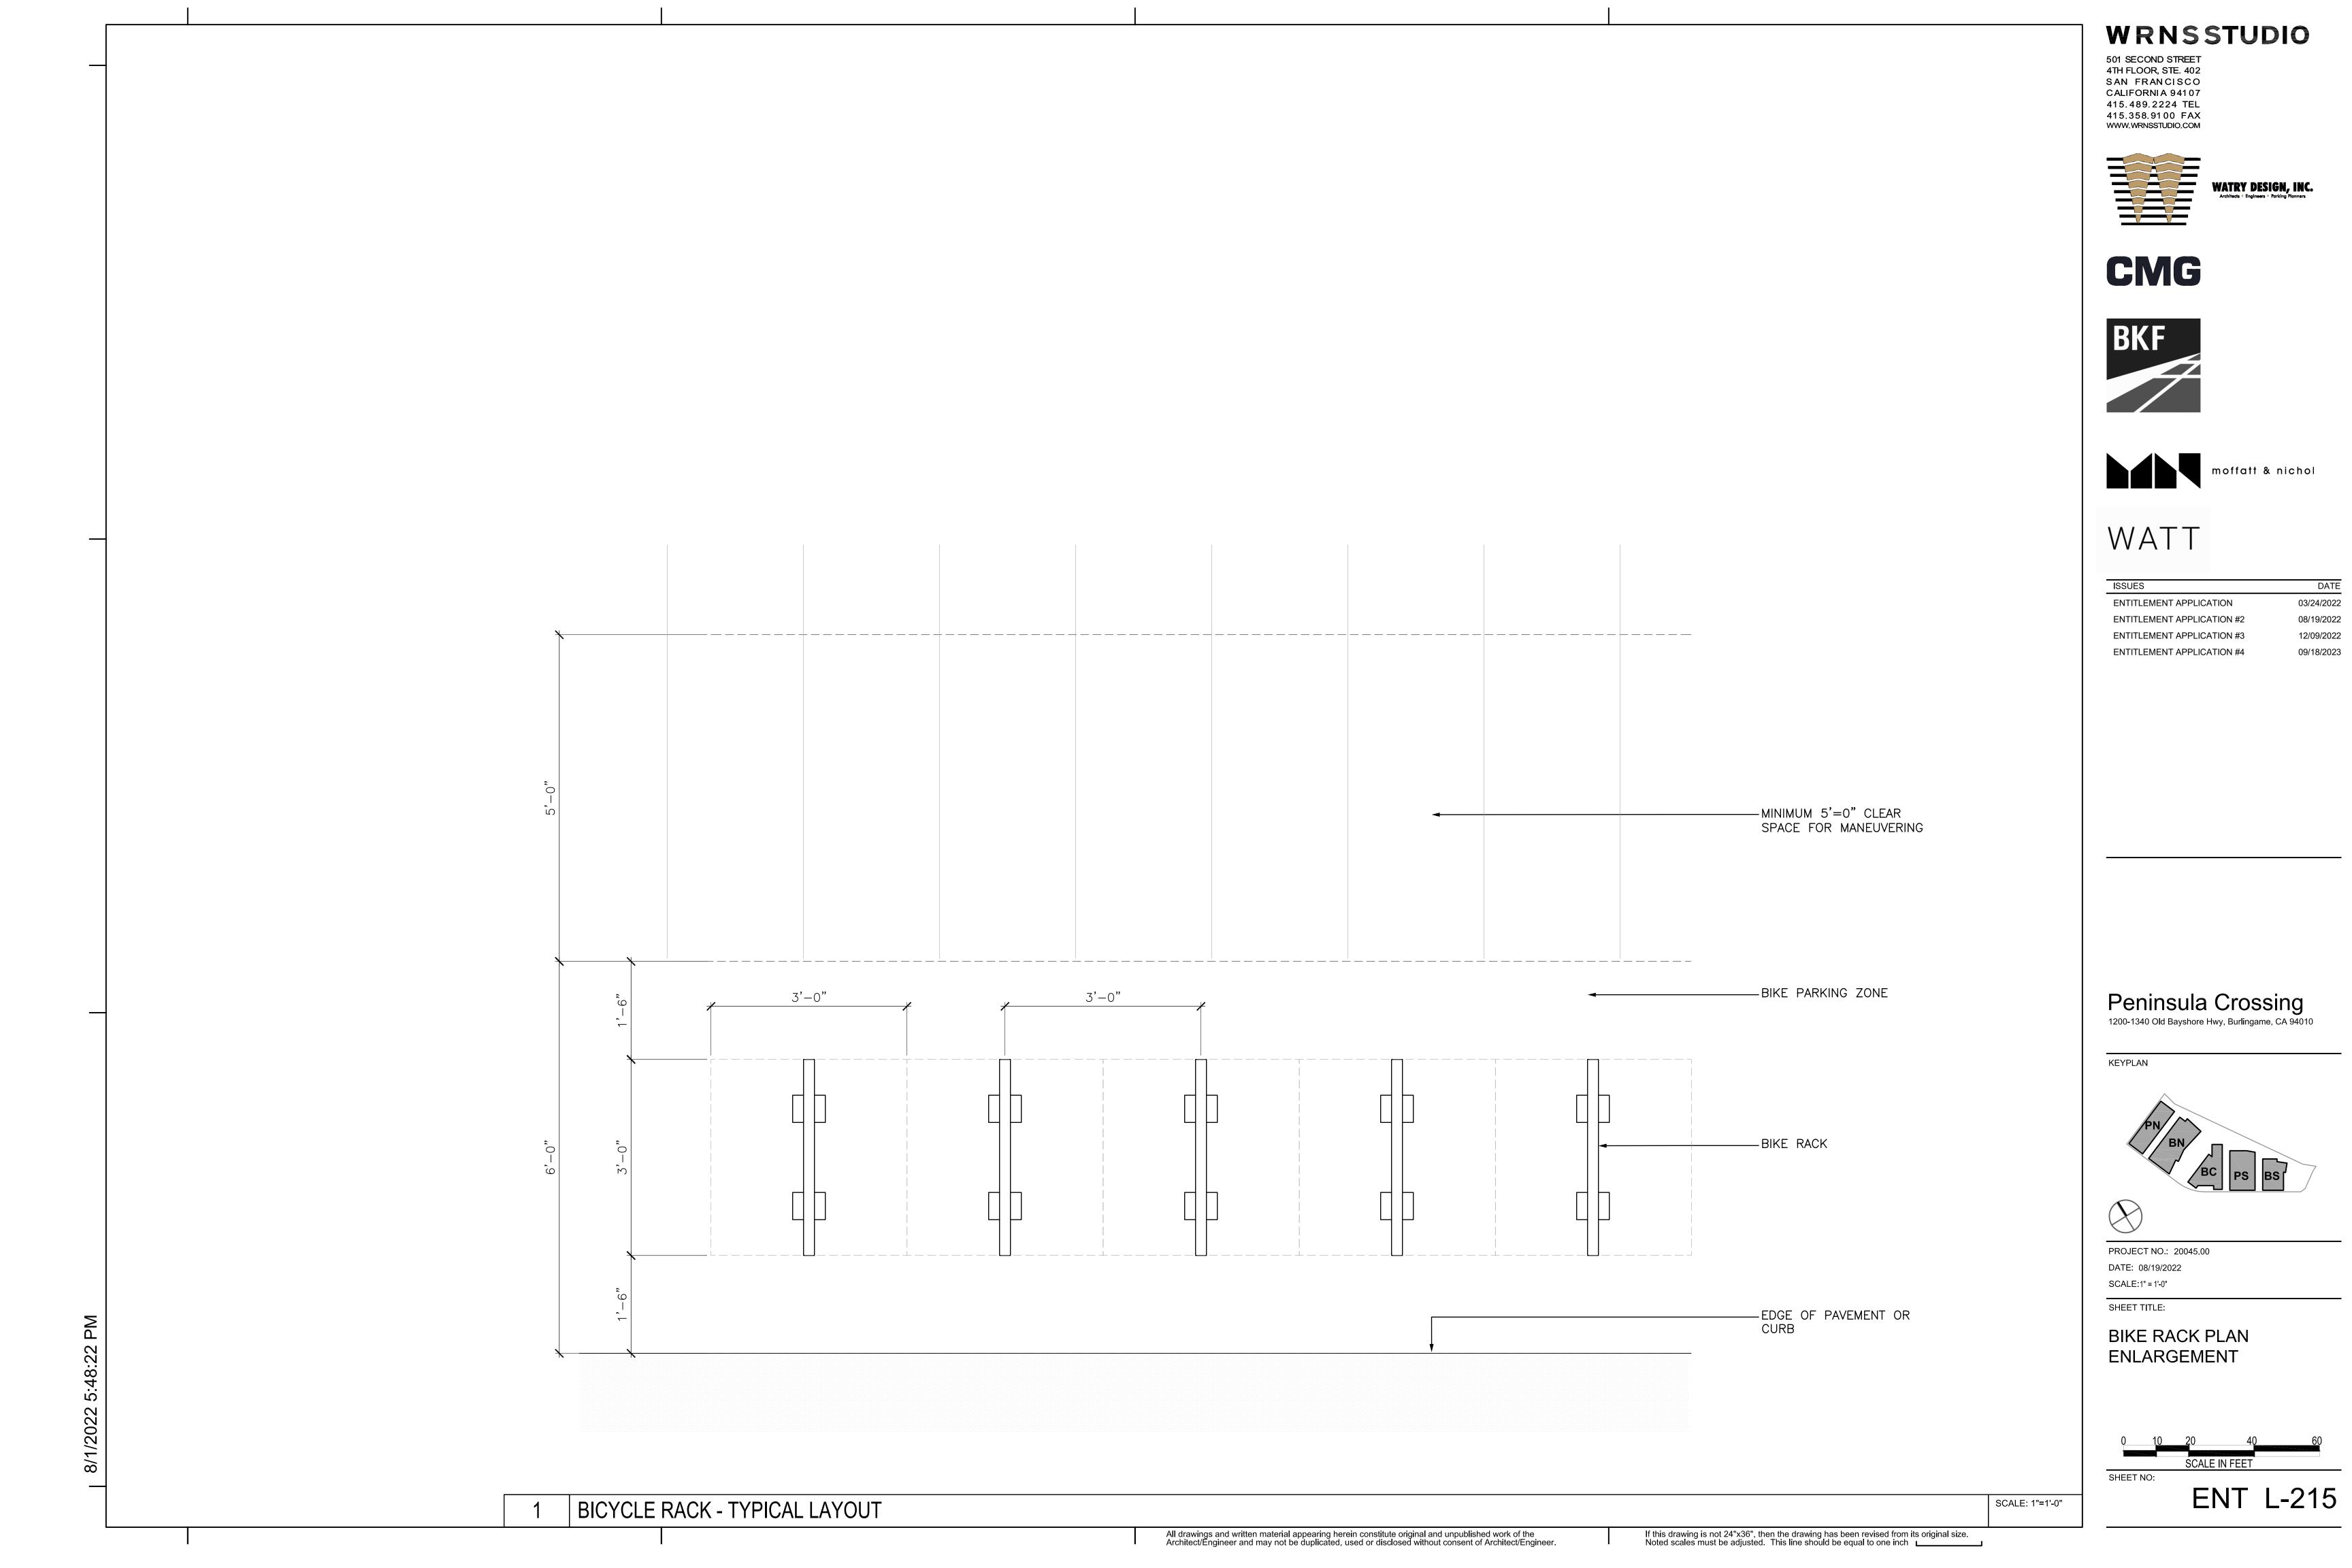

TREES	_	_	_	
SYMBOL	LATIN NAME	COMMON NAME	QTY.	SIZE
AES CAL [•] 24	AESCULUS CALIFORNICA	CALIFORNIA BUCKEYE	3	24" BOX
ALN RHO [•] 24	ALNUS RHOMBIFOLIA	WHITE ALDER	15	24" BOX
ARB MAR [•] 24	ARBUTUS MARINA	STRAWBERRY TREE	16	24" BOX
CER OCC [•] 24	CERCUS OCCIDENTALIS	WESTERN REDBUD	6	24" BOX
LOP CON [• 24	LOPHOSTEMON CONFERTUS	BRISBANE BOX	70	24" BOX
PIS CHI	PISTACIA CHINENSIS 'KIETH DAVEY'	CHINESE PISTACHE	17	24" BOX
24			2	36" BOX
PLA ACE [•] 36	PLATANUS X ACERIFOLIA 'COLUMBIA'	COLUMBIA LONDON PLANE TREE	6	36" BOX
QUE AGR	QUERCUS AGRIFOLIA	COAST LIVE OAK	13	24" BOX
24			12	36" BOX
QUE VIR	QUERCUS VIRGINIANA	SOUTHERN LIVE OAK	29	24" BOX
24			6	36" BOX

TREE PLANTING NOTES

- BIRD-SAFE DESIGN: FRUITING TREES AND SHRUBS THAT ATTRACT BIRDS SHALL BE KEPT CLEAR OF BUILDING EDGES AND GLAZING. LANDSCAPE ARCHITECT SHALL CONSULT WITH ECOLOGIST PRIOR TO FINALIZING PLANTING PLAN TO ASSURE BIRD-SAFE DESIGN.
- . ALL SITE TREES SHALL HAVE SUBDRAINAGE UNLESS OTHERWISE NOTED BY LANDSCAPE FINAL TREE SELECTION AND LAYOUT SHALL BE REFINED BASED ON THE FOLLOWING
- SELECTION CRITERIA: SOILS AND HORTICULTURAL SUITABILITY
- SALT AND WIND TOLERANCE
- WATER EFFICIENT LANDSCAPE ORDINANCE (WELO) REQUIREMENTS
- ECOLOGICAL VALUE/HABITAT AND ENVIRONMENTAL CONSIDERATIONS.
- SUN & SHADE

CONCEPT	PLANT LIST			
SYMBOL	TAG	SCIENTIFIC NAME	BOTANICAL NAME	SIZE
BAYSHORE	UPLAND - CO	 ASTAL SCRUB		
		ACHILLEA MILLEFOLIUM 'SONOMA	YARROW 'SONOMA COAST'	1 GAL
		COAST' ARMERIA MARITIMA	THRIFT SEAPINK	1 GAL
		ARTEMISIA CALIFORNICA	CALIFORNIA SAGEBRUSH	1 GAL
P	P1-01	BACCHARIS PILULARIS 'PIGEON POINT'	DWARF COYOTE BUSH	1 GAL
		CEANOTHUS GRISEUS	CALIFORNIA LILAC	1 GAL
		CEANOTHUS THYRSIFLORUS REPENS	CREEPING BLUE BLOSSOM	1 GAL
		ERIOGONUM LATIFOLIUM	SEASIDE BUCKWHEAT	1 GAL
		ERIOGONUM NUDUM	NUDE BUCKWHEAT	1 GAL
		ERIGERON GLAUCUS	SEASIDE SEASIDE DAISY	1 GAL
		ESCHSCHOLZIA CALIFORNICA	CALIFORNIA POPPY	1 GAL
		FRANGULA CALIFORNICA	COFFEEBERRY	5 GAL
		LUPINUS ALBIFRONS	SILVER LUPINE	1 GAL
		MIMULUS AURANTIACUS	STICKY MONKEYFLOWER	1 GAL
		MYRICA CALIFORNICA	PACIFIC WAX MYRTLE	15 GAL
		MUHLENBERGIA RIGENS	DEERGRASS	1 GAL
		STIPA PULCHRA	PURPLE NEEDLE GRASS	1 GAL
		SISYRINCHIUM BELLUM	BLUE-EYED GRASS	1 GAL
EASTON CF	REEK UPLAND			
		ARCHTOSTAPHYLOS 'POINT REYES'	POINT REYES MANZANITA	1 GAL
		CALAMAGROSTIS FOLIOSA	MENDOCINO REED GRASS	1 GAL
	P1-02	CEANOTHUS THYRSIFLORUS REPENS	PROSTRATE BLUE BLOSSOM	1 GAL
		CEANOTHUS THYRSIFLORUS REPENS	PROSTRATE BLUE BLOSSOM	1 GAL
		FESTUCA CALIFORNICA	CALIFORNIA FESCUE	1 GAL
		FRANGULA CALIFORNICA	COFFEEBERRY	1 GAL
		IRIS DOUGLASIANA	DOUGLAS IRIS	1 GAL
		JUNCUS PATENS	COMMON RUSH	1 GAL
		MUHLENBERGIA RIGENS	DEER GRASS	1 GAL
		MYRICA CALIFORNICA	PACIFIC WAX MYRTLE	15 GAL
		RIBES SANGUINEUM GLUTINOSUM	PINK FLOWERING CURRANT	15 GAL
BUILDING E	EDGE PLANTING		L	I
		CEANOTHUS SPECIES	BLUE BLOSSOM	1 GAL
		CALAMAGROSTIS FOLIOSA	MENDOCINO REED GRASS	1 GAL
	P1-03	FESTUCA CALIFORNICA	CALIFORNIA FESCUE	1 GAL
		IRIS DOUGLASIANA	DOUGLAS IRIS	1 GAL
		MUHLENBERGIA RIGENS	DEER GRASS	15 GAL
BAYSHORE	HWY EDGE			I
		LOMANDRA LONGIFOLIA 'BREEZE'	DWARF MAT RUSH	1 GAL
		OLEA EUROPEA 'DWARF OLIVE'	DWARF OLIVE	1 GAL
	P1-04	WESTRINGIA FRUTICOSA 'MUNDI'	LOW COAST ROSEMARY	1 GAL
STREETCA	PE			1 GAL
		LOMANDRA LONGIFOLIA 'BREEZE'	DWARF MAT RUSH	1 GAL
	P1-05	SALVIA CLEVLANDII	CLEVLAND SAGE	5 GAL
TURF GRAS	 SS	-	1	
	P1-06	TURF GRASS	TURF GRASS	SOD
,,,,,,,,,,,,,,,,,,,,,,,,,,,,,,,,,,,,,,		•		I

PLANTING NOTES

- BIRD-SAFE DESIGN: FRUTING TREES AND SHRUBS THAT ATTRACT BIRDS SHALL BE KEPT CLEAR OF BUILDING EDGES AND GLAZING. LANDSCAPE ARCHITECT SHALL CONSULT WITH ECOLOGIST PRIOR TO FINALIZING PLANTING PLANS TO ASSURE BIRD-SAFE DESIGN.
- 2. FINAL PLANT SELECTION AND LAYOUT SHALL BE REFINED BASED ON THE FOLLOWING SELECTION CRITERIA:
 - SOILS AND HORTICULTURAL SUITABILITY
 - SALT AND WIND TOLERANCE
 - WATER EFFICIENT LANDSCAPE ORDINANCE (WELO) REQUIREMENTS
 - AESTHETIC QUALITY
- ECOLOGICAL VALUE/HABITAT AND ENVIRONMENTAL CONSIDERATIONS, INCLUDING ADJACENT CREEK AND WETLAND HABITAT
- F) SUN & SHADE

WATER EFFICIENT LANDSCAPING ORDINANCE (WELO)

- PER CODE SECTION 25.36.020, THE PLANTING DESIGN CONFORMS TO CHAPTER 18.17 OF THE MUNICIPAL CODE AND THE CALIFORNIA CODE OF REGULATIONS SECTIONS 490,495, CHAPTER 2.7, DIVISION 2 TITLE 23 MODEL WATER-EFFICIENT LANDSCAPE ORDINANCE.
- 2. ALL LANDSCAPE PLANTING AREAS SHALL INCLUDE A 3 INCH MINIMUM LAYER OF MULCH. 3. PROVIDE DRIP IRRIGATION TO ALL PLANTING AREAS. PROVIDE COPPER SUPPLY LINES AND CONTROL WIRE CONDUIT TO EACH PLANTER.

LANDSCAPING NOTES

- 1. PER CODE SECTION 25.36.020 LANDSCAPE AREAS SHALL PRIMARILY CONSIST OF GRASS, ANNUALS, PERENNIALS, GROUNDCOVER, SHRUBS, TREES AND OTHER LIVING VEGETATION.
- 2. ARTIFICIAL TURF IS NOT USED.
- 3. PER CODE SECTION 25.36.020 "LANDSCAPE COVERAGE REQUIREMENTS FOR COMMERCIAL INDUSTRIAL, AND MIXED USE ZONES": SHRUBS, GROUNDCOVER, AND OTHER PLANT MATERIAL SHALL COVER ALL AREAS NOT OCCUPIED BY STRUCTURES, PARKING AREAS, STORAGE, TRASH ENCLOSURES, DRIVEWAYS, AND SIDEWALKS, AND OTHER PEDESTRIAN AREAS.
- 4. PER CODE SECTION 25.36.020 "LANDSCAPE IRRIGATION AND MAINTENANCE" THE PROPERTY OWNER SHALL MAINTAIN RETAINING WALLS, CRIBBING, DRAINAGE STRUCTURES, PLANTED SLOPES, AND OTHER PROTECTIVE DEVICES IN GOOD CONDITION AND REPAIR AT ALL TIMES.

IRRIGATION NOTES

- 1. Primary irrigation for all planting areas will be sub-surface drip or bubbler based irrigation, with drip tubes at 18-inches on center.
- 2. Secondary microspray at select planting areas.
- 3. Spray or Rotor irrigation in no-mow turf area only.
- 4. Moisture sensors shall be provided in each planting zone/micro-climate.
- 5. Provide quick couplers at every 100 feet of mainline
- 6. Locate controllers in mechanical rooms.
- 7. Location of valves and other components shall be consolidated and to reduce visual impact. 8. PVC lateral pipes will serve the sub—surface system from copper mainline(s) from the building.
- 9. Coordinate irrigation penetrations with MEP and Waterproofing engineers.

SOIL NOTES


- 1. ALL ON-GRADE PLANTING AREAS SHALL HAVE MINIMUM 12" DEPTH OF IMPORTED HORTICULTURAL TOPSOIL.
- 2. ALL ON-STRUCTURE GROUNDCOVER PLANTING SHALL HAVE 12-24" DEPTH OF IMPORTED SOIL MIX ENGINEERED FOR ON STRUCTURE
- 3. TREE PLANTING ON GRADE SHALL HAVE AMENDED SOIL FOR MINIMUM 10 SQUARE FEET AT THE DEPTH OF THE TREE BOX.

LANDSCAPING COVERAGE REQUIREMENTS

TOTAL SITE-


TOTAL SITE:				
	LANDSCAPING DEFINITION	ALLOWED/REQUIRED	LANDSCAPING PROVIDED	COMPLIANT?
TOTAL SITE:	PER C.S. 25.36.020(B) LANDSCAPING CONSISTS "PRIMARILY OF GRASS, ANNUALS, PERENNIALS, GROUNDCOVER, SHRUBS, TREES, AND OTHER LIVING VEGETATION." THERE IS NO ARTIVICIAL TURF IN THIS PROPOSED PLAN.	20% OF TOTAL SITE AREA WITHIIN PROPERTY LINE SHALL BE LANDSCAPING.	SITE AREA: 523,775 sq. ft. LANDSCAPING IN SITE AREA: 137,553 sq ft.	YES 26.2% LANDSCAPE COVERAGE

LANDSCAPE COVERAGE

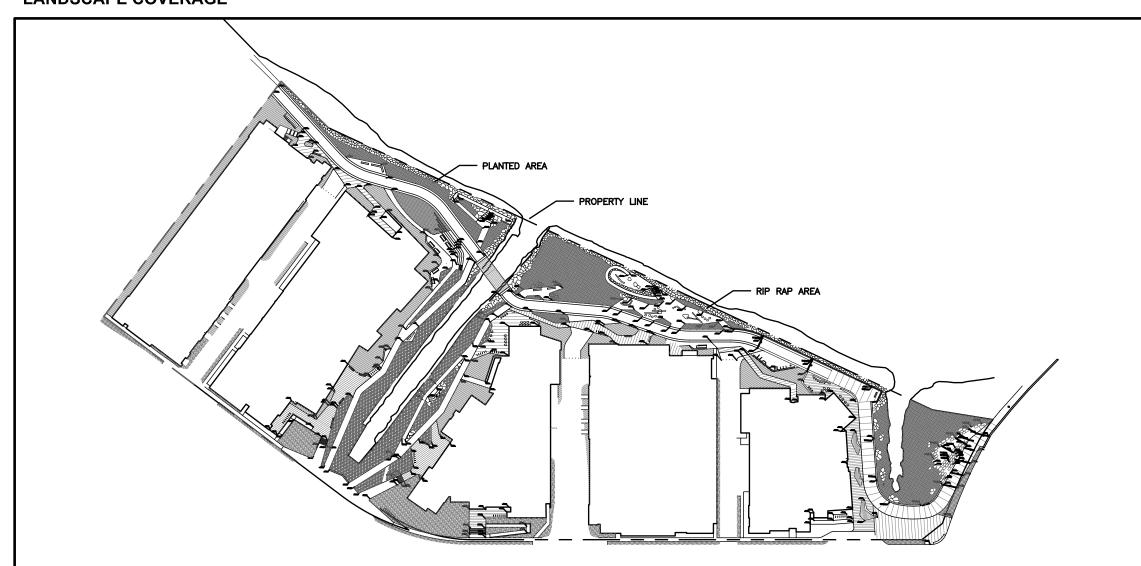

WRNSSTUDIO

501 SECOND STREET 4TH FLOOR, STE. 402 SAN FRANCISCO CALIFORNIA 94107 415.489.2224 TEL 415.358.9100 FAX WWW.WRNSSTUDIO.COM

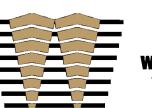



CMG










ISSUES	DATE
ENTITLEMENT APPLICATION	03/24/2022
ENTITLEMENT APPLICATION #2	08/19/2022
ENTITLEMENT APPLICATION #3	12/09/2022
ENTITLEMENT APPLICATION #4	09/18/2023

DW Burlingame Venture, LLC

Peninsula Crossing 1200-1340 Old Bayshore Hwy, Burlingame, CA 94010

KEYPLAN

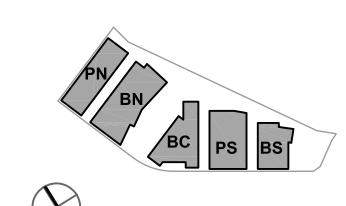


PROJECT NO.: 20045.00


DATE: 08/19/2022 SCALE: N/A


SHEET TITLE:


LANDSCAPE PLANTING SCHEDULE




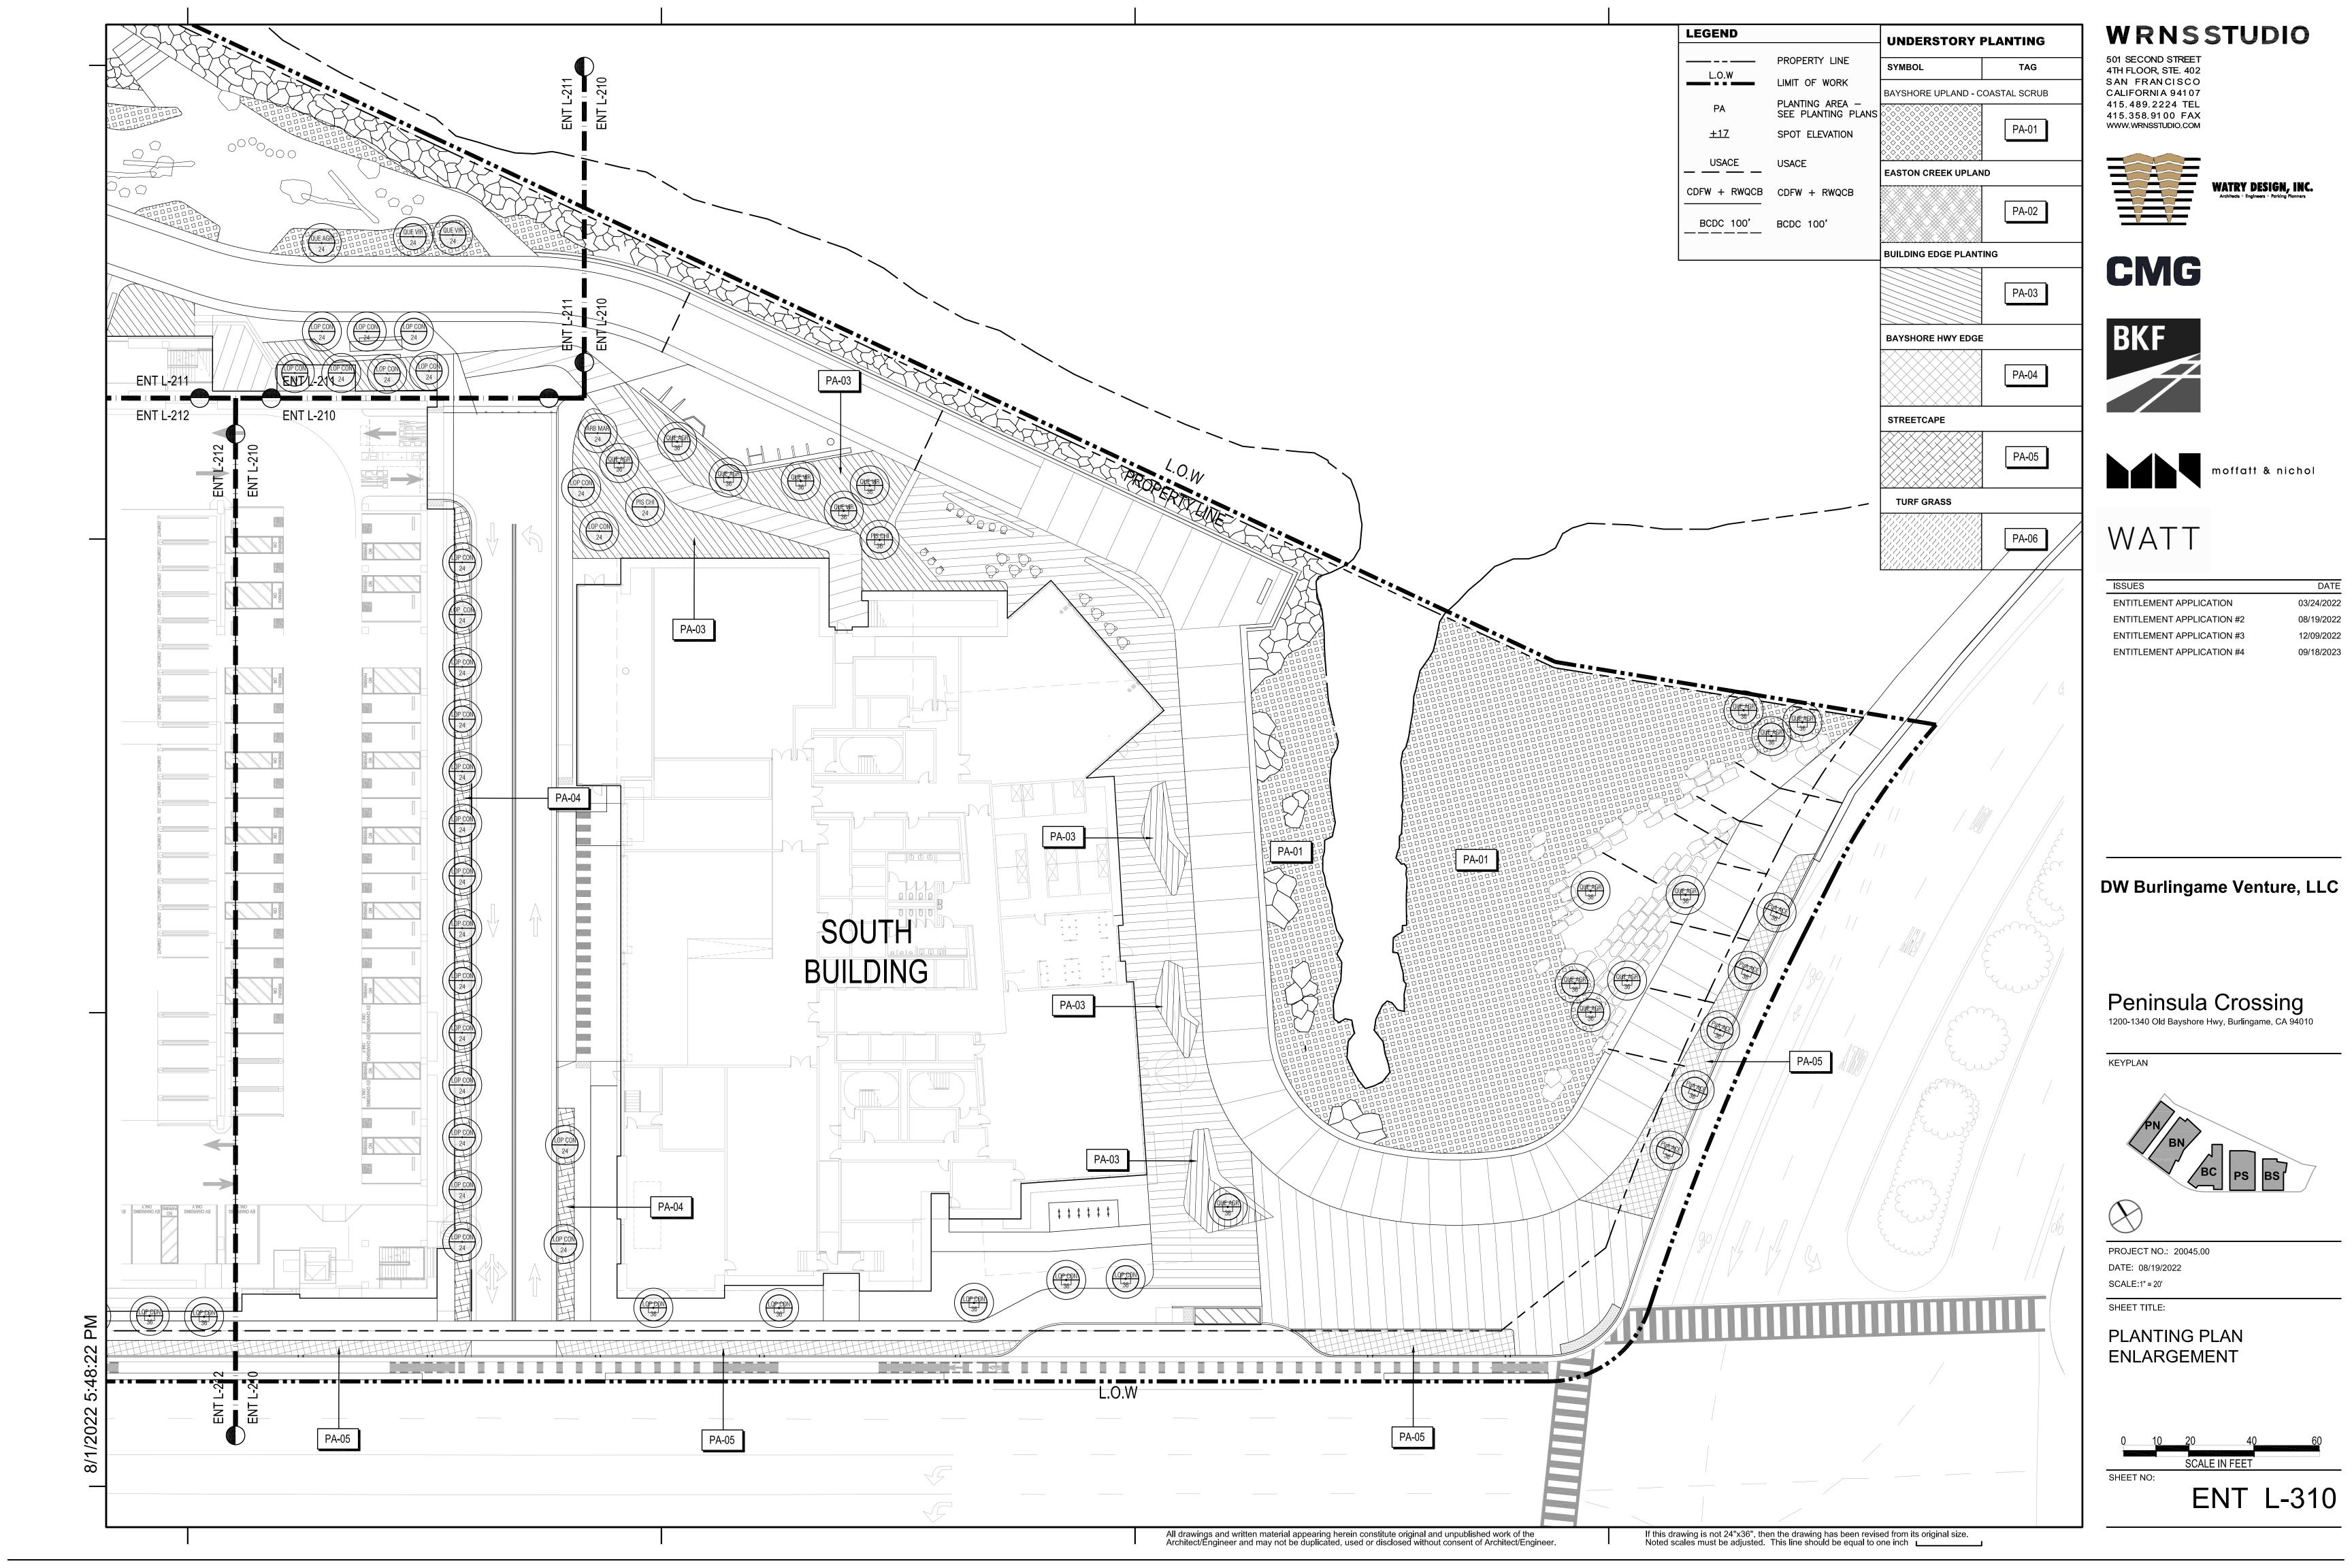


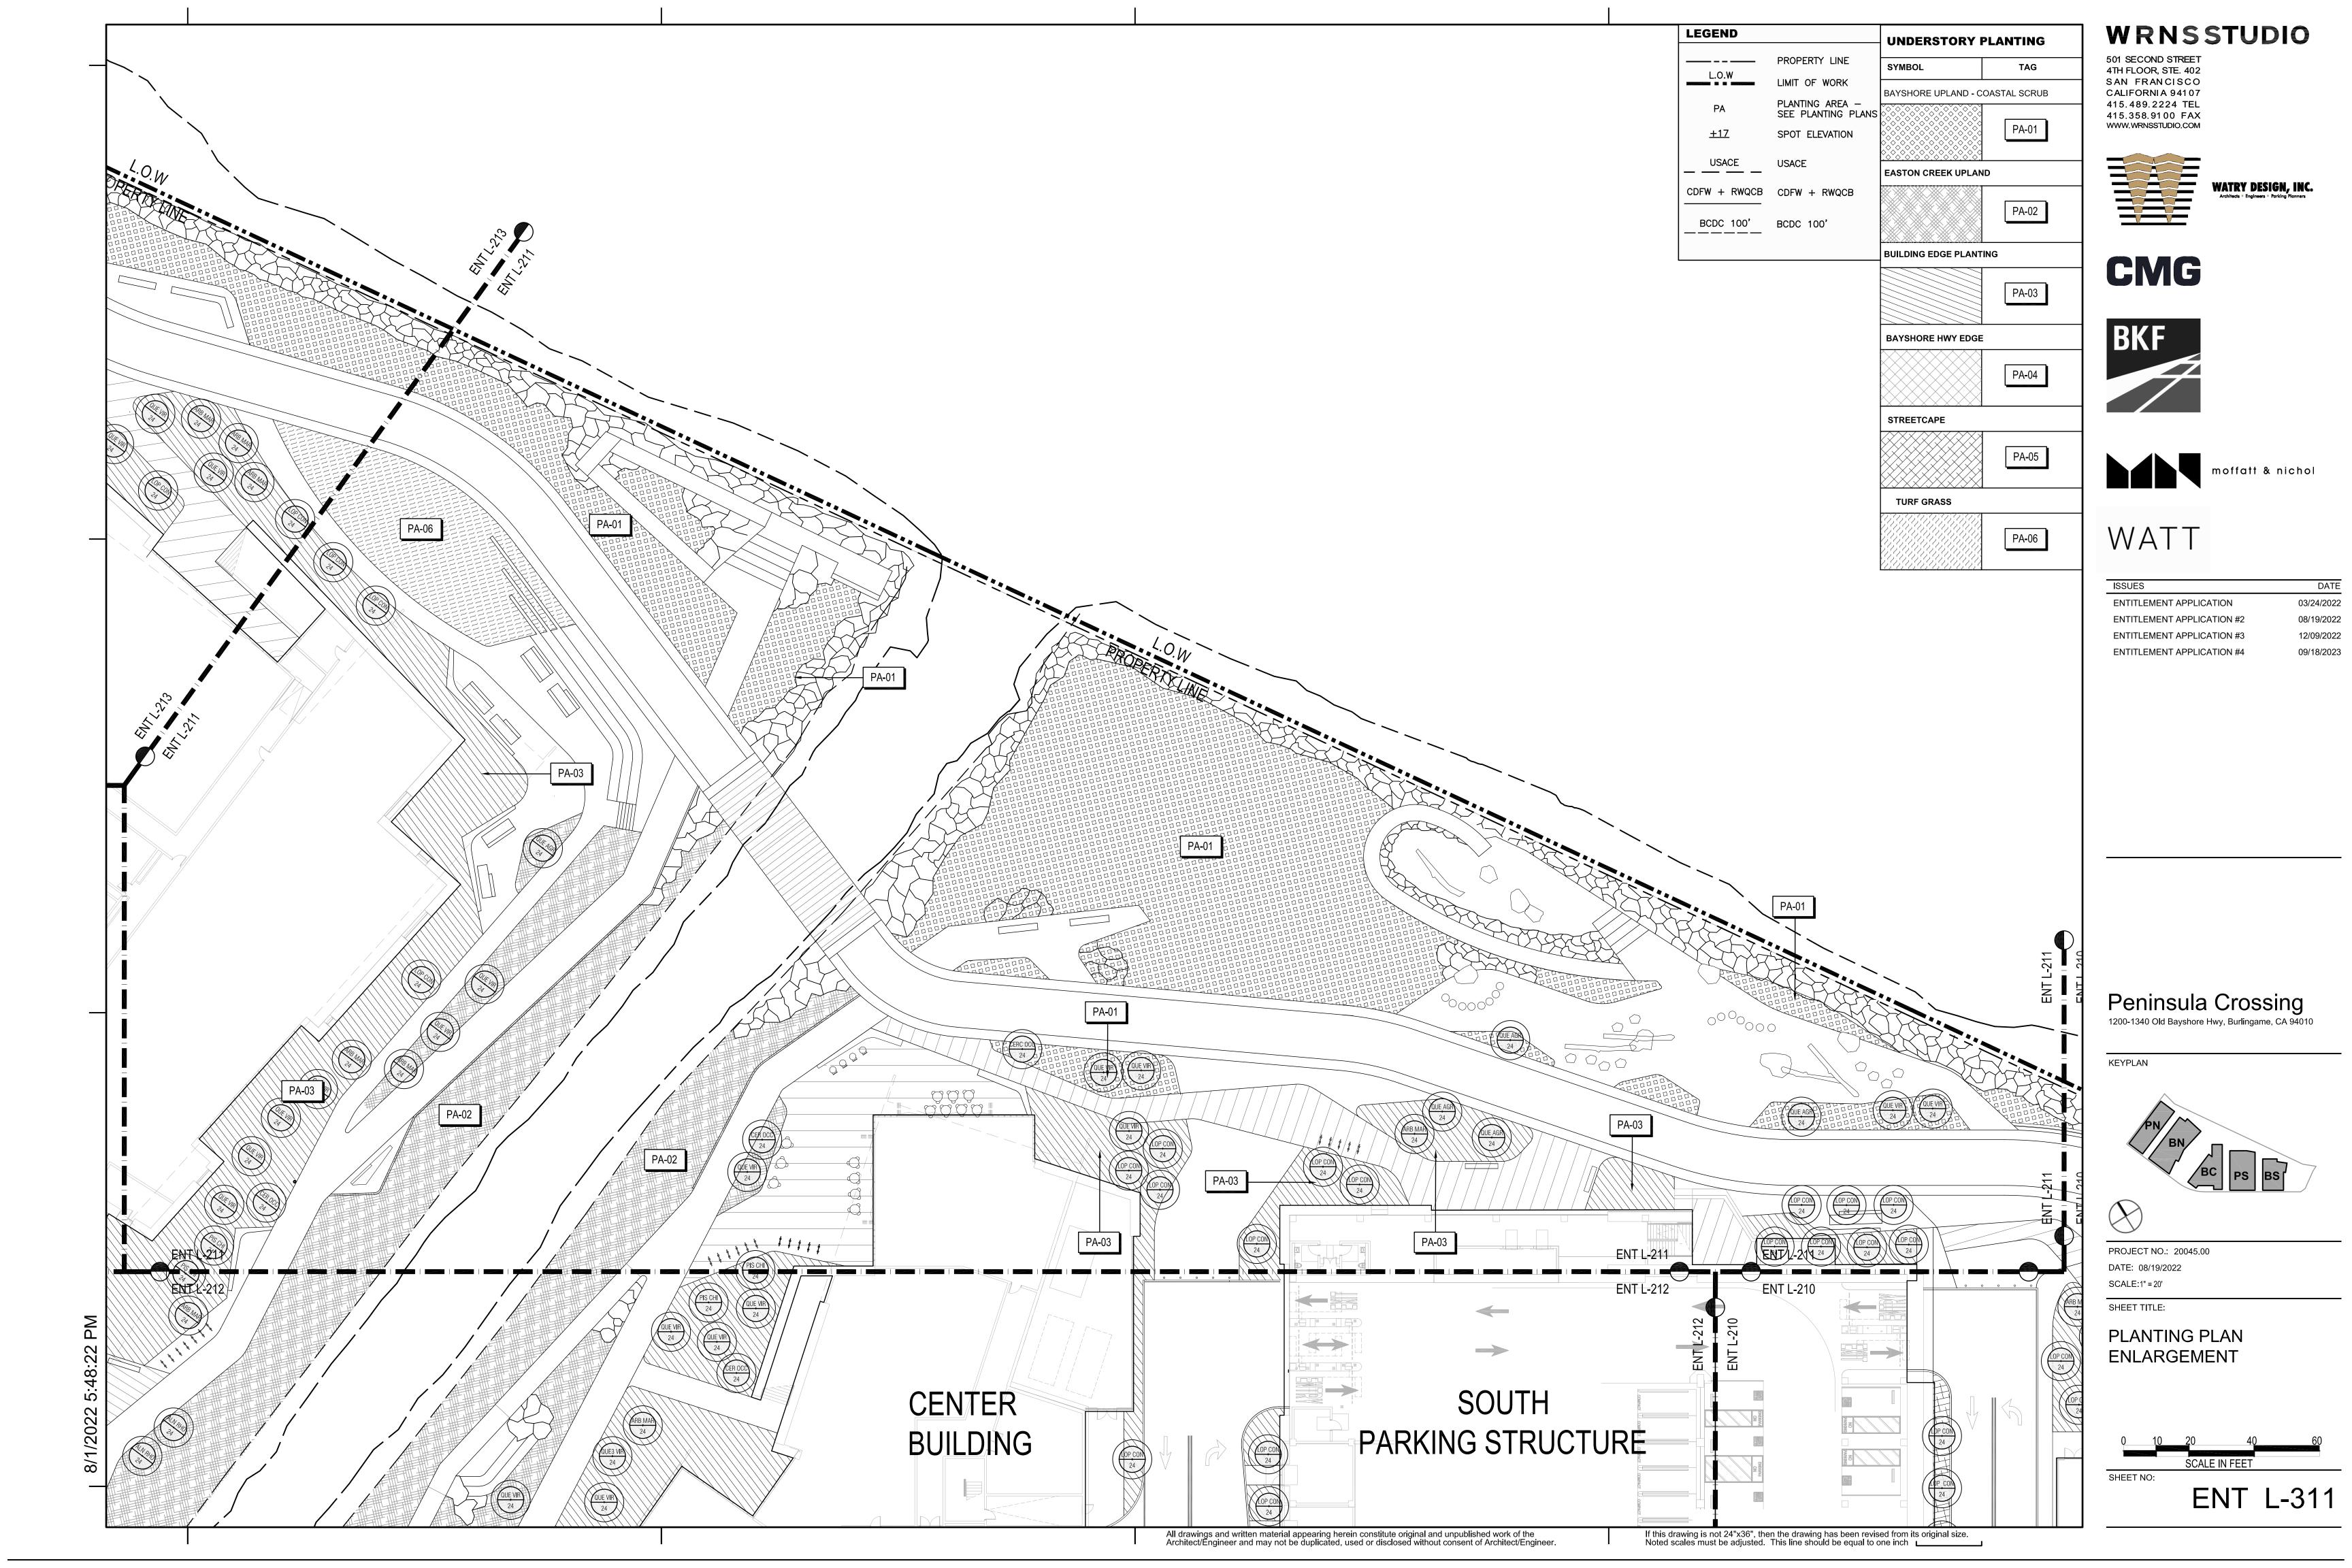

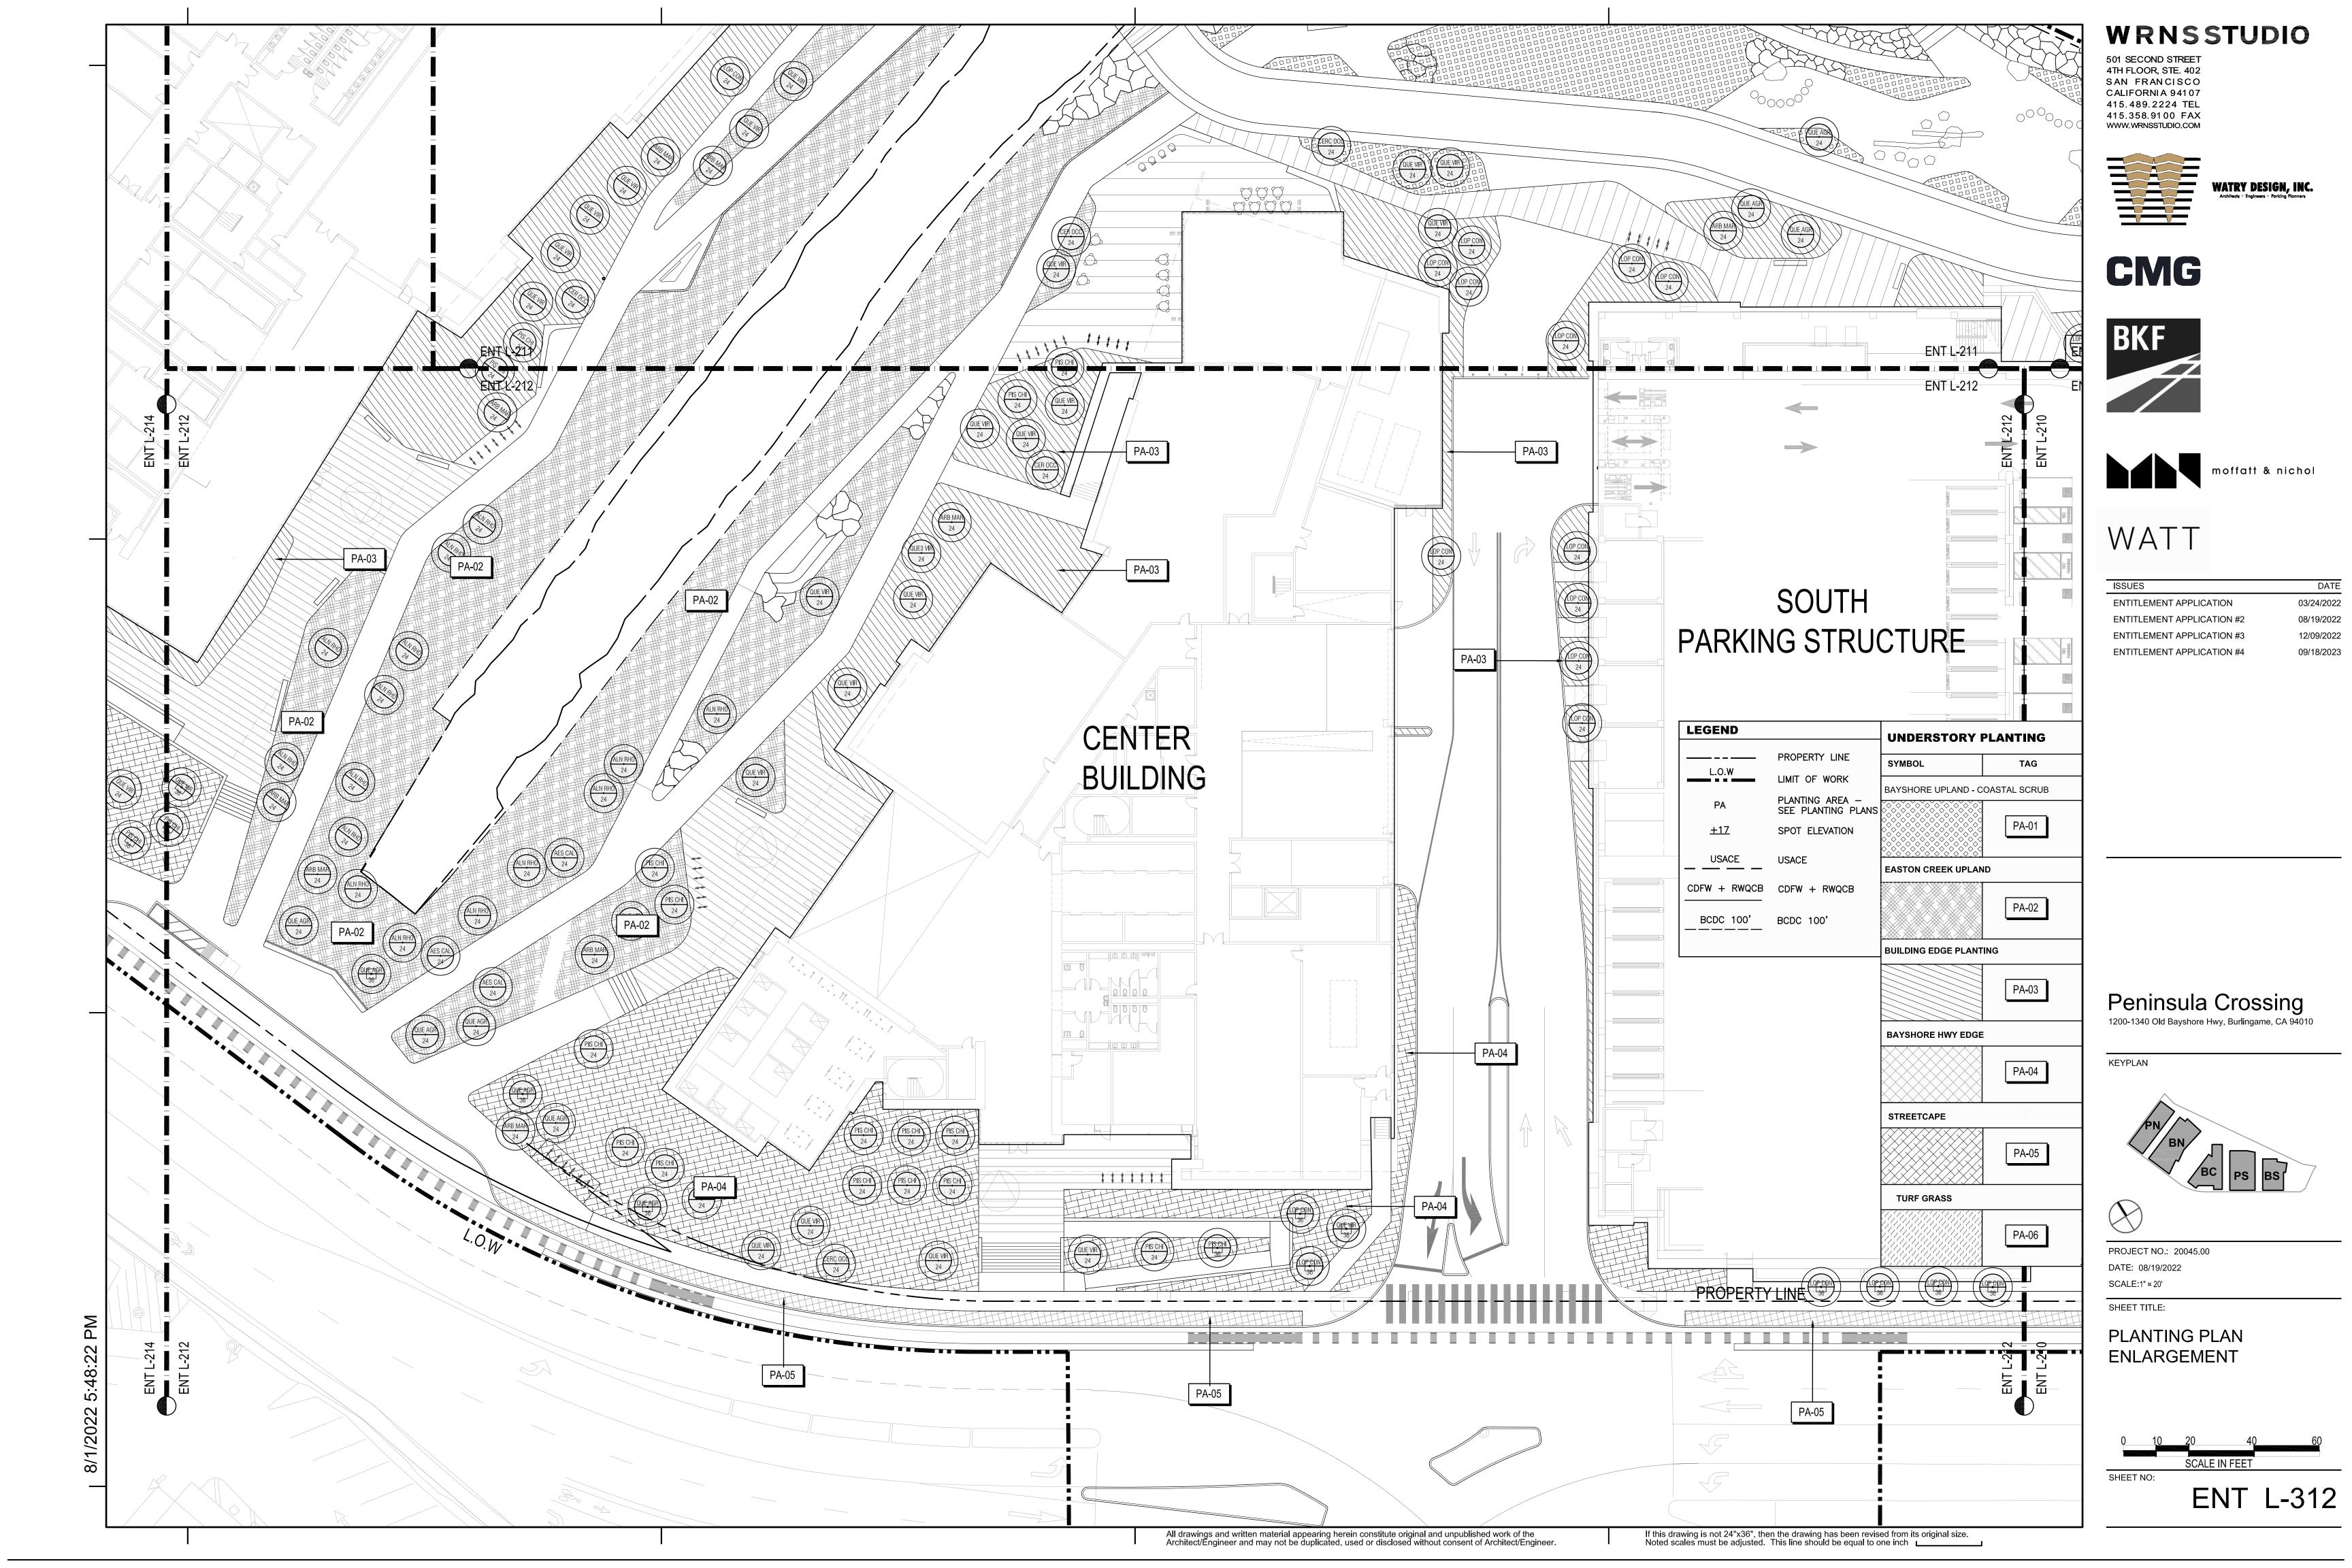

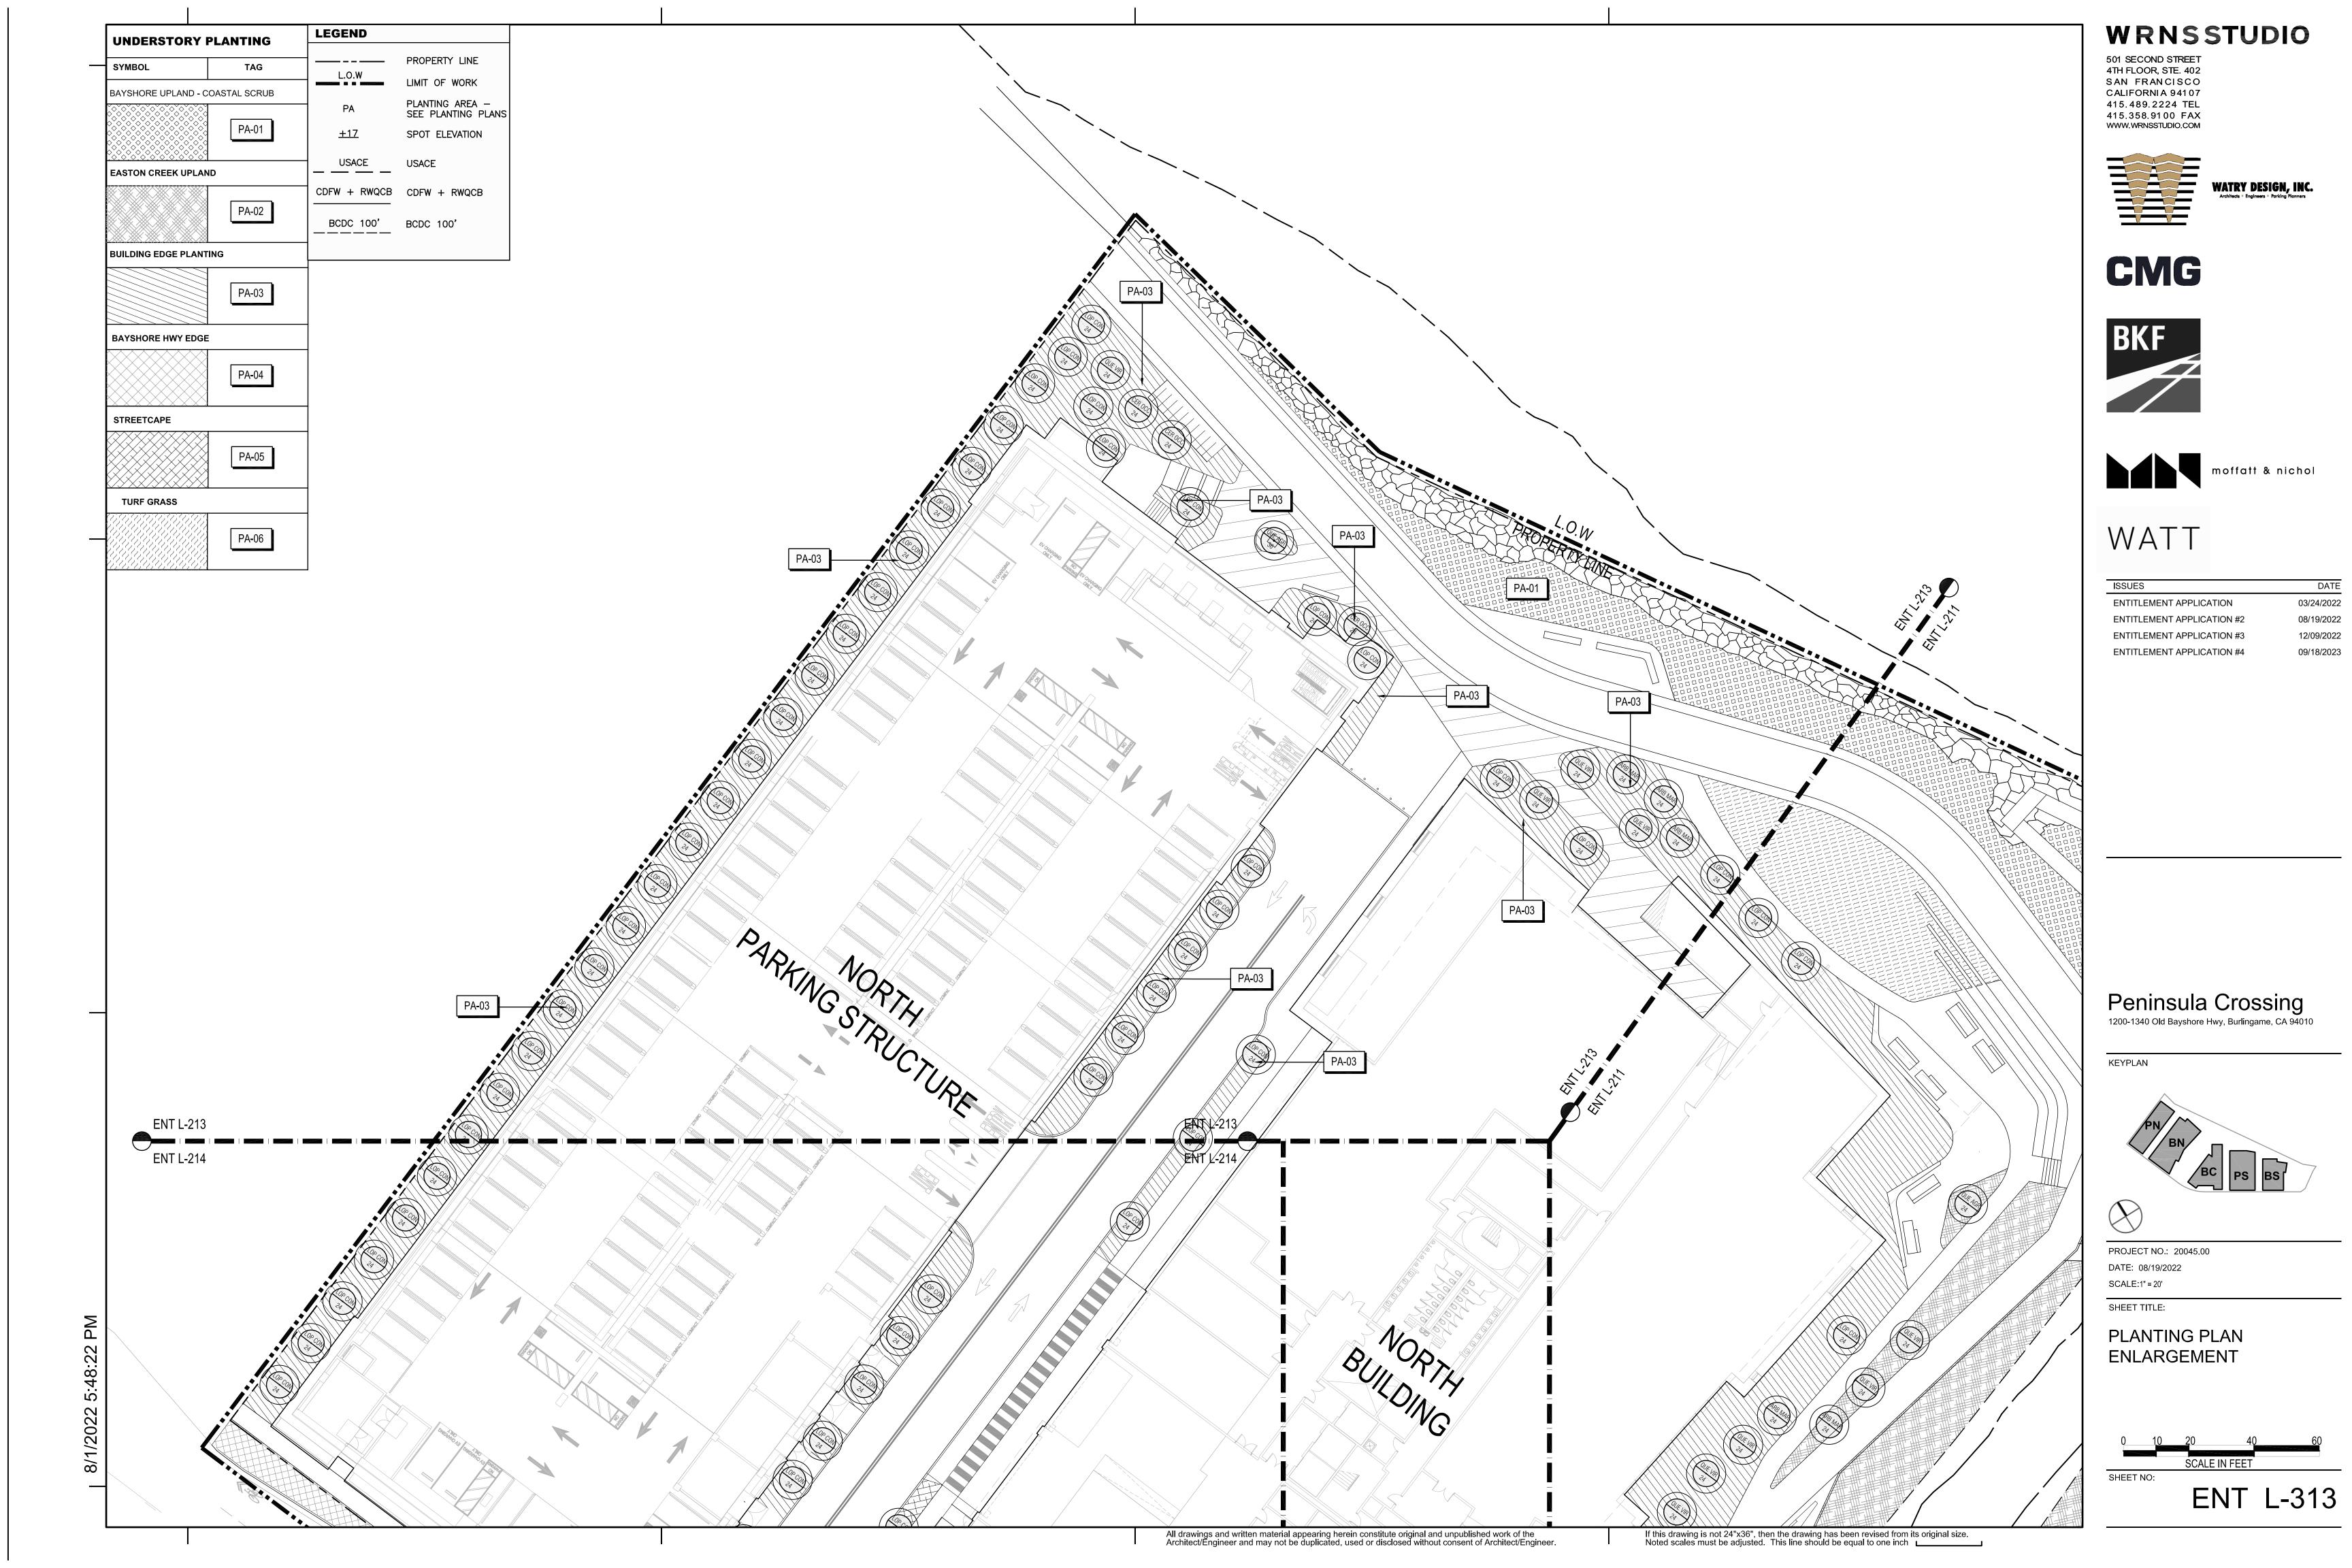

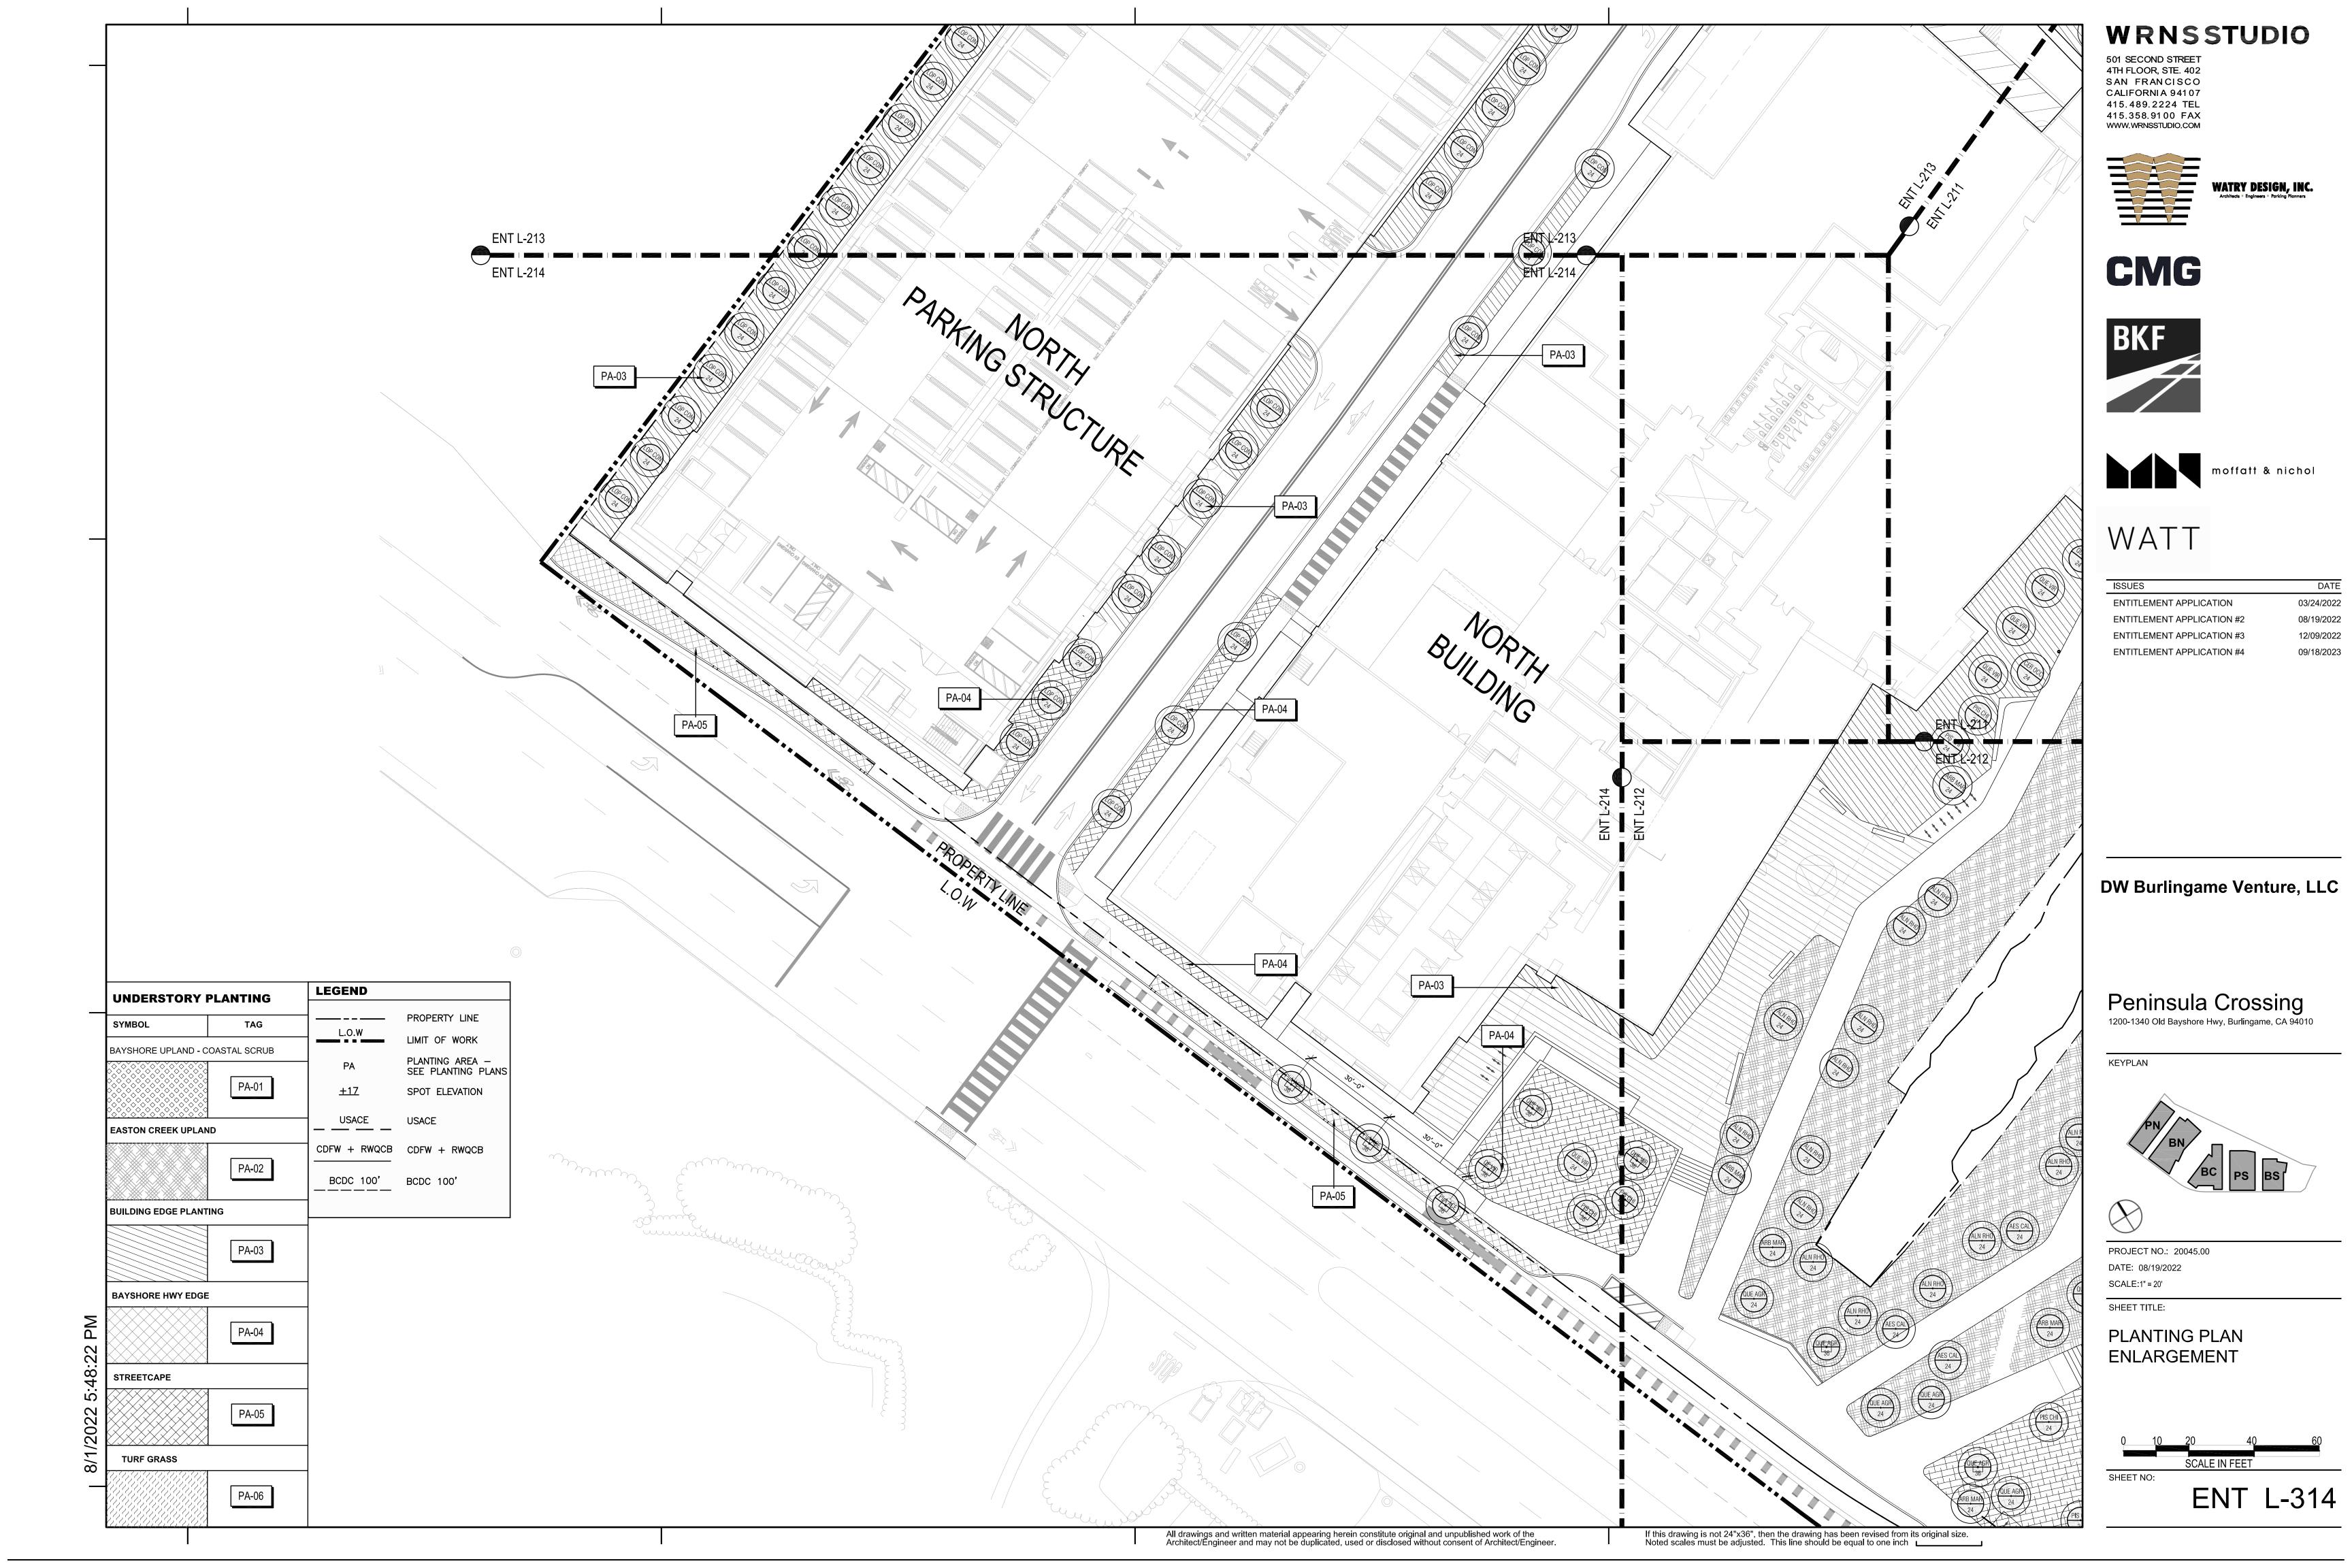


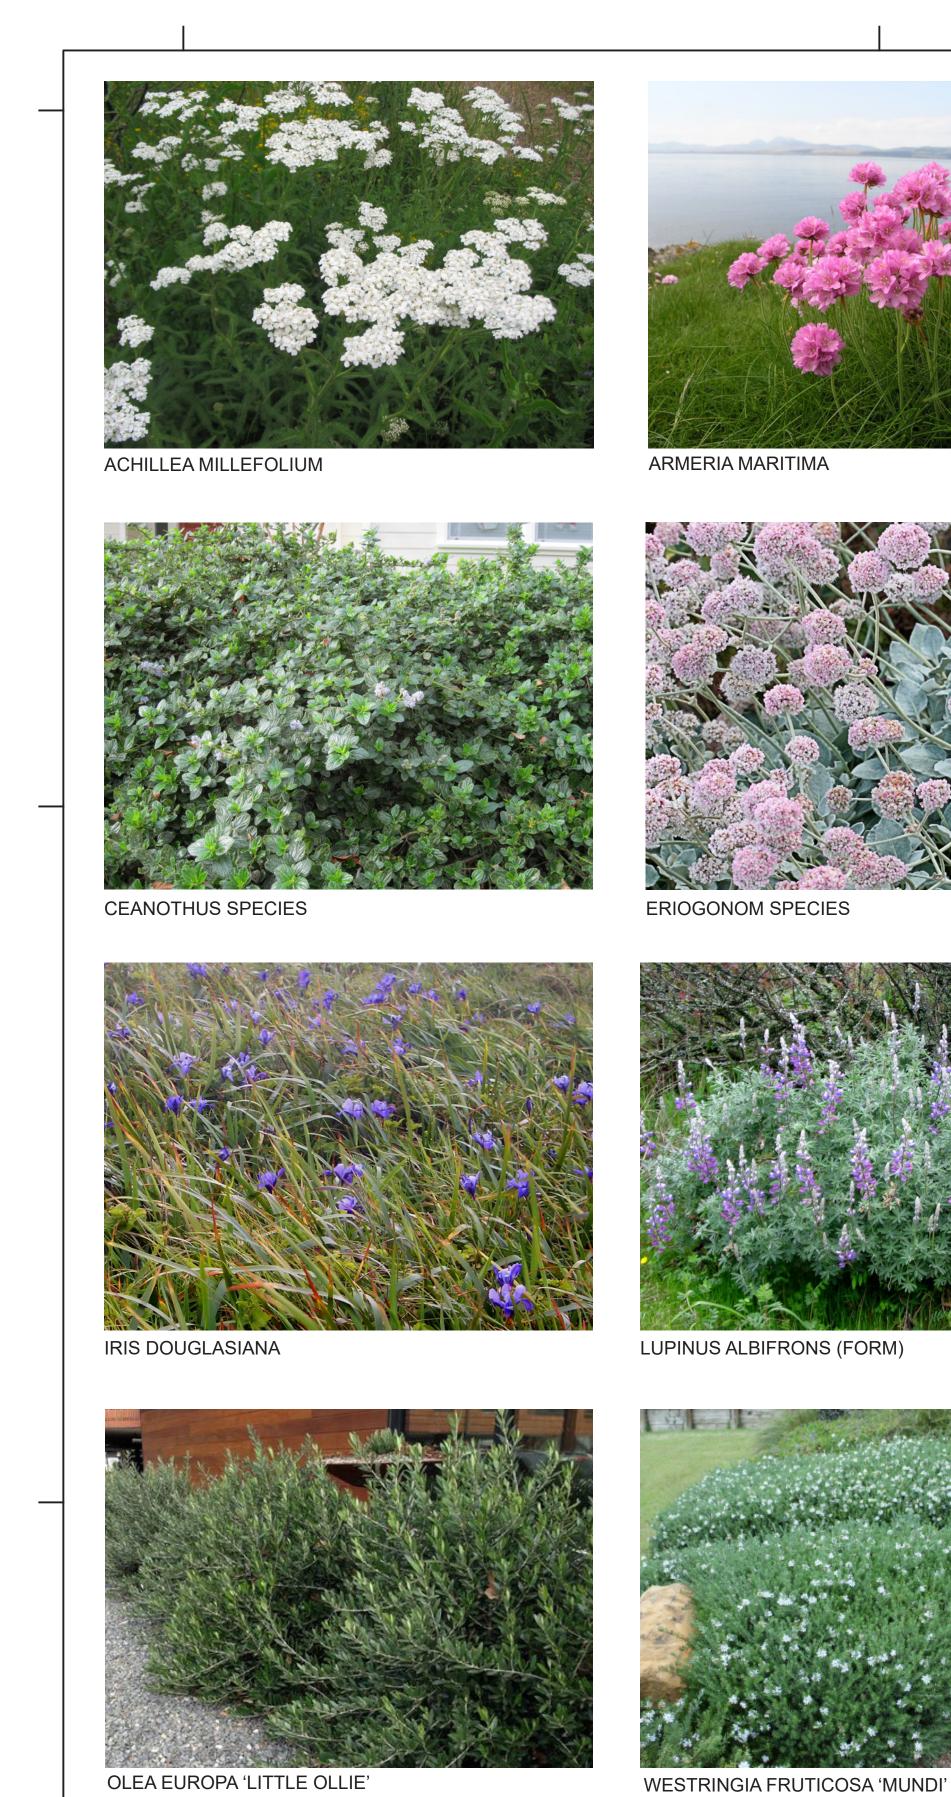

CERCIS OCCIDENTALIS


PISTACIA CHINENSIS

LOPHOSTEMON CONFERTA

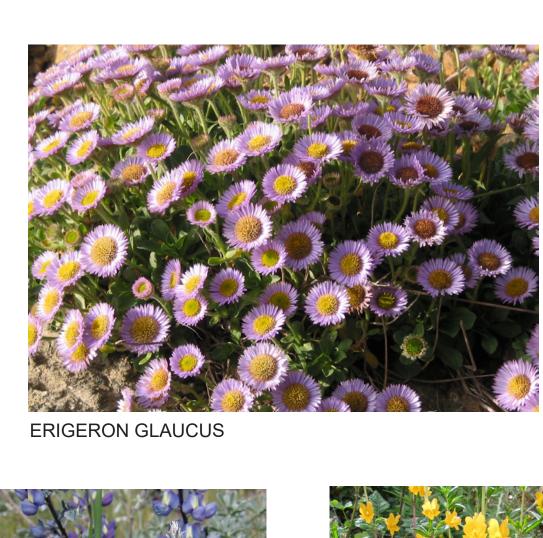

ARTEMESIA CALIFORNICA

LUPINUS ALBIFRONS (FLOWER)

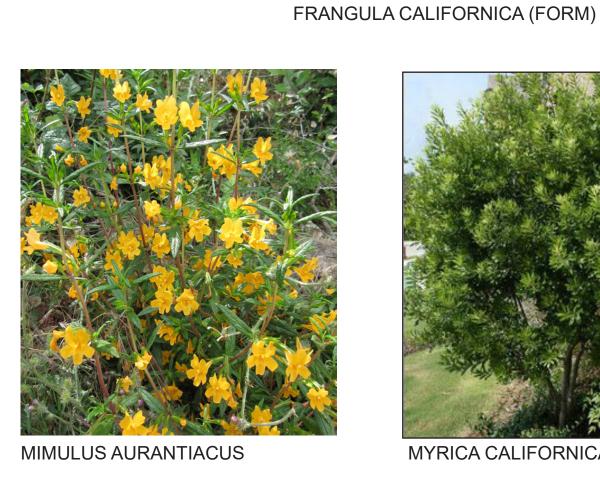



BACCHARIS PILULARIS




CALAMAGROSTIS FOLIOSA

FRANGULA CALIFORNICA (DETAIL)






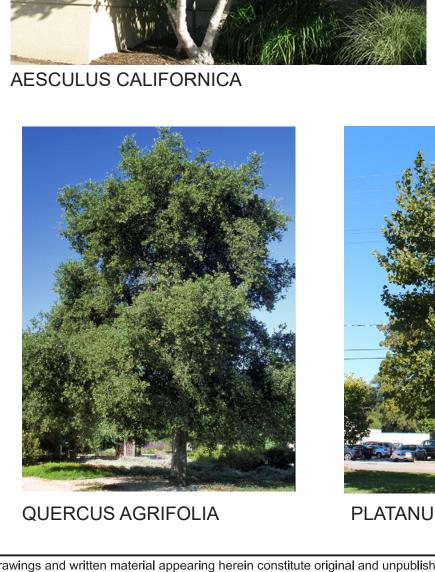



WRNSSTUDIO

501 SECOND STREET 4TH FLOOR, STE. 402 SAN FRANCISCO CALIFORNIA 94107 415.489.2224 TEL 415.358.9100 FAX www.wrnsstudio.com

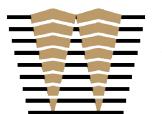

WATRY DESIGN, INC.
Architects • Engineers • Parking Planners

CMG





WATT


ENTITLEMENT APPLICATION #4

ISSUES ENTITLEMENT APPLICATION 03/24/2022 ENTITLEMENT APPLICATION #2 08/19/2022 12/09/2022 **ENTITLEMENT APPLICATION #3**

09/18/2023

Peninsula Crossing 1200-1340 Old Bayshore Hwy, Burlingame, CA 94010

KEYPLAN

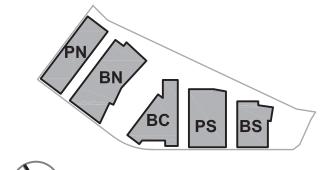





PROJECT NO.: 20045.00 DATE: 08/19/2022 SCALE: N/A

SHEET TITLE:


PLANT AND TREE IMAGES

SHEET NO:

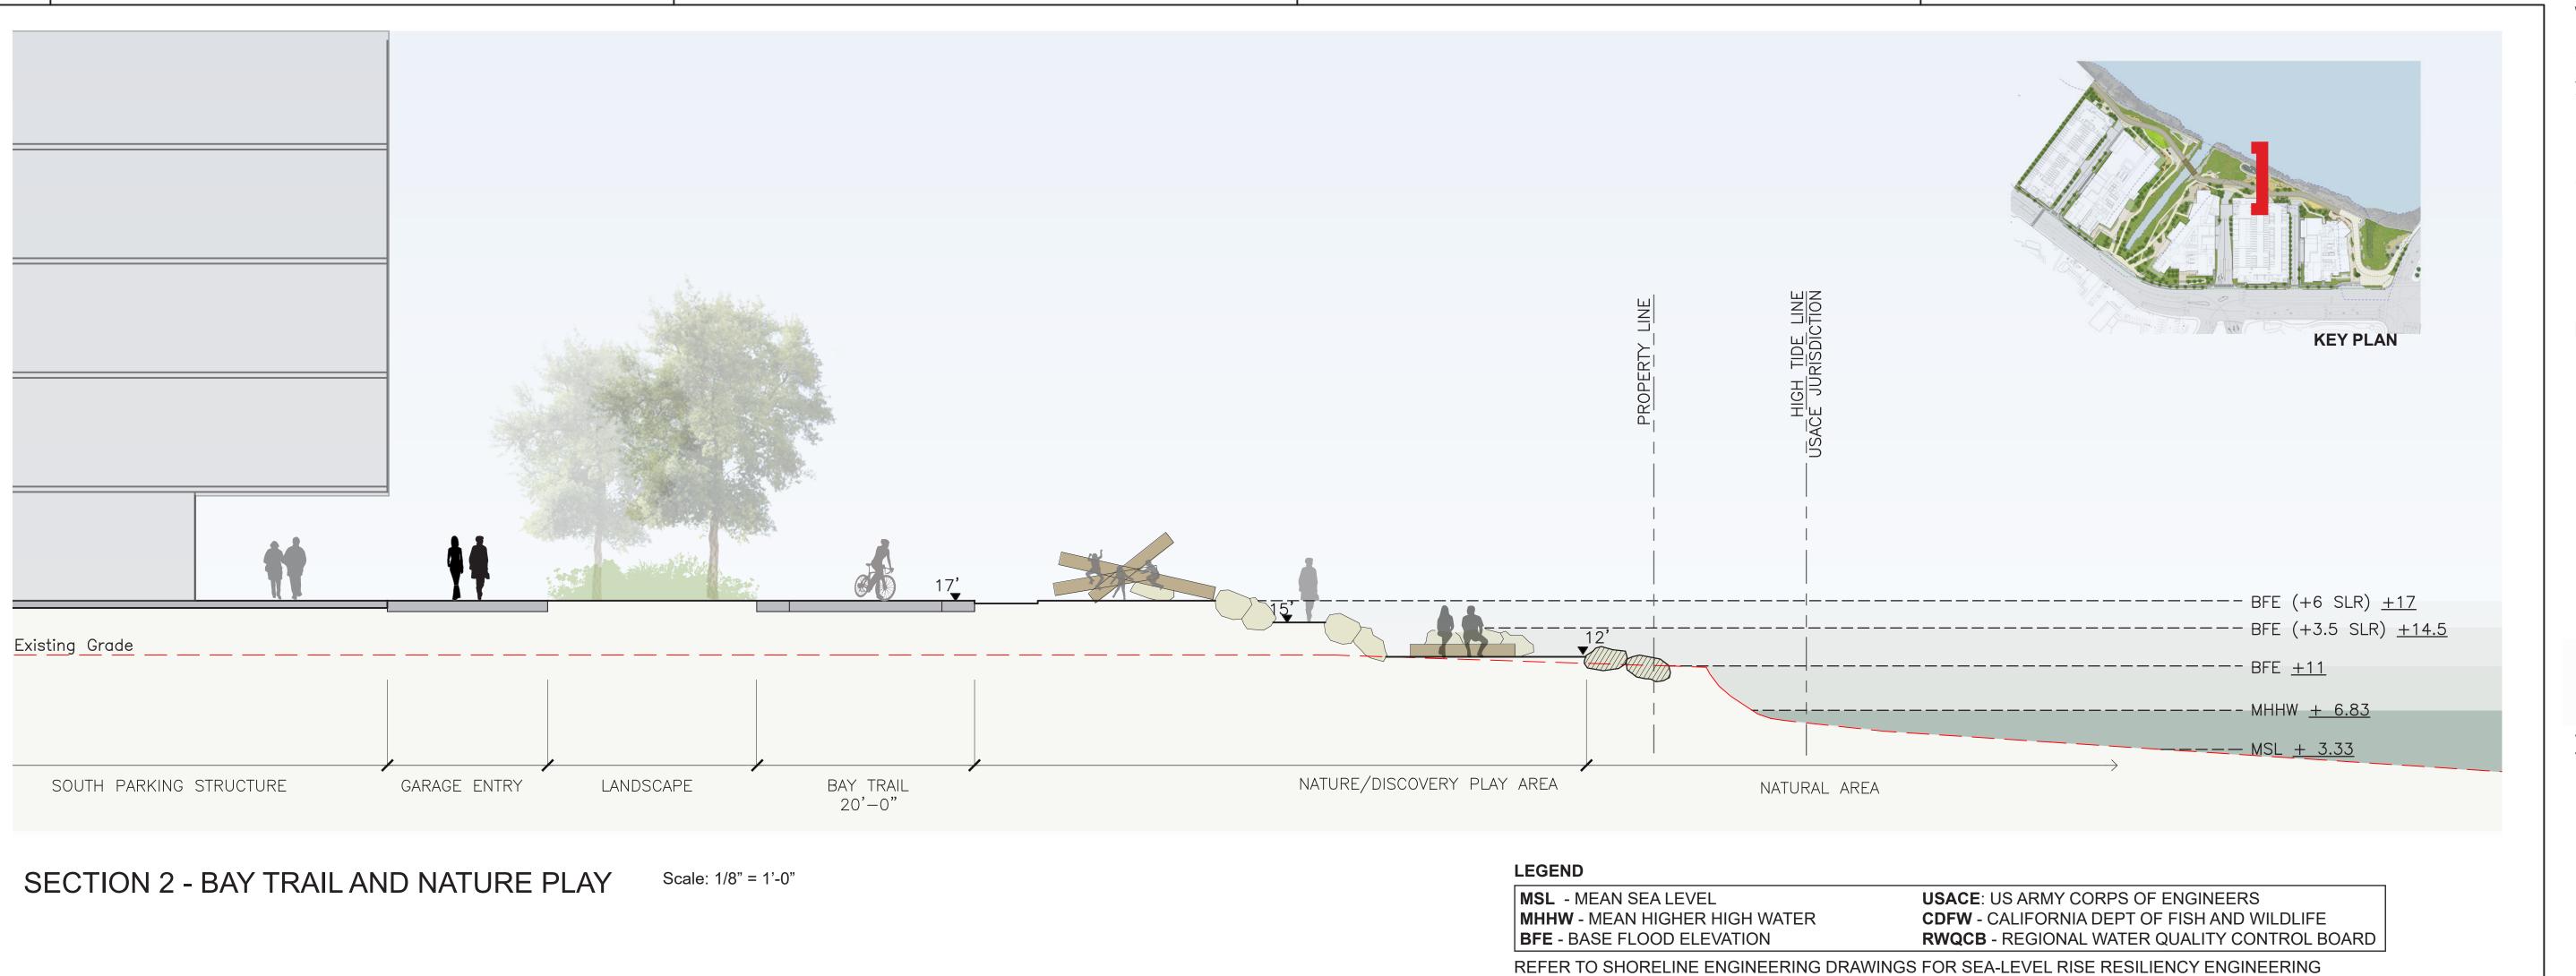

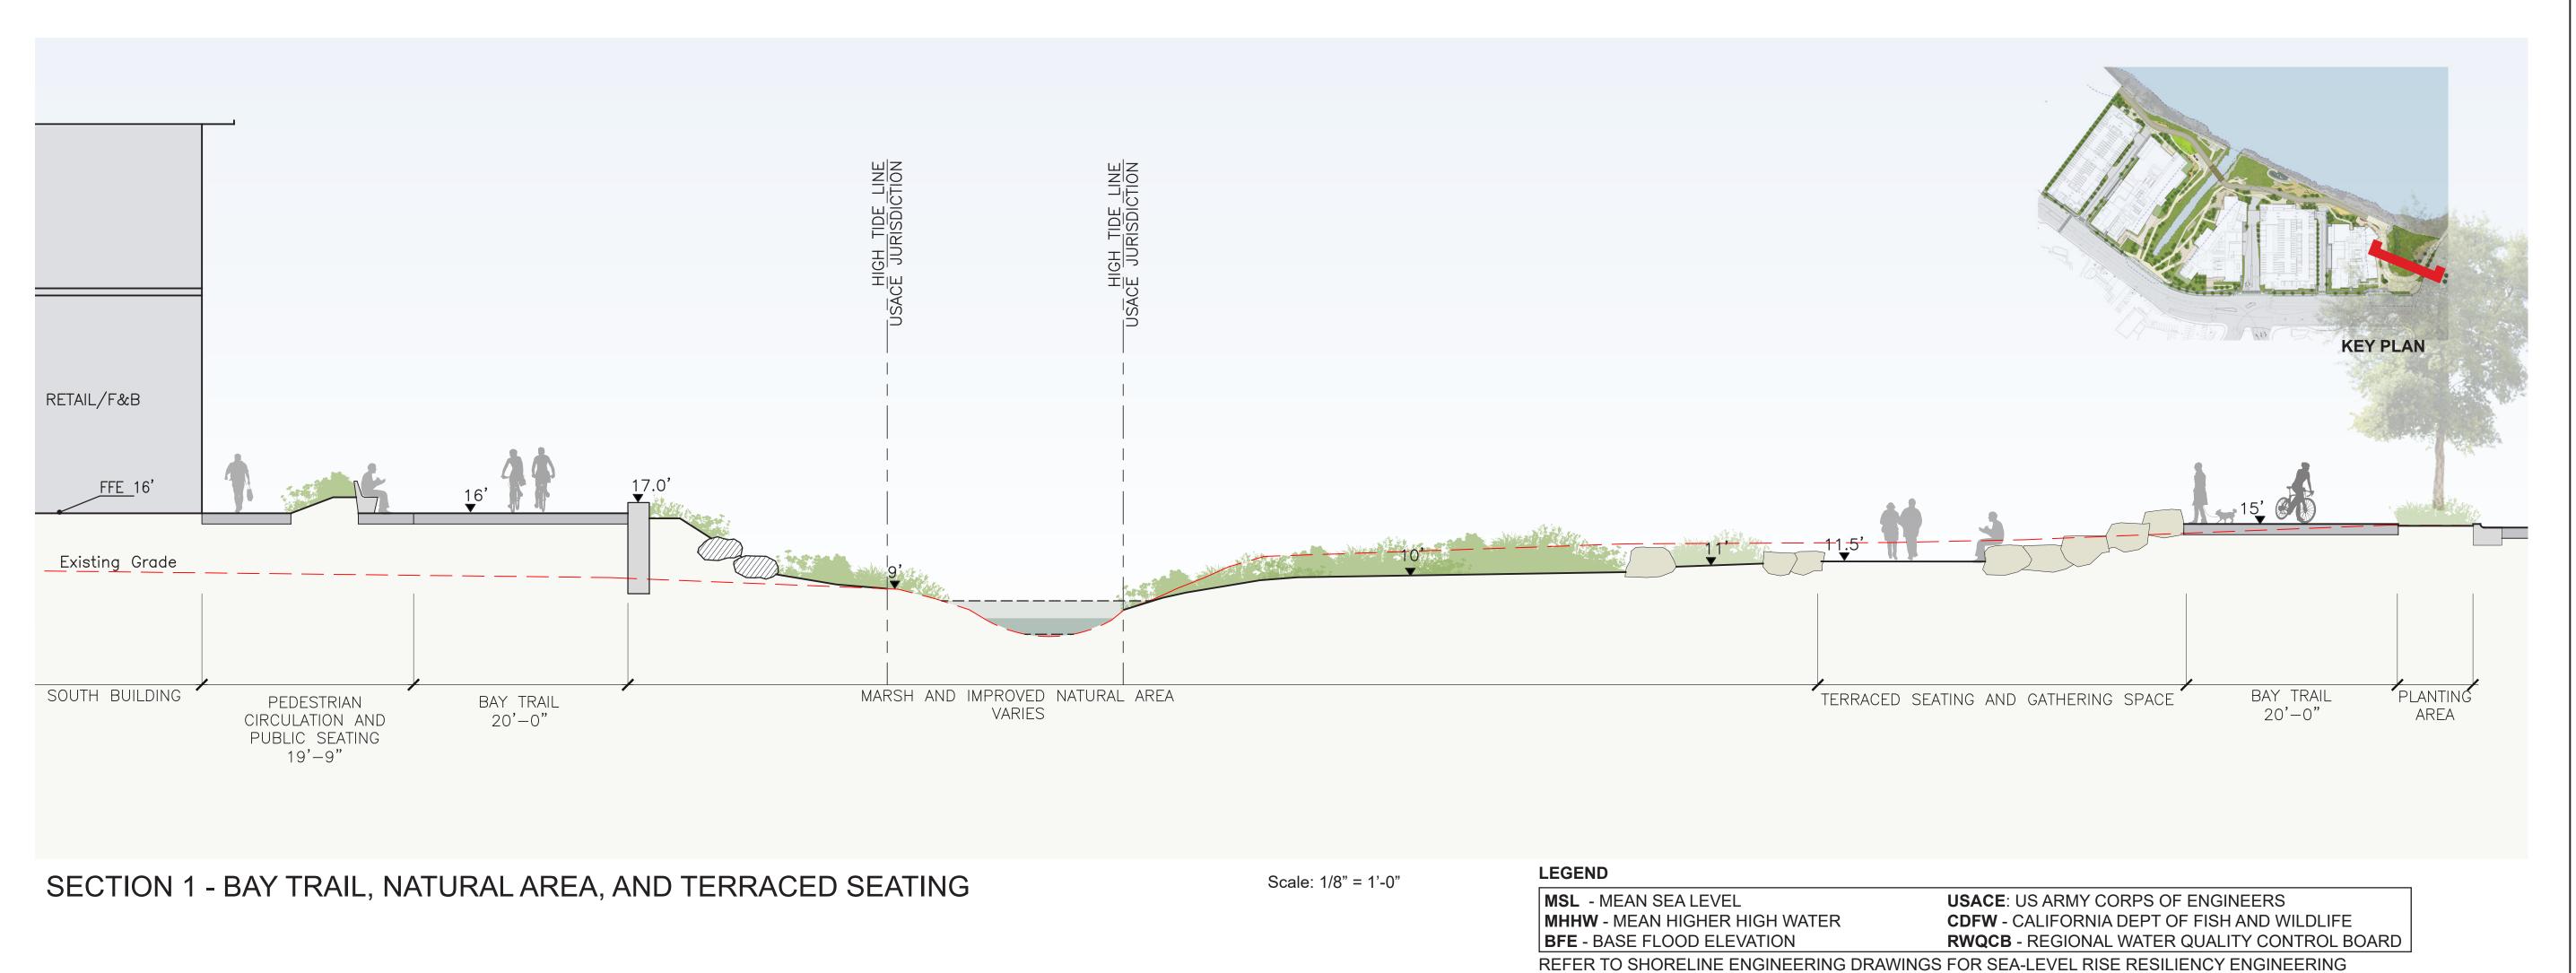

501 SECOND STREET 4TH FLOOR, STE. 402 SAN FRANCISCO CALIFORNIA 94107 415.489.2224 TEL 415.358.9100 FAX WWW.WRNSSTUDIO.COM

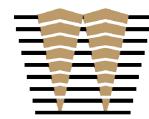

WATRY DESIGN, INC.

Architects • Engineers • Parking Planners








WATT

ISSUES	DATE
ENTITLEMENT APPLICATION	03/24/2022
ENTITLEMENT APPLICATION #2	08/19/2022
ENTITLEMENT APPLICATION #3	12/09/2022
ENTITLEMENT APPLICATION #4	09/18/2023

Peninsula Crossing 1200-1340 Old Bayshore Hwy, Burlingame, CA 94010

KEYPLAN

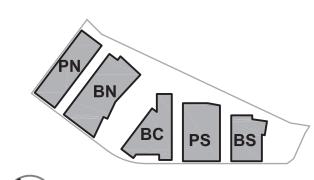




PROJECT NO.: 20045.00 DATE: 08/19/2022 SCALE: 1/8" = 1'-0"

SHEET TITLE:


SITE SECTIONS

ENT L-401

All drawings and written material appearing herein constitute original and unpublished work of the Architect/Engineer and may not be duplicated, used or disclosed without consent of Architect/Engineer.

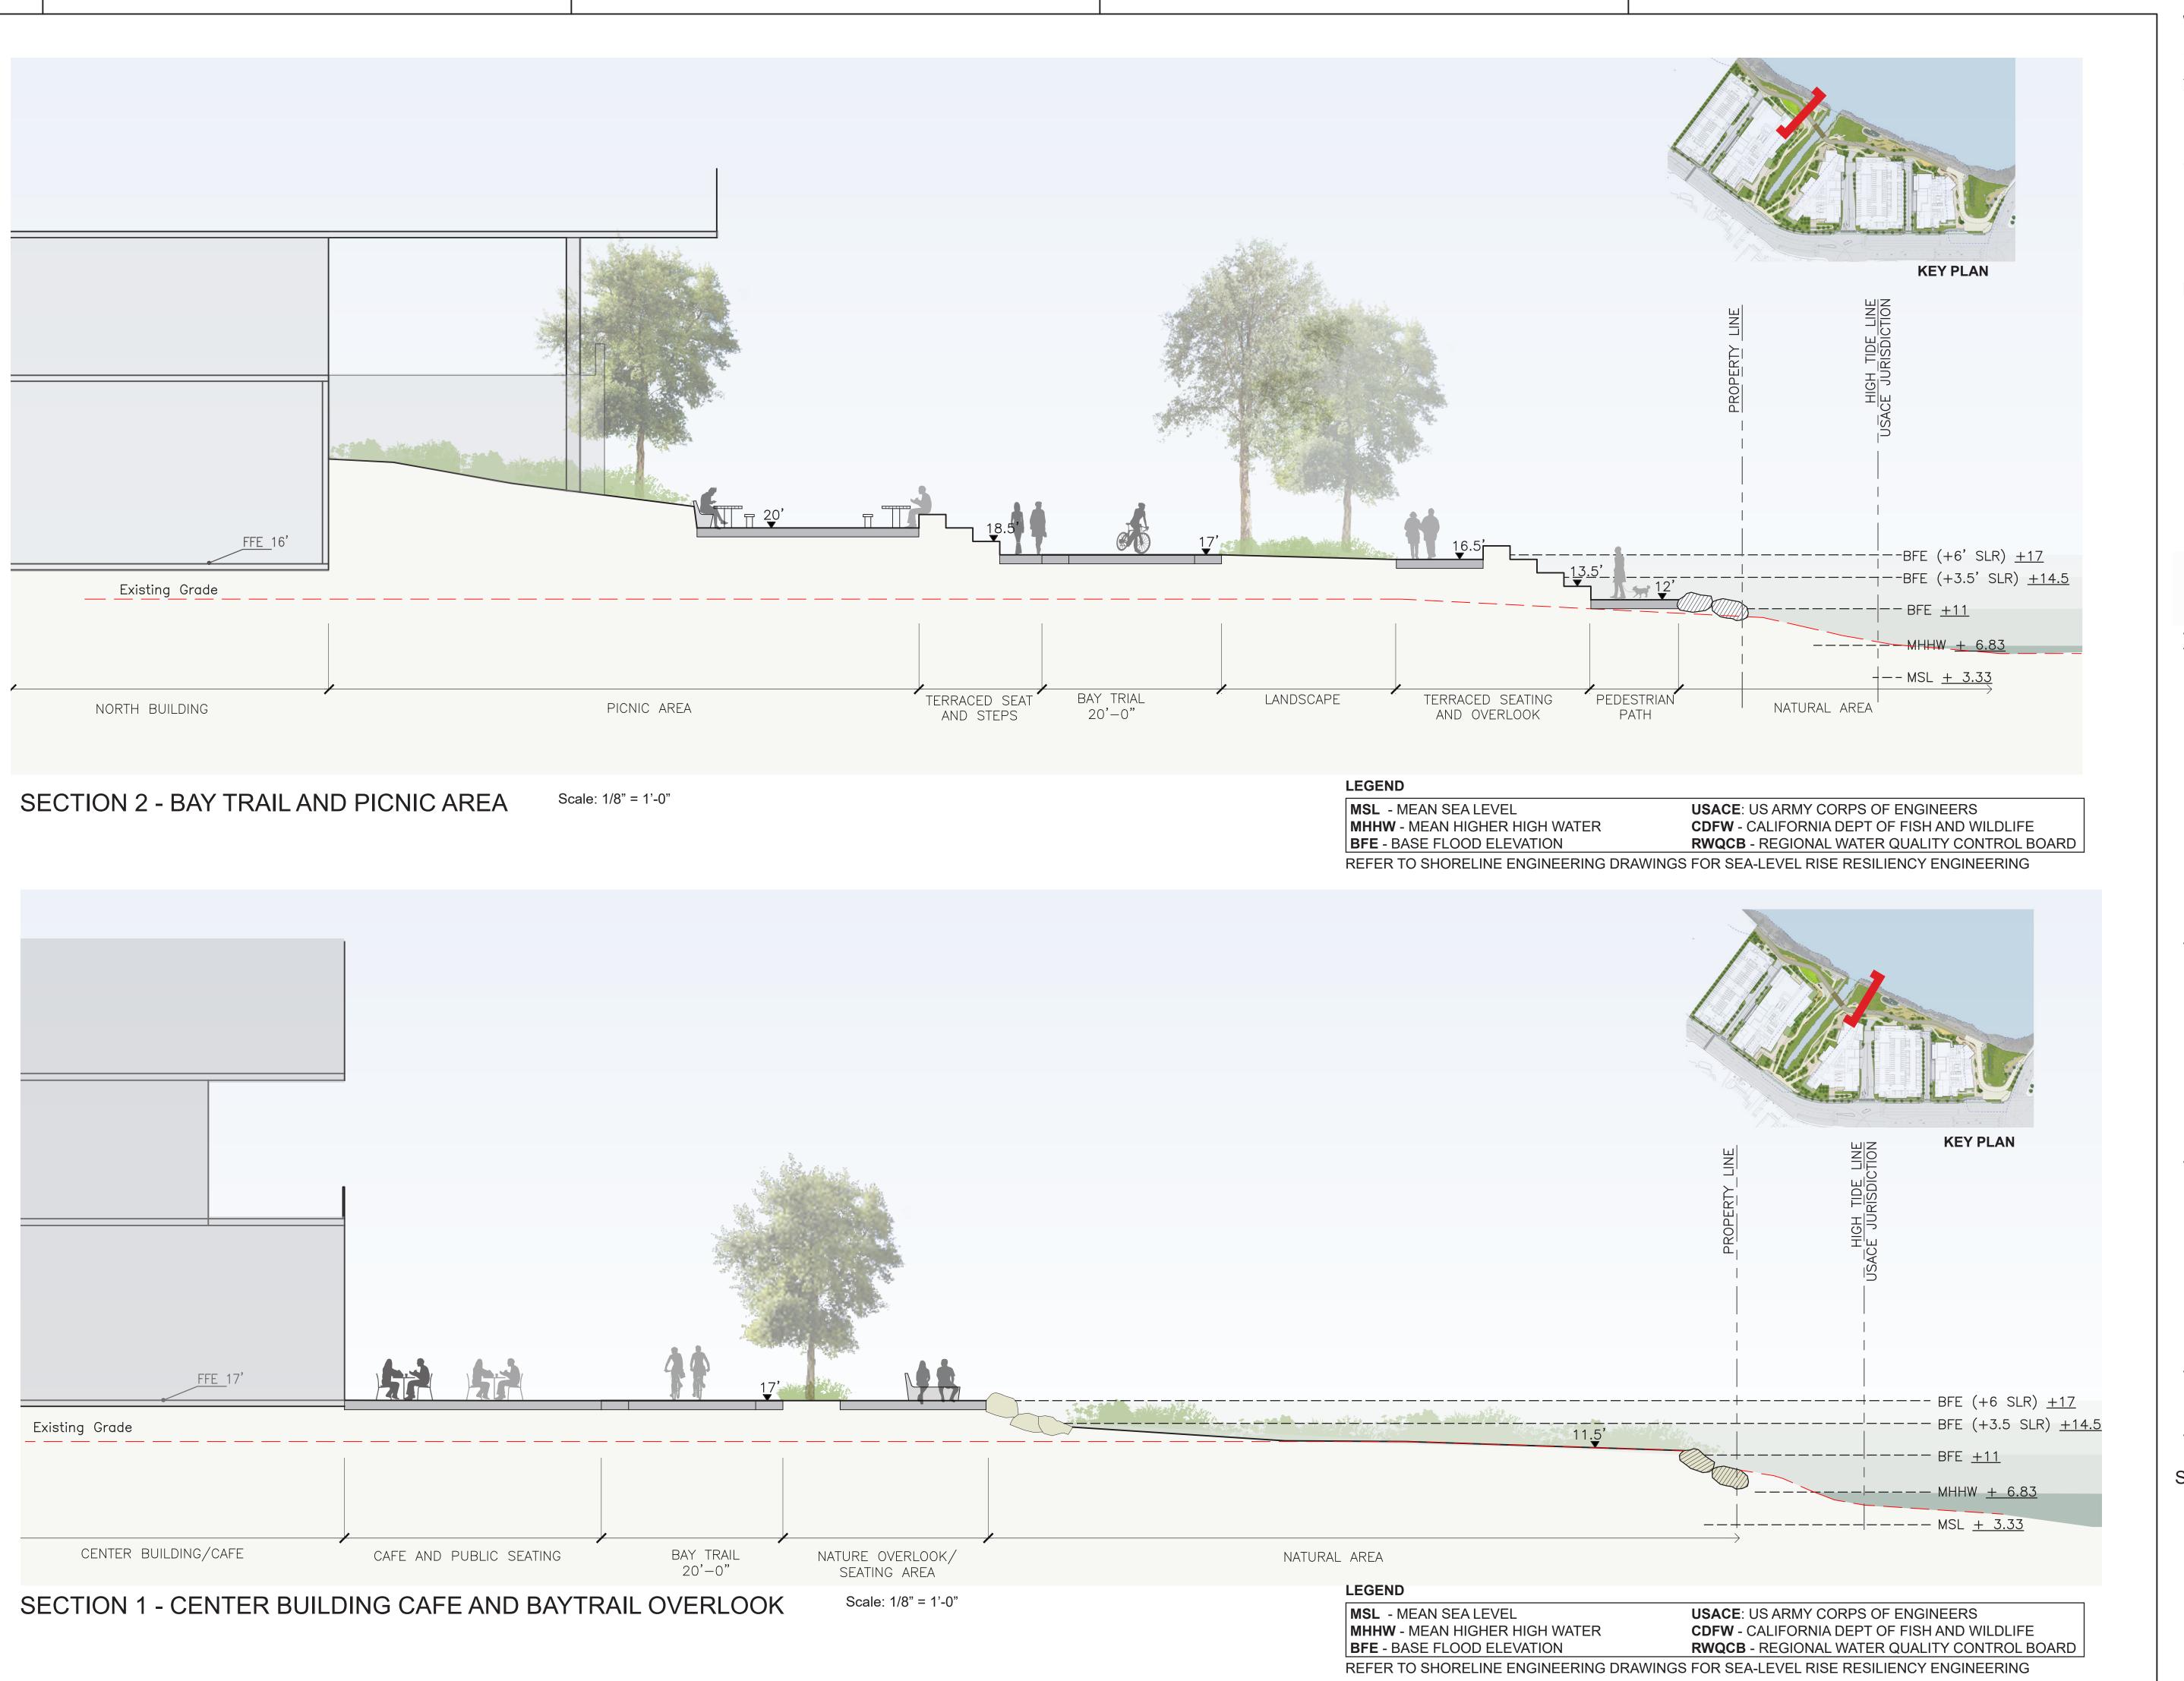

501 SECOND STREET 4TH FLOOR, STE. 402 SAN FRANCISCO CALIFORNIA 94107 415.489.2224 TEL 415.358.9100 FAX www.wrnsstudio.com

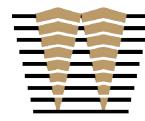

WATRY DESIGN, INC.

Architects • Engineers • Parking Planners








WATT

ISSUES	DATE
ENTITLEMENT APPLICATION	03/24/2022
ENTITLEMENT APPLICATION #2	08/19/2022
ENTITLEMENT APPLICATION #3	12/09/2022
ENTITLEMENT APPLICATION #4	09/18/2023

Peninsula Crossing 1200-1340 Old Bayshore Hwy, Burlingame, CA 94010

KEYPLAN

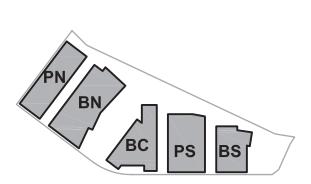




PROJECT NO.: 20045.00 DATE: 08/19/2022 SCALE: 1/8" = 1'-0"

SHEET TITLE:

SITE SECTIONS


ENT L-402

All drawings and written material appearing herein constitute original and unpublished work of the Architect/Engineer and may not be duplicated, used or disclosed without consent of Architect/Engineer.

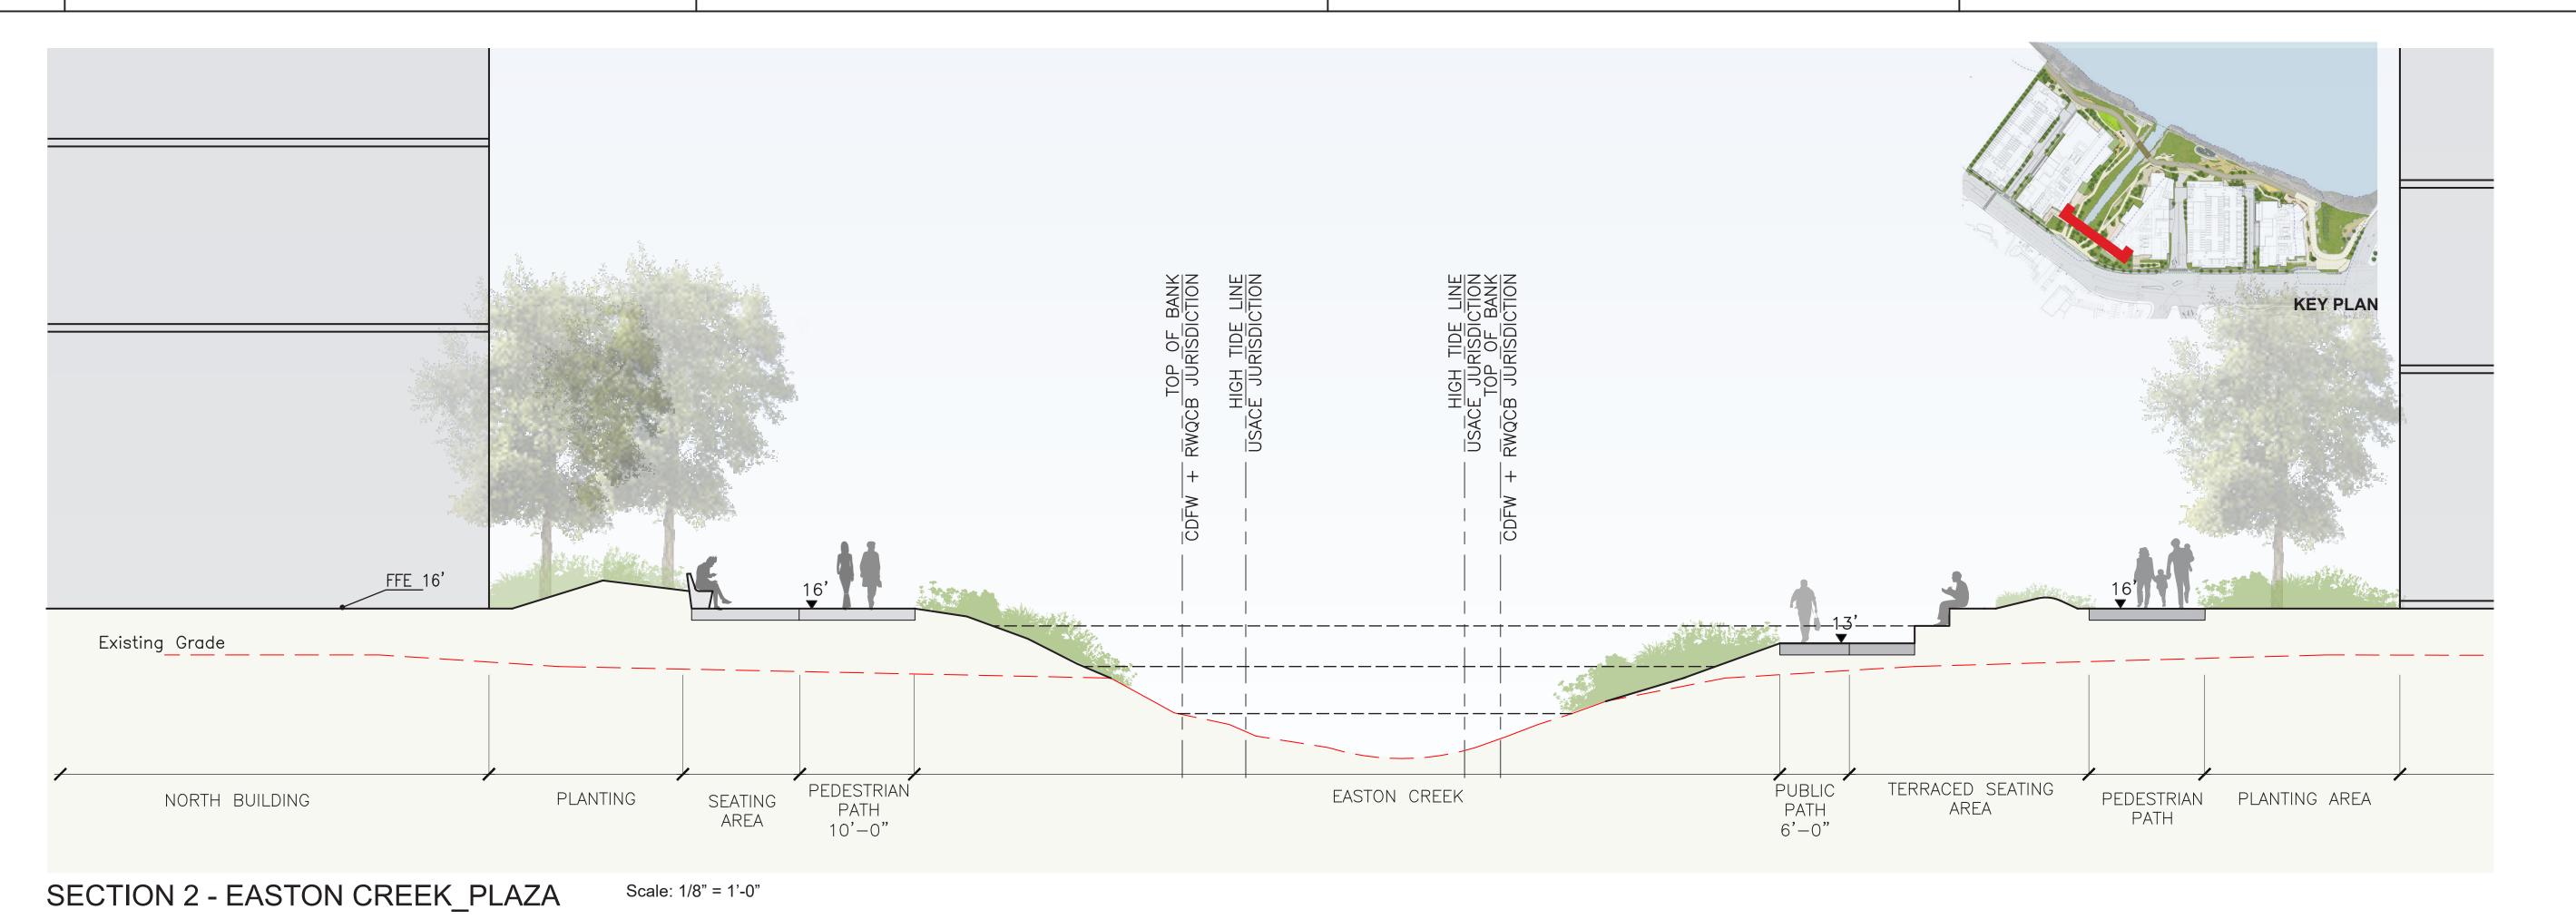

LEGEND

MSL - MEAN SEA LEVEL **USACE**: US ARMY CORPS OF ENGINEERS MHHW - MEAN HIGHER HIGH WATER **CDFW** - CALIFORNIA DEPT OF FISH AND WILDLIFE **BFE** - BASE FLOOD ELEVATION **RWQCB** - REGIONAL WATER QUALITY CONTROL BOARD REFER TO SHORELINE ENGINEERING DRAWINGS FOR SEA-LEVEL RISE RESILIENCY ENGINEERING

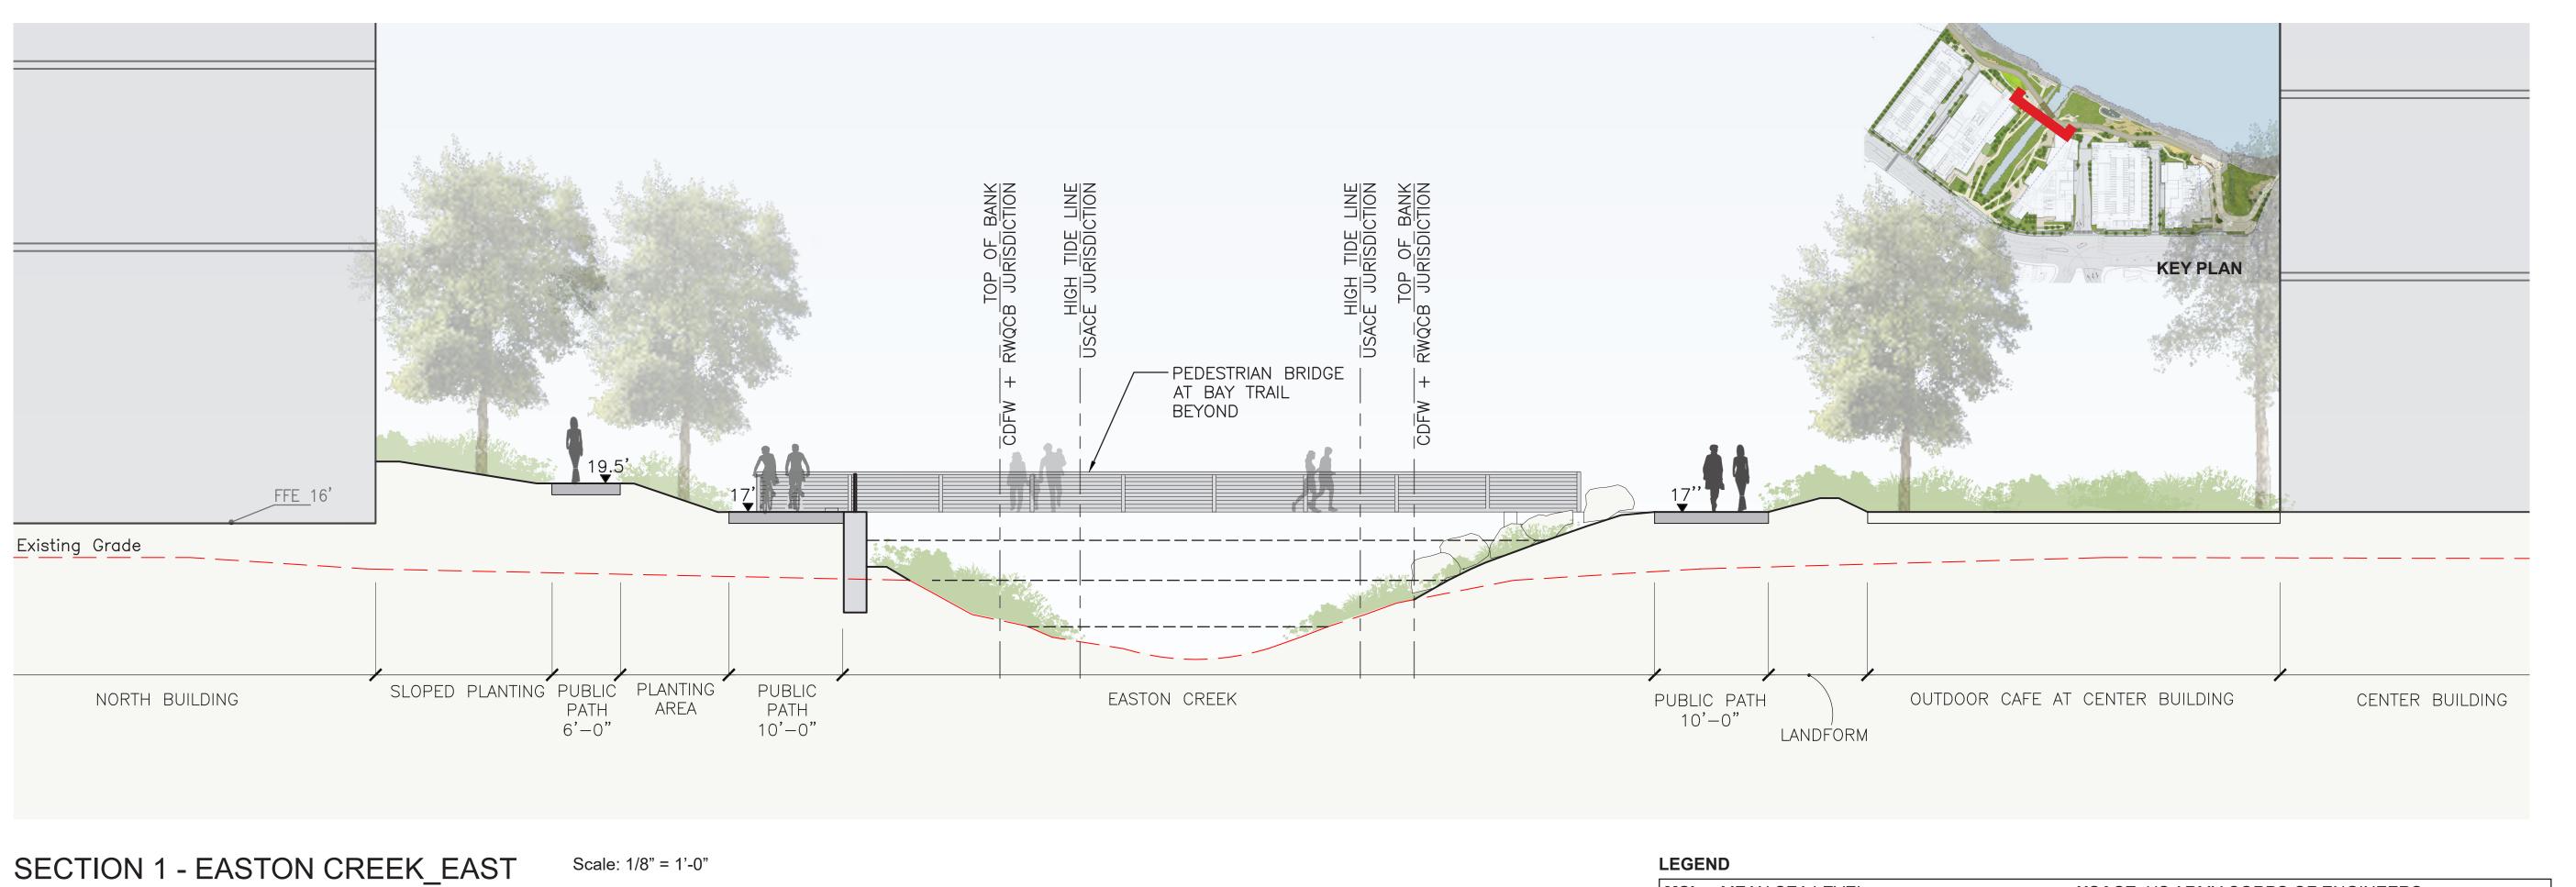


MSL - MEAN SEA LEVEL **USACE**: US ARMY CORPS OF ENGINEERS

MHHW - MEAN HIGHER HIGH WATER **CDFW** - CALIFORNIA DEPT OF FISH AND WILDLIFE **BFE** - BASE FLOOD ELEVATION RWQCB - REGIONAL WATER QUALITY CONTROL BOARD REFER TO SHORELINE ENGINEERING DRAWINGS FOR SEA-LEVEL RISE RESILIENCY ENGINEERING

WRNSSTUDIO

501 SECOND STREET 4TH FLOOR, STE. 402 SAN FRANCISCO CALIFORNIA 94107 415.489.2224 TEL 415.358.9100 FAX WWW.WRNSSTUDIO.COM

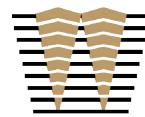

WATRY DESIGN, INC.
Architects • Engineers • Parking Planners








WATT

ISSUES	DATE
ENTITLEMENT APPLICATION	03/24/2022
ENTITLEMENT APPLICATION #2	08/19/2022
ENTITLEMENT APPLICATION #3	12/09/2022
ENTITLEMENT APPLICATION #4	09/18/2023

Peninsula Crossing 1200-1340 Old Bayshore Hwy, Burlingame, CA 94010

KEYPLAN

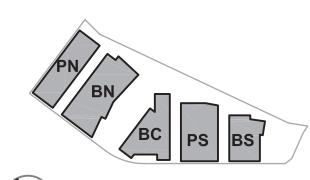




PROJECT NO.: 20045.00 DATE: 08/19/2022 SCALE: 1/8" = 1'-0"


SHEET TITLE:

SITE SECTIONS

ENT L-403

All drawings and written material appearing herein constitute original and unpublished work of the Architect/Engineer and may not be duplicated, used or disclosed without consent of Architect/Engineer.

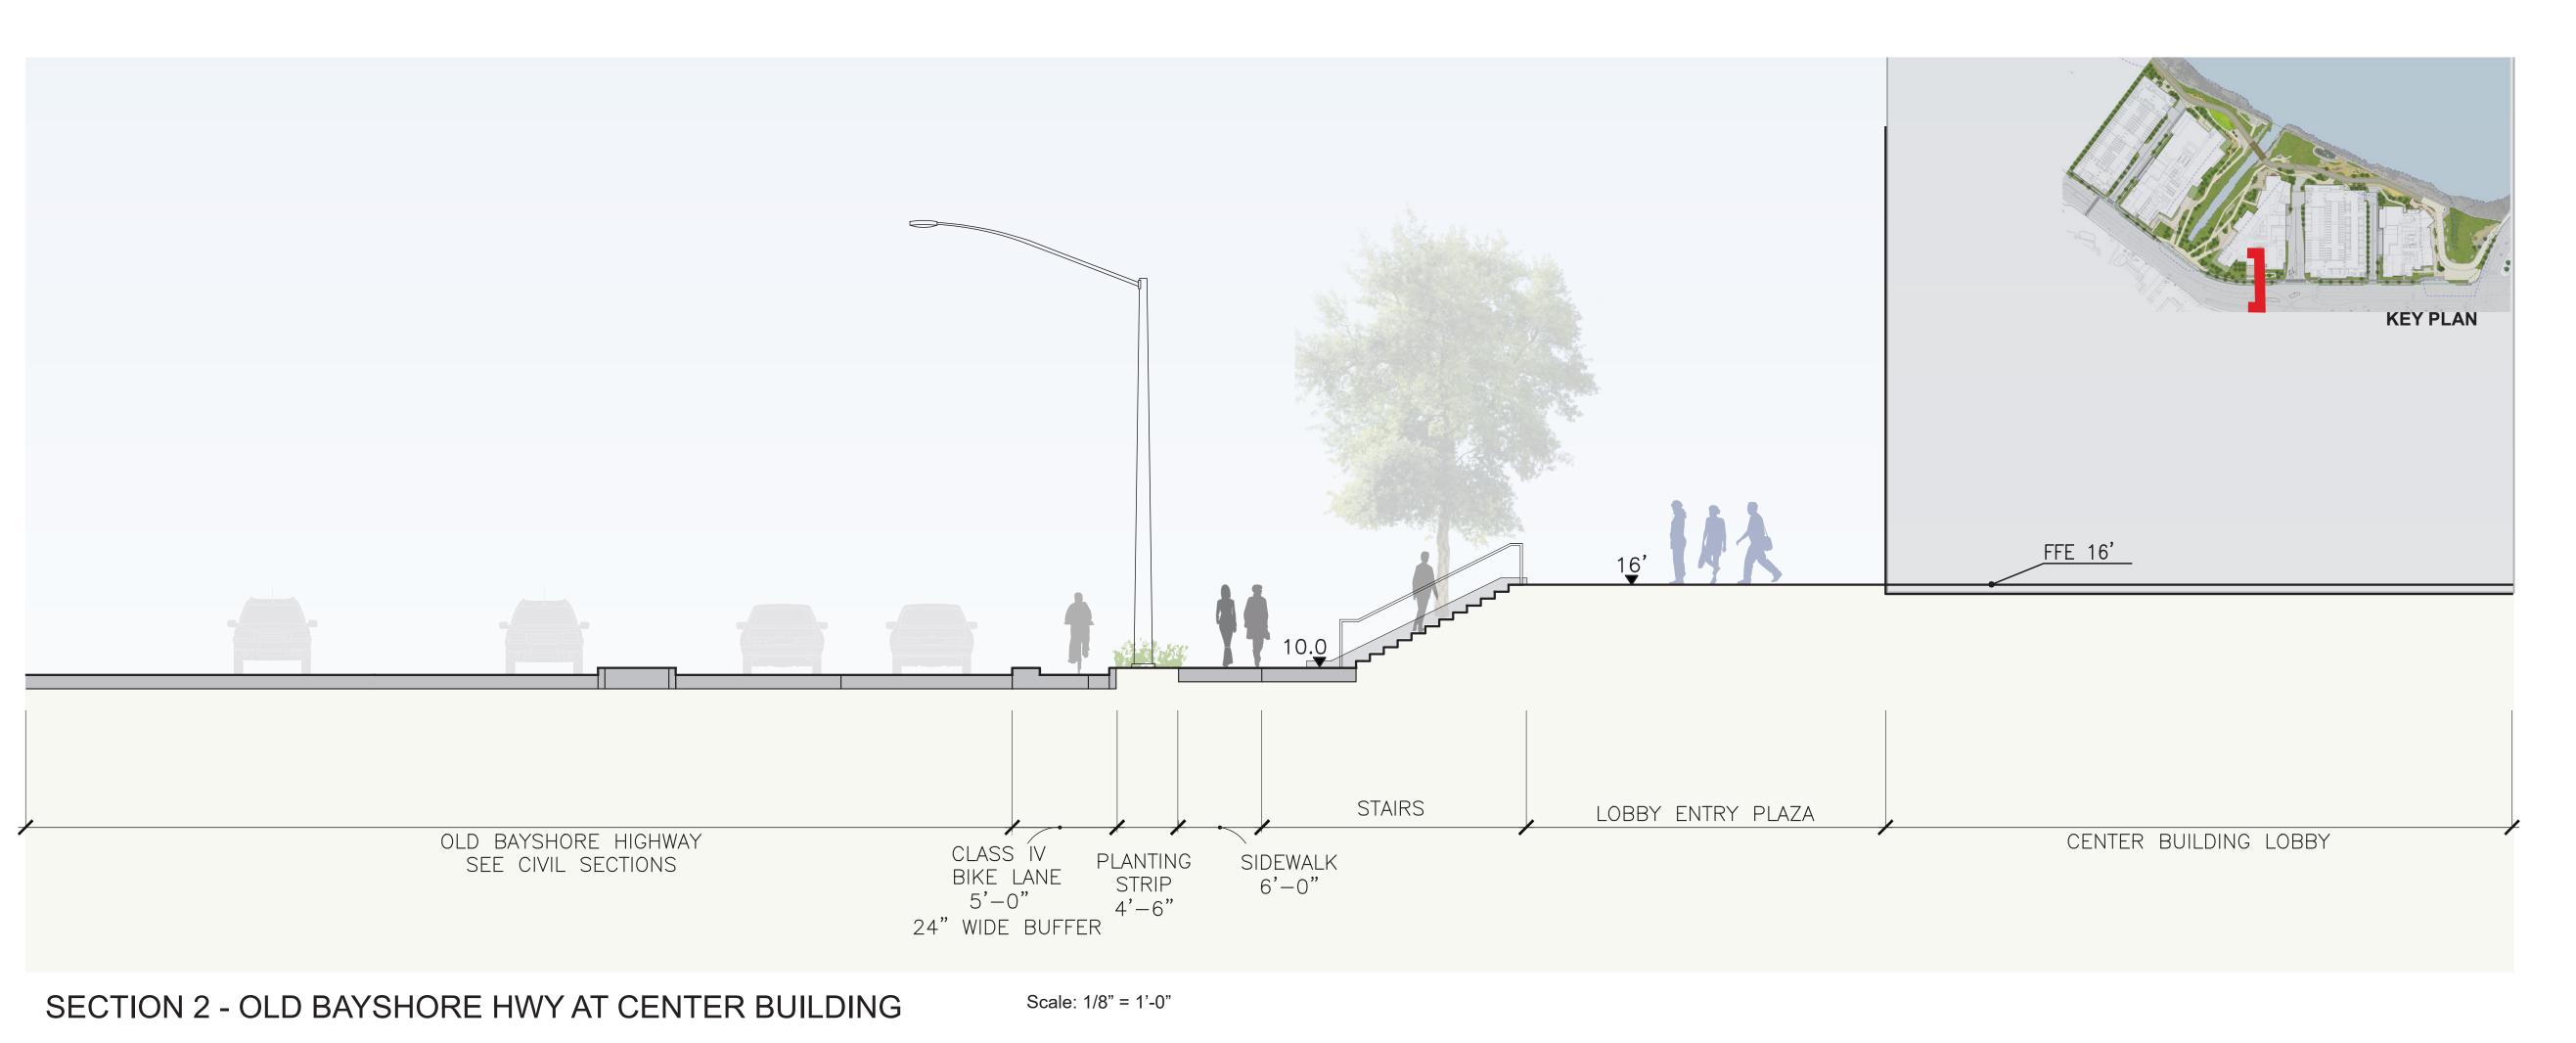

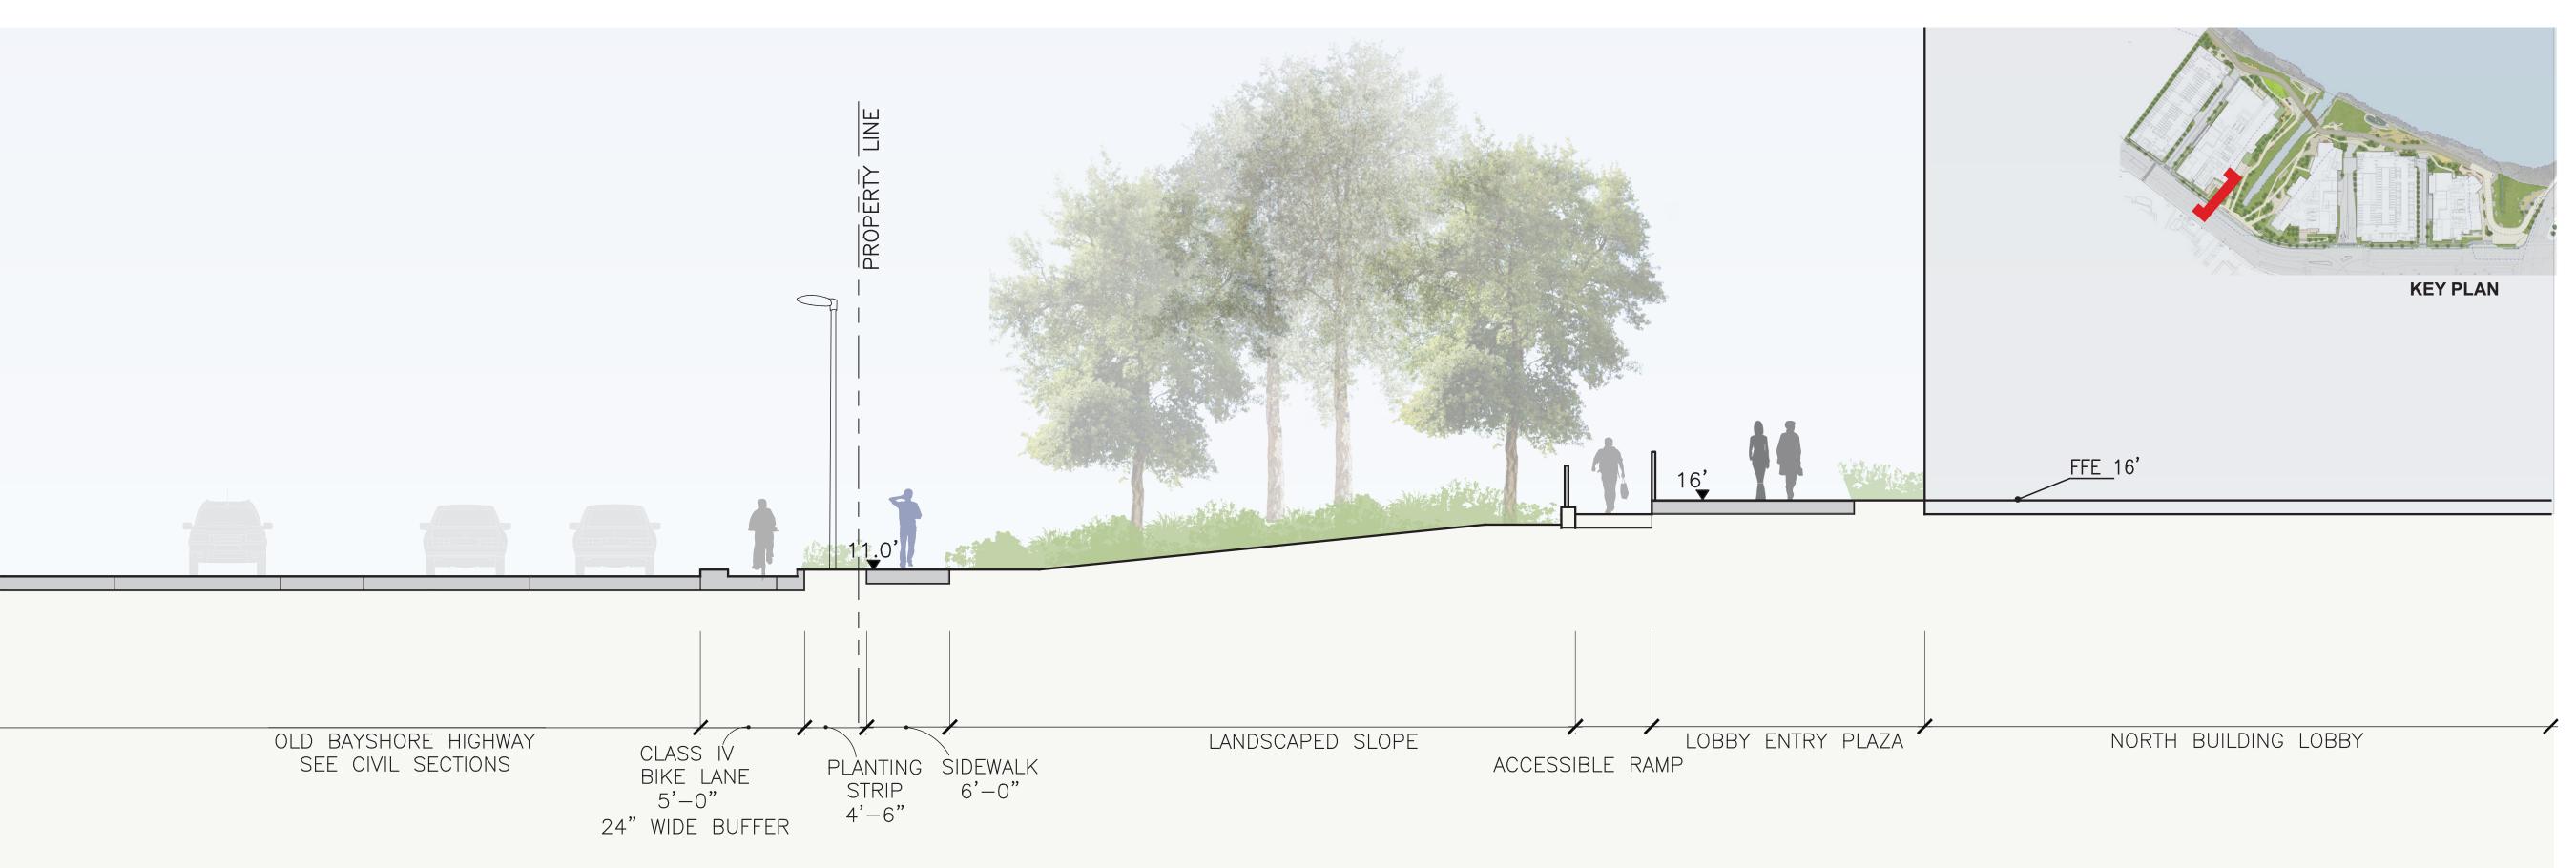

SECTION 1 - OLD BAYSHORE HWY AT NORTH BUILDING

Scale: 1/8" = 1'-0"

WRNSSTUDIO

501 SECOND STREET 4TH FLOOR, STE. 402 SAN FRANCISCO CALIFORNIA 94107 415.489.2224 TEL 415.358.9100 FAX WWW.WRNSSTUDIO.COM










moffatt & nicho

WATT

ISSUES	DAT
ENTITLEMENT APPLICATION	03/24/202
ENTITLEMENT APPLICATION #2	08/19/202
ENTITLEMENT APPLICATION #3	12/09/202
ENTITLEMENT APPLICATION #4	09/18/202

Peninsula Crossing 1200-1340 Old Bayshore Hwy, Burlingame, CA 94010

KEYPLAN

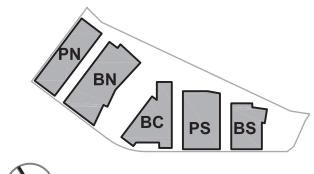



PROJECT NO.: 20045.00 DATE: 08/19/2022 SCALE: 1/8" = 1'-0"

SHEET TITLE:

SITE SECTIONS


ENT L-404

All drawings and written material appearing herein constitute original and unpublished work of the
Architect/Engineer and may not be duplicated, used or disclosed without consent of Architect/Engineer.

If this drawing is not 24
Noted scales must be



501 SECOND STREET 4TH FLOOR, STE. 402 SAN FRANCISCO CALIFORNIA 94107 415.489.2224 TEL 415.358.9100 FAX WWW.WRNSSTUDIO.COM

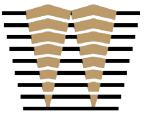

WATRY DESIGN, INC.

Architects • Engineers • Parking Planners

CMG






WATT

ISSUES	DATE
ENTITLEMENT APPLICATION	03/24/2022
ENTITLEMENT APPLICATION #2	08/19/2022
ENTITLEMENT APPLICATION #3	12/09/2022
ENTITLEMENT APPLICATION #4	09/18/2023

Peninsula Crossing
1200-1340 Old Bayshore Hwy, Burlingame, CA 94010

KEYPLAN

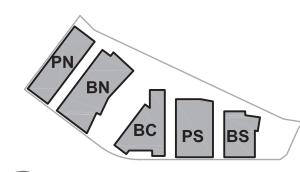



PROJECT NO.: 20045.00 DATE: 08/19/2022 SCALE: 1"=50'

SHEET TITLE:


CONCEPTUAL ART PROGRAM PLAN



SHEET NO:



501 SECOND STREET 4TH FLOOR, STE. 402 SAN FRANCISCO CALIFORNIA 94107 415.489.2224 TEL 415.358.9100 FAX WWW.WRNSSTUDIO.COM

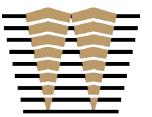

WATRY DESIGN, INC.
Architects • Engineers • Parking Planners

CMG








WATT

ISSUES	DATE
ENTITLEMENT APPLICATION	03/24/2022
ENTITLEMENT APPLICATION #2	08/19/2022
ENTITLEMENT APPLICATION #3	12/09/2022
ENTITLEMENT APPLICATION #4	09/18/2023

Peninsula Crossing
1200-1340 Old Bayshore Hwy, Burlingame, CA 94010

KEYPLAN

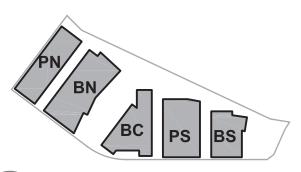




PROJECT NO.: 20045.00 DATE: 08/19/2022

SCALE: 1"=50'

SHEET TITLE:

CONCEPTUAL SIGNAGE PLAN

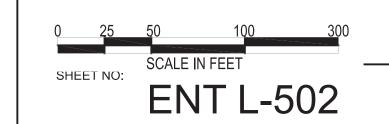

CIVIL NOTES:

TIDAL PLANE	NAVD88 DATUM (FEET
KING TIDE	+8.41
MEAN HIGHER HIGH WATER (MHHW)	+6.83
MEAN HIGH WATER (MHW)	+6.21
MEAN SEA LEVEL (MSL)	+3.33
MEAN LOW WATER (MLW)	+0.40
NORTH AMERICAN VERTICAL DATUM OF 1988 (NAVD88)	0.00
MEAN LOWER LOW WATER (MLLW)	-0.79
FEMA ONE PERCENT ANNUAL CHANCE FLOOD ELEVATIONS	NAVD88 DATUM (FEET)
BASE FLOOD ELEVATION (SAN FRANCISCO BAY)	+11.0
BASE FLOOD ELEVATION (EASTON CREEK)	+10.0

+10.3


STRUCTURAL NOTES:


STILLWATER ELEVATION (SWEL)


1. DESIGN LOADING:

- a. SEISMIC DESIGN: CALTRANS SEISMIC DESIGN CRITERIA (SDC), VERSION 2.0, DATED APRIL 2019.
- b. DEADLOAD: 150 pcf FOR REINFORCED CONCRETE 490 pfc FOR STEEL.
- c. LIVELOAD: HL-93 WITH "LOWBAY" AND P-15 DESIGN VEHICLE COMBINED WITH 90 psf PEDESTRIAN LOADING.
- d. EARTH LOADS: AT-REST PRESSURE = 60pcf
 STATIC ACTIVE PRESSURE = 35 pcf
 SEISMIC ACTIVE INCREMENT PRESSURE = 25 pcf

CROSS-REFERENCE LEGEND

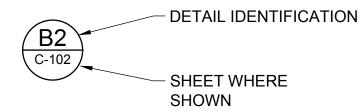

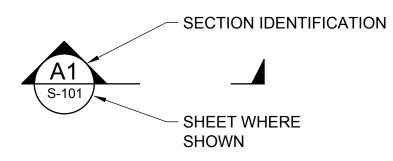

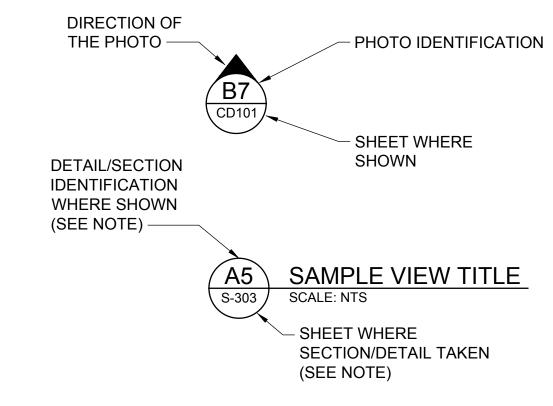

ABBREVIATIONS:

	AASHTO	AMERICAN ASSOCIATION OF STATE HIGHWAY AND TRANSPORTATION OFFICIALS
--	--------	--

ABUT ABUTMENT

ACBM ARTICULATED CONCRETE BLOCK MAT

APPROX APPROXIMATELY

BB BEGIN BRIDGE

BCDC BAY CONSERVATION AND DEVELOPMENT COMMISSION

BFE BASE FLOOD ELEVATION

BIV BOX-IV

CA CALIFORNIA

CIP CAST-IN-PLACE

CLSM CONTROLLED LOW STRENGTH MATERIAL

CONC CONCRETE

(E) EXISTING

EB END BRIDGE

ELEV ELEVATION

FEMA FEDERAL EMERGENCY MANAGEMENT AGENCY

FFE FINISH FLOOR ELEVATION

HTL HIGH TIDE LINE

L.O.W LIMIT OF WORK

MHHW MEAN HIGHER HIGH WATER

MHW MEAN HIGH WATER

MIN. MINIMUM

MSL MEAN SEA LEVEL

NAVD88 NORTH AMERICAN VERTICAL DATUM OF 1988

PC PRECAST

PCF POUNDS PER CUBIC FEET

PS PRESTRESSED

PSF POUNDS PER SQUARE FEET

RSP ROCK SLOPE PROTECTION

SD STORM DRAIN

SS SHORELINE STRUCTURE(S)

ST STANDARD

TYP TYPICAL

WRNSSTUDIO

501 SECOND STREET 4TH FLOOR, STE. 402 SAN FRANCISCO CALIFORNIA 94107 415. 489. 2224 TEL 415. 358. 9100 FAX WWW.WRNSSTUDIO.COM











moffatt & nic

WATT

ISSUES	DATE
ENTITLEMENT APPLICATION	03/24/2022
ENTITLEMENT APPLICATION #2	08/19/2022
ENTITLEMENT APPLICATION #3	12/09/2022
ENTITLEMENT APPLICATION #4	09/18/2023

KEYPLAN

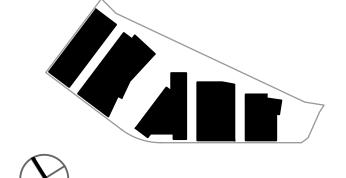

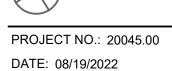

SCALE: NTS
SHEET TITLE:


NOTES, LEGEND, AND ABBREVIATIONS

SHEET NO:

ENT SS-001

All drawings and written material appearing berein constitute original and unpublished work of the

If this drawing is not 2/1"v26" than the drawing has been revised from its original size

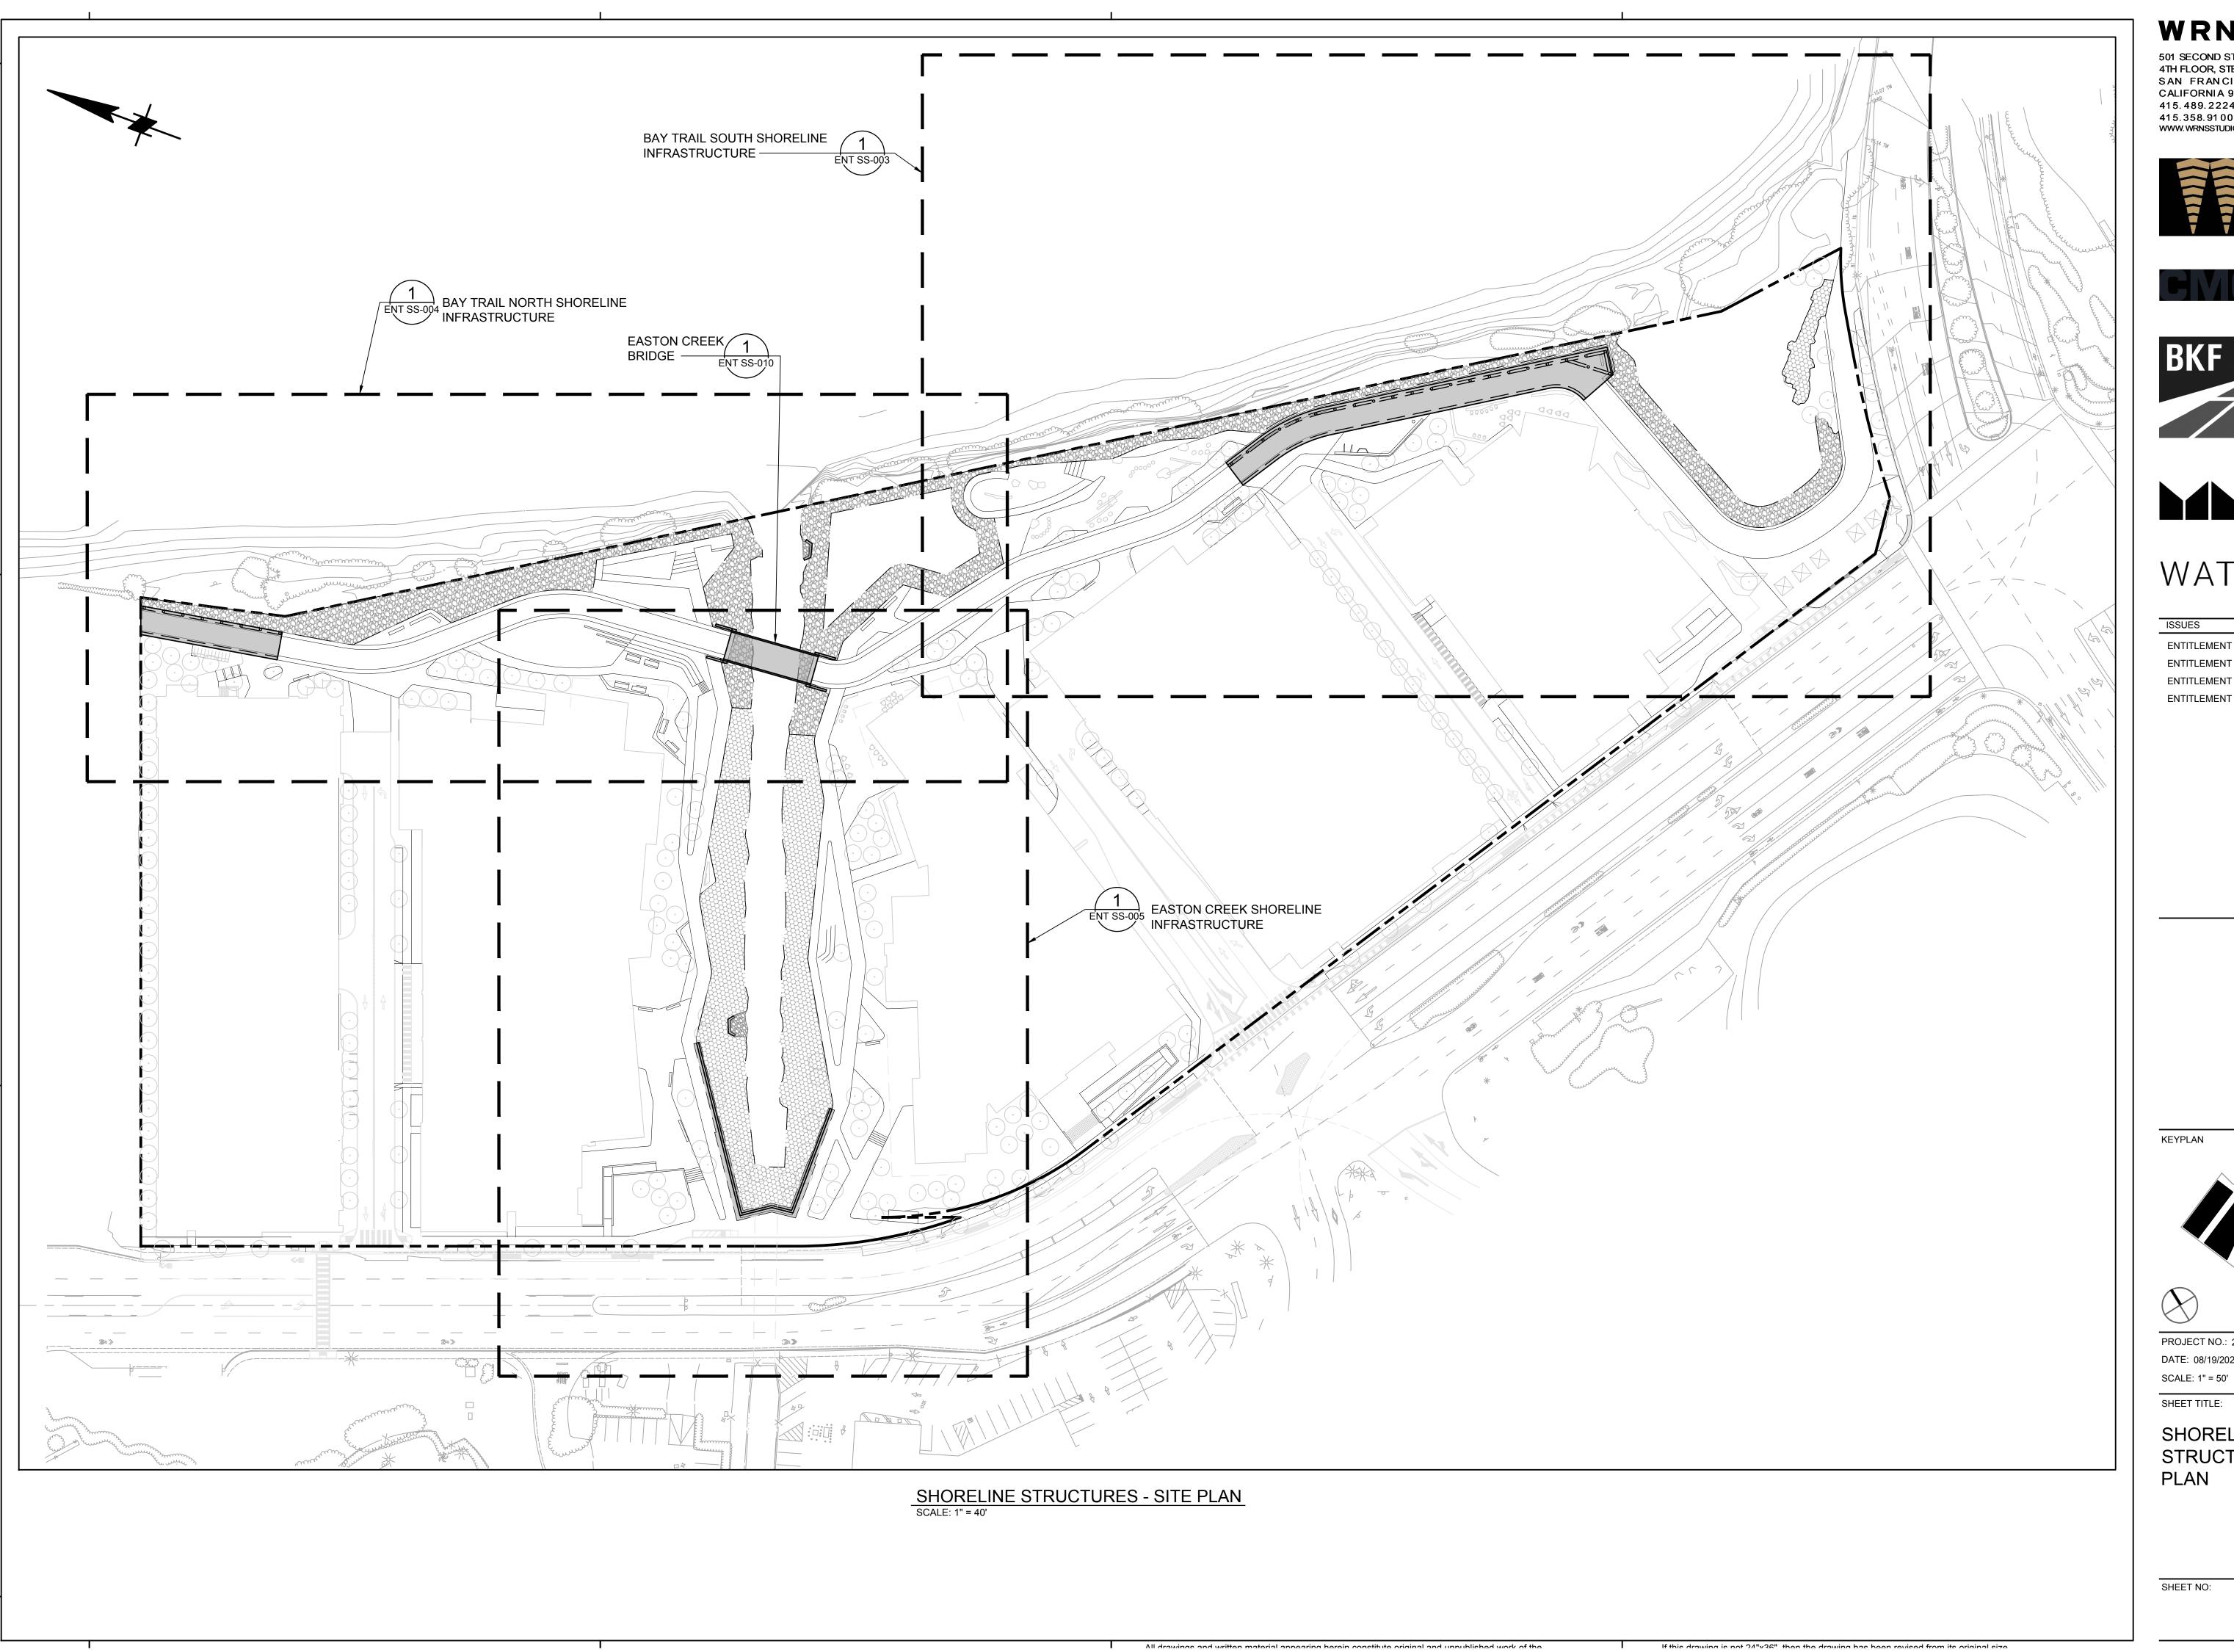

501 SECOND STREET 4TH FLOOR, STE. 402 SAN FRANCISCO CALIFORNIA 94107 415.489.2224 TEL 415.358.9100 FAX WWW.WRNSSTUDIO.COM











WATT

ISSUES	DATE
ENTITLEMENT APPLICATION	03/24/2022
ENTITLEMENT APPLICATION #2	08/19/2022
ENTITLEMENT APPLICATION #3	12/09/2022
ENTITLEMENT APPLICATION #4	09/18/2023

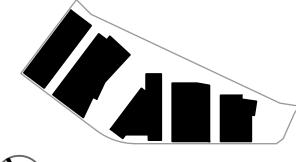

PROJECT NO.: 20045.00 DATE: 08/19/2022

SHORELINE STRUCTURES - SITE

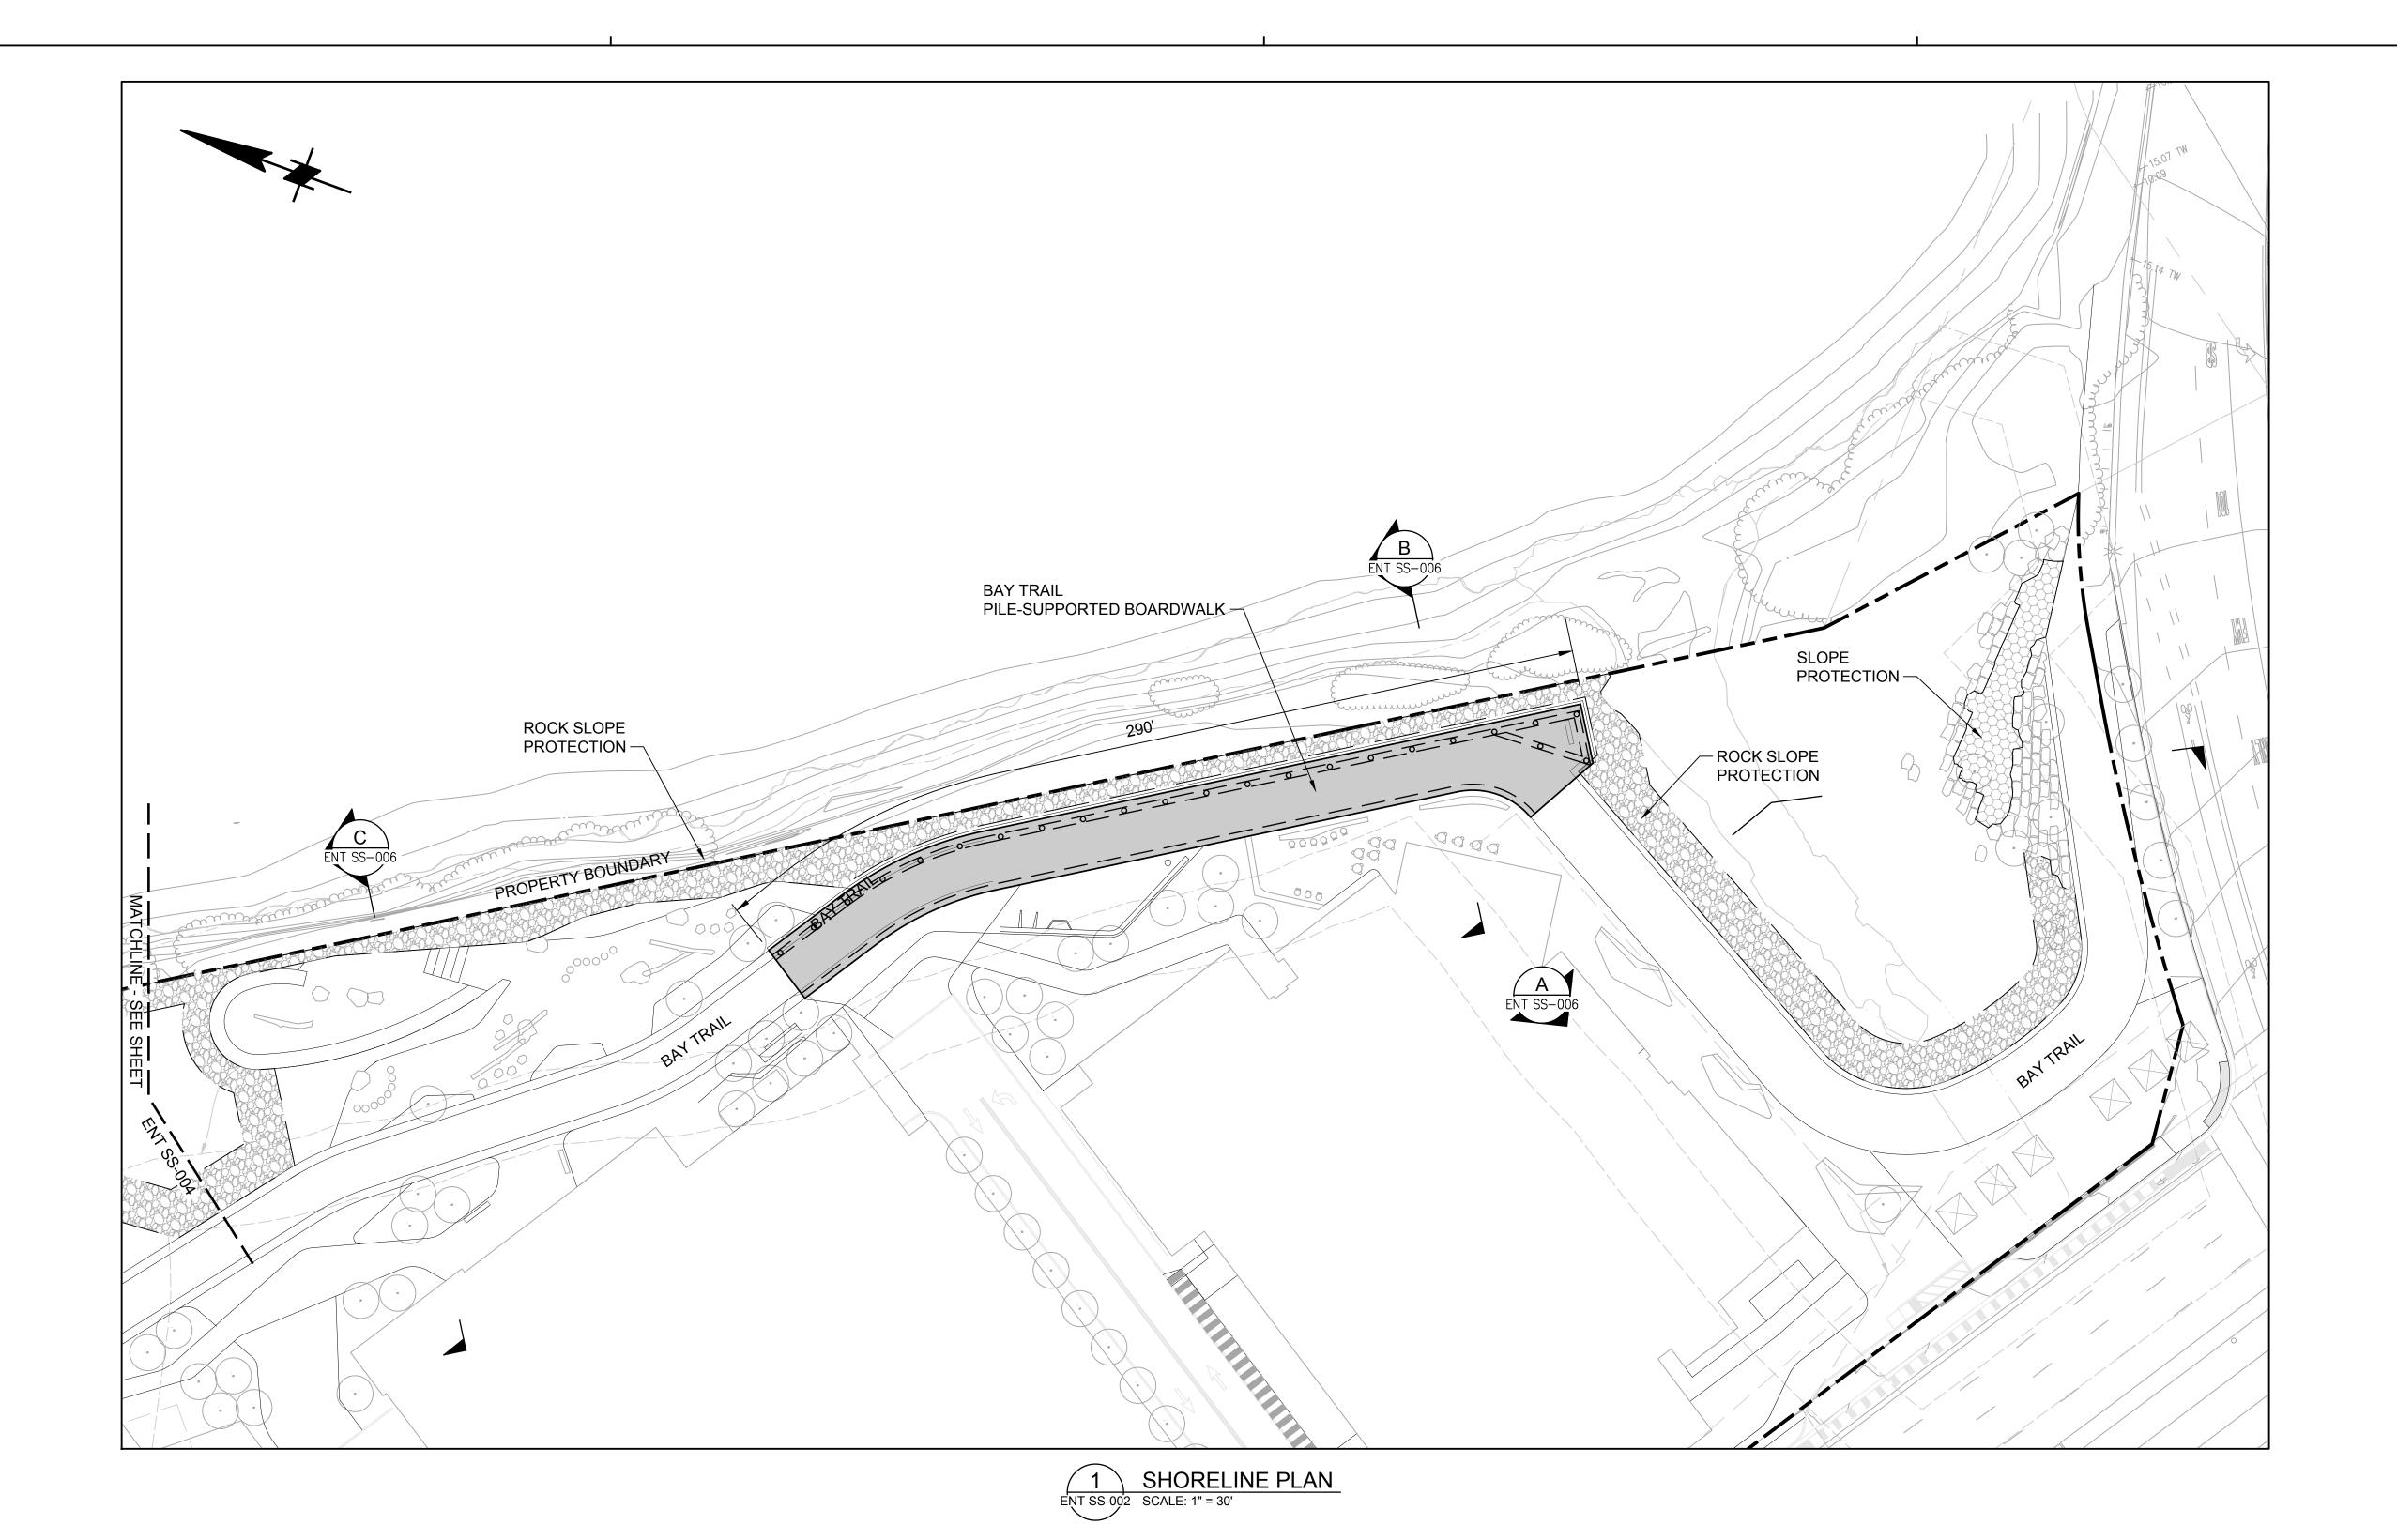

All drawings and written material annearing herein constitute original and unnublished work of the

WRNSSTUDIO

501 SECOND STREET
4TH FLOOR, STE. 402
SAN FRANCISCO
CALIFORNIA 94107
415.489.2224 TEL
415.358.9100 FAX
WWW.WRNSSTUDIO.COM










moffatt & nich

WATT

ISSUES	DATE
ENTITLEMENT APPLICATION	03/24/2022
ENTITLEMENT APPLICATION #2	08/19/2022
ENTITLEMENT APPLICATION #3	12/09/2022
ENTITLEMENT APPLICATION #4	09/18/2023

KEYPLAN

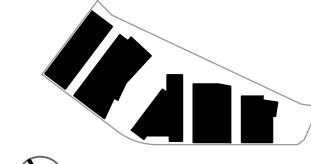




PROJECT NO.: 20045.00 DATE: 08/19/2022 SCALE: 1:30

SHEET TITLE:

SHORELINE STRUCTURES PLAN - SOUTH

SHEET

If this drawing is not 21"v26" than the drawing has been revised from its original size

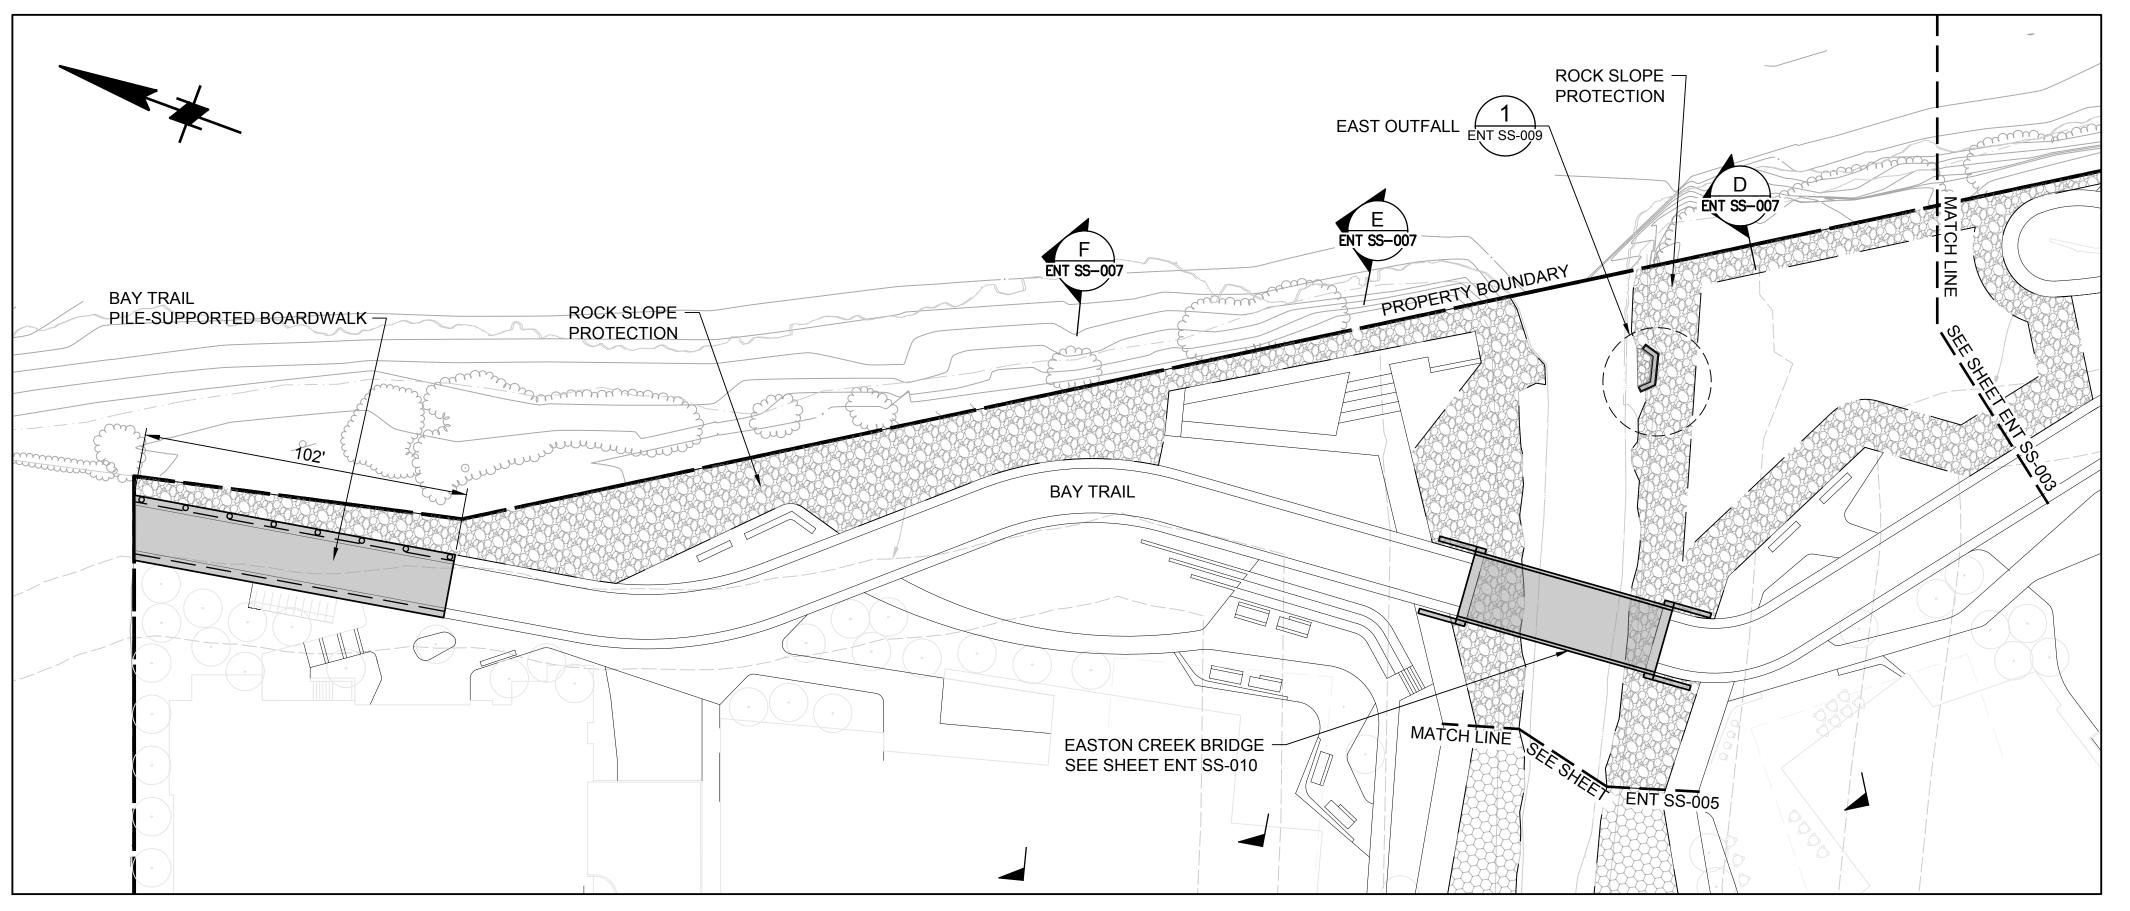

SHORELINE PLAN
ENT SS-002 SCALE: 1" = 30'

All drawings and written material appearing herein constitute original and unpublished work of the

WRNSSTUDIO

501 SECOND STREET 4TH FLOOR, STE. 402 SAN FRANCISCO CALIFORNIA 941 07 415.489.2224 TEL 415.358.91 00 FAX WWW.WRNSSTUDIO.COM










moffatt & nicho

WATT

ISSUES	DATE
ENTITLEMENT APPLICATION	03/24/202
ENTITLEMENT APPLICATION #2	08/19/202
ENTITLEMENT APPLICATION #3	12/09/202
ENTITLEMENT APPLICATION #4	09/18/202

KEYPLAN

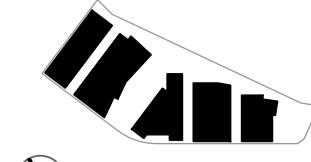



PROJECT NO.: 20045.00 DATE: 08/19/2022 SCALE: 1:30

SHEET TITLE:

SHORELINE STRUCTURES PLAN -NORTH

SHEET NO

If this drawing is not 21"v26" than the drawing has been revised from its original size

BAY TRAIL NORTH SHORELINE — INFRASTRUCTURE SEE SHEET ENT SS-004 MATCH LINE SLOPE PROTECTION SLOPE PROTECTION WEST OUTFALL $\left(\frac{2}{\text{ENT}}\right)$ - (E) CONCRETE RETAINING WALL EASTON CREEK SHORELINE RETAINING WALL - EASTON CREEK SHORELINE RETAINING WALL – (E) CULVERT SHORELINE PLAN ENT SS-002 SCALE: 1" = 30'

All drawings and written material appearing herein constitute original and unpublished work of the

EASTON CREEK BRIDGE -SEE SHEET ENT SS-010

WRNSSTUDIO

501 SECOND STREET 4TH FLOOR, STE. 402 SAN FRANCISCO CALIFORNIA 94107 415. 489. 2224 TEL 415. 358. 9100 FAX WWW. WRNSSTUDIO. COM










moffatt & nichd

WATT

ISSUES	DATE
ENTITLEMENT APPLICATION	03/24/2022
ENTITLEMENT APPLICATION #2	08/19/2022
ENTITLEMENT APPLICATION #3	12/09/2022
ENTITLEMENT APPLICATION #4	09/18/2023

KEYPLAN

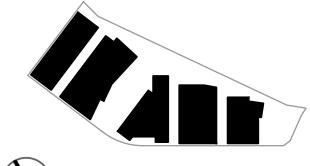




PROJECT NO.: 20045.00 DATE: 08/19/2022 SCALE: 1:30

SHEET TITLE:

SHORELINE STRUCTURES PLAN -EASTON CREEK

SHEET

If this drawing is not 24"v26" than the drawing has been revised from its original size

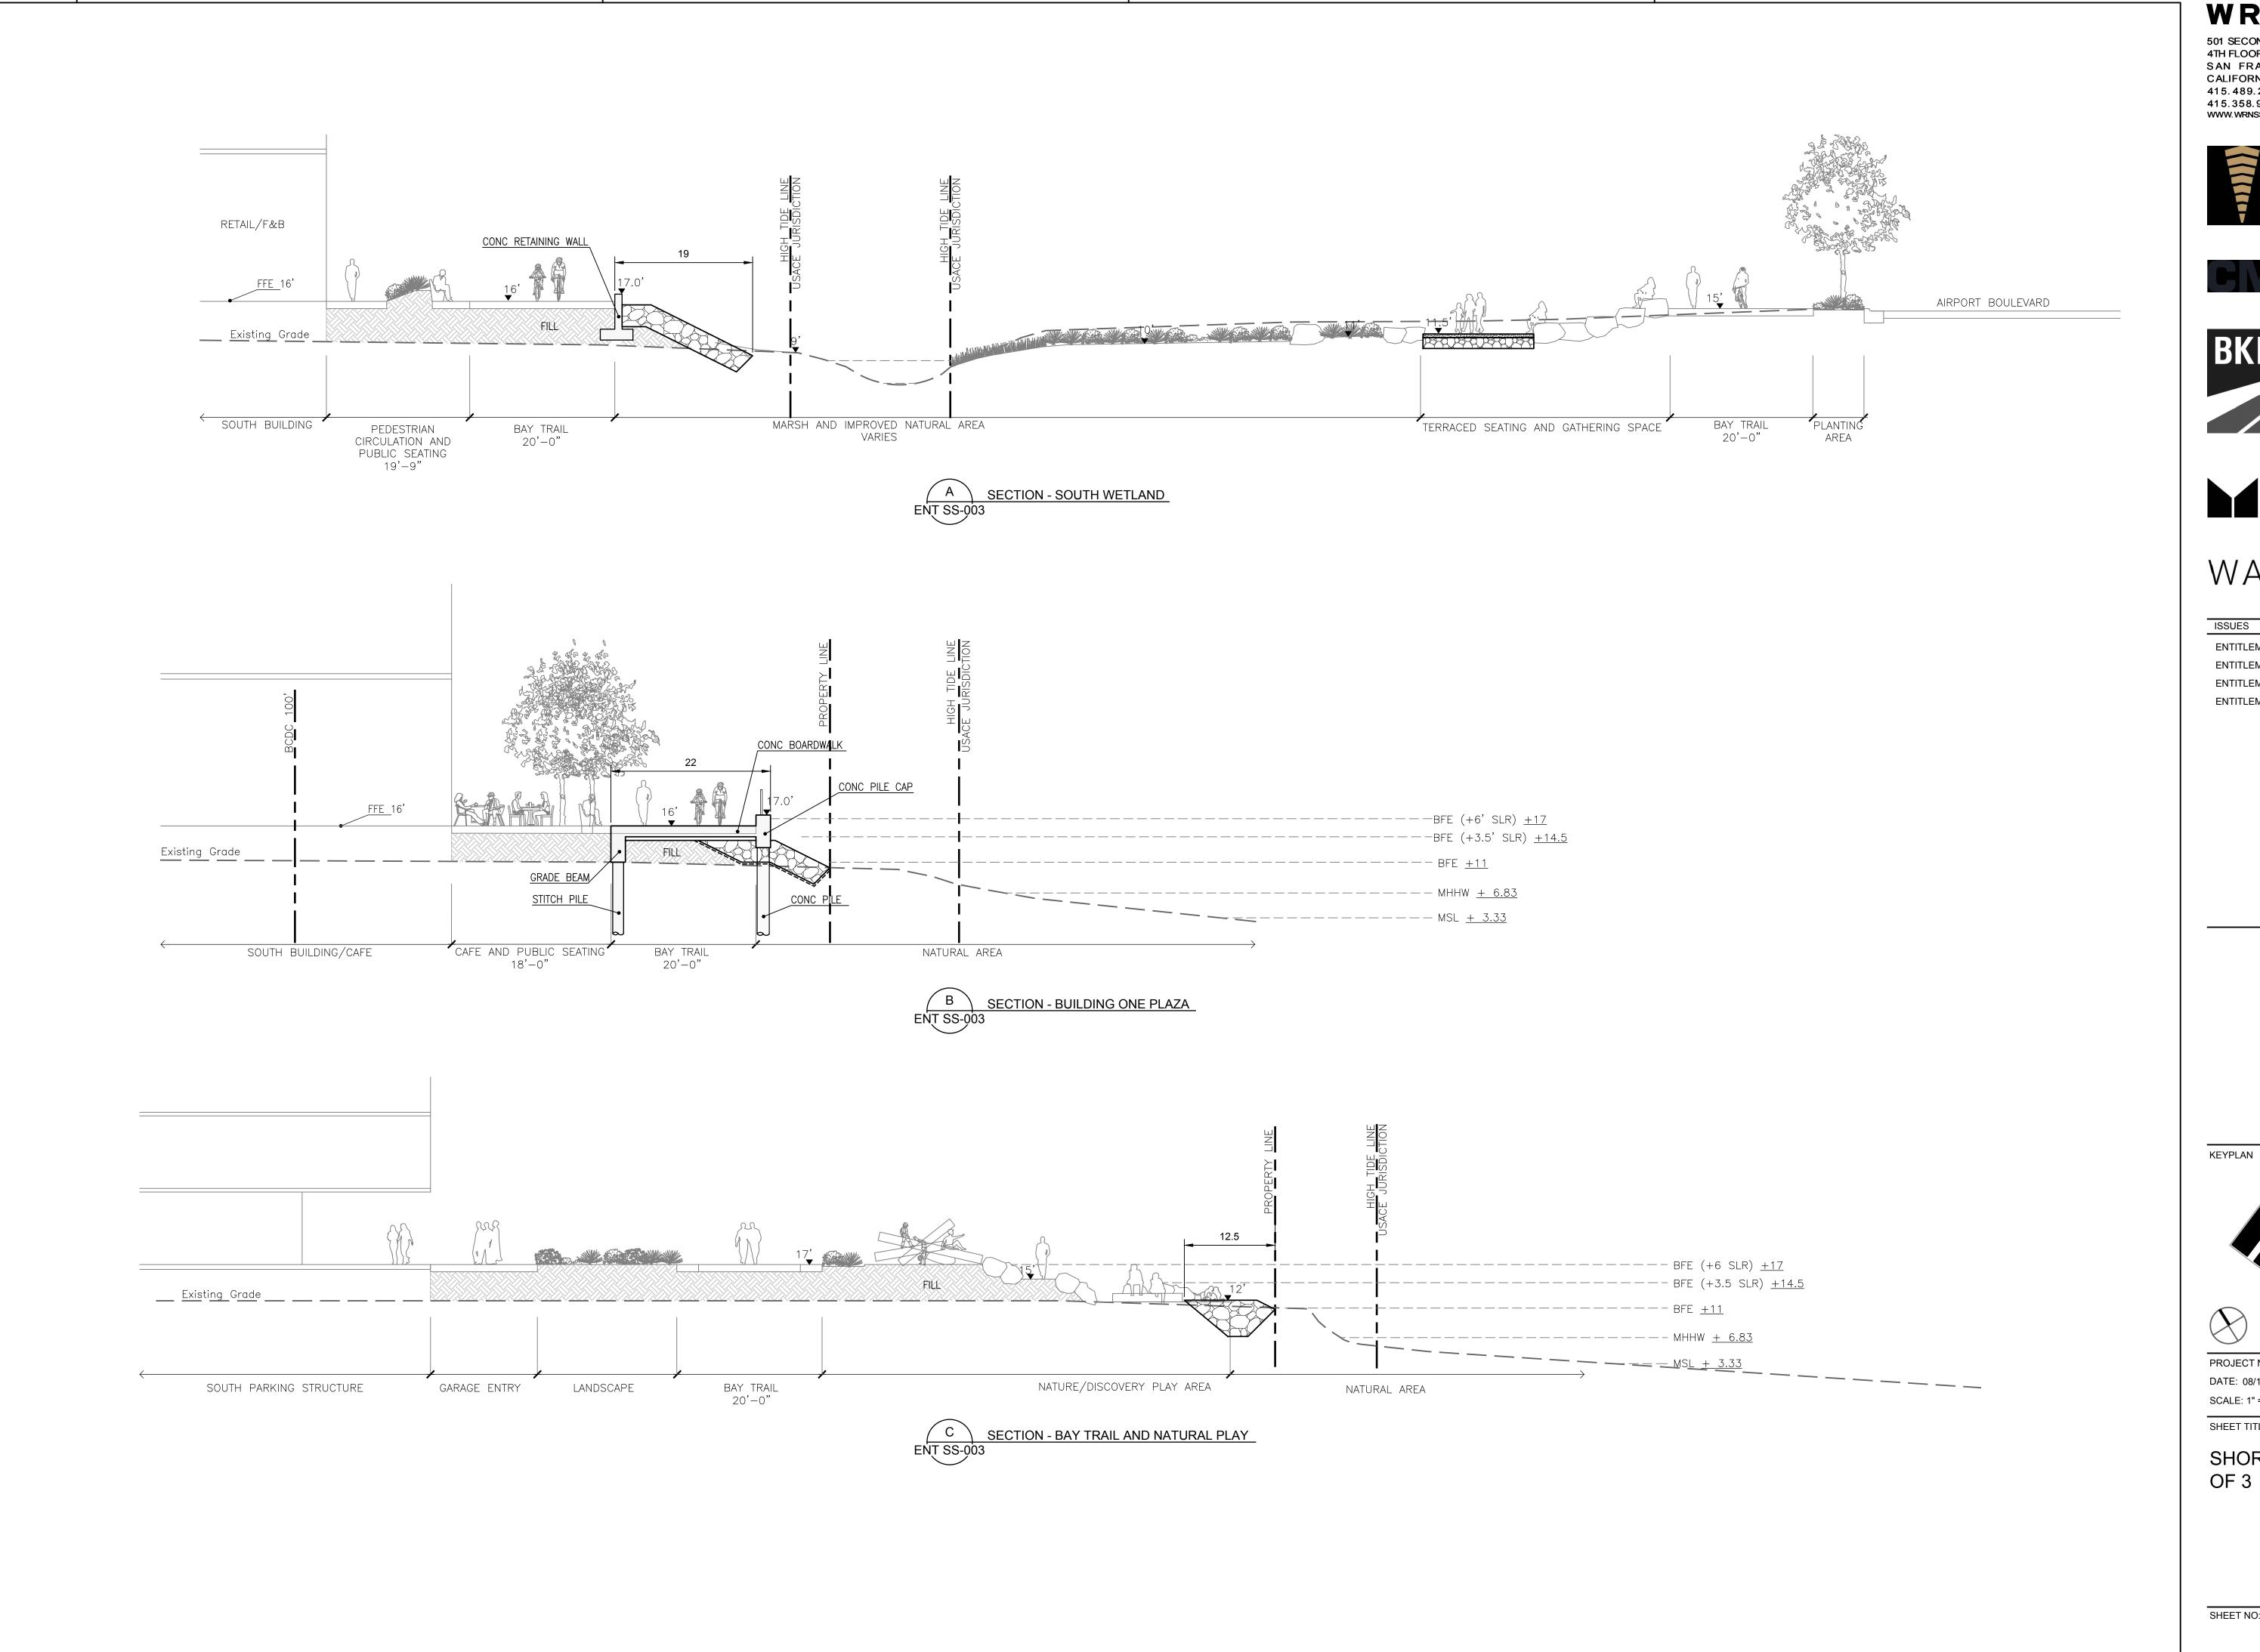

All drawings and written material appearing herein constitute original and uppublished work of the

WRNSSTUDIO

501 SECOND STREET 4TH FLOOR, STE. 402 SAN FRANCISCO CALIFORNIA 94107 415.489.2224 TEL 415.358.9100 FAX WWW.WRNSSTUDIO.COM










WATT

ISSUES	DATE
ENTITLEMENT APPLICATION	03/24/2022
ENTITLEMENT APPLICATION #2	08/19/2022
ENTITLEMENT APPLICATION #3	12/09/2022
ENTITLEMENT APPLICATION #4	09/18/2023

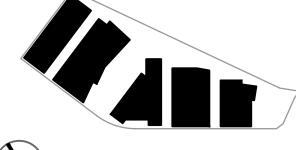


PROJECT NO.: 20045.00 DATE: 08/19/2022 SCALE: 1" = 10'

SHEET TITLE:

SHORELINE SECTIONS 1 OF 3

If this drawing is not 24"v26" than the drawing has been revised from its original size

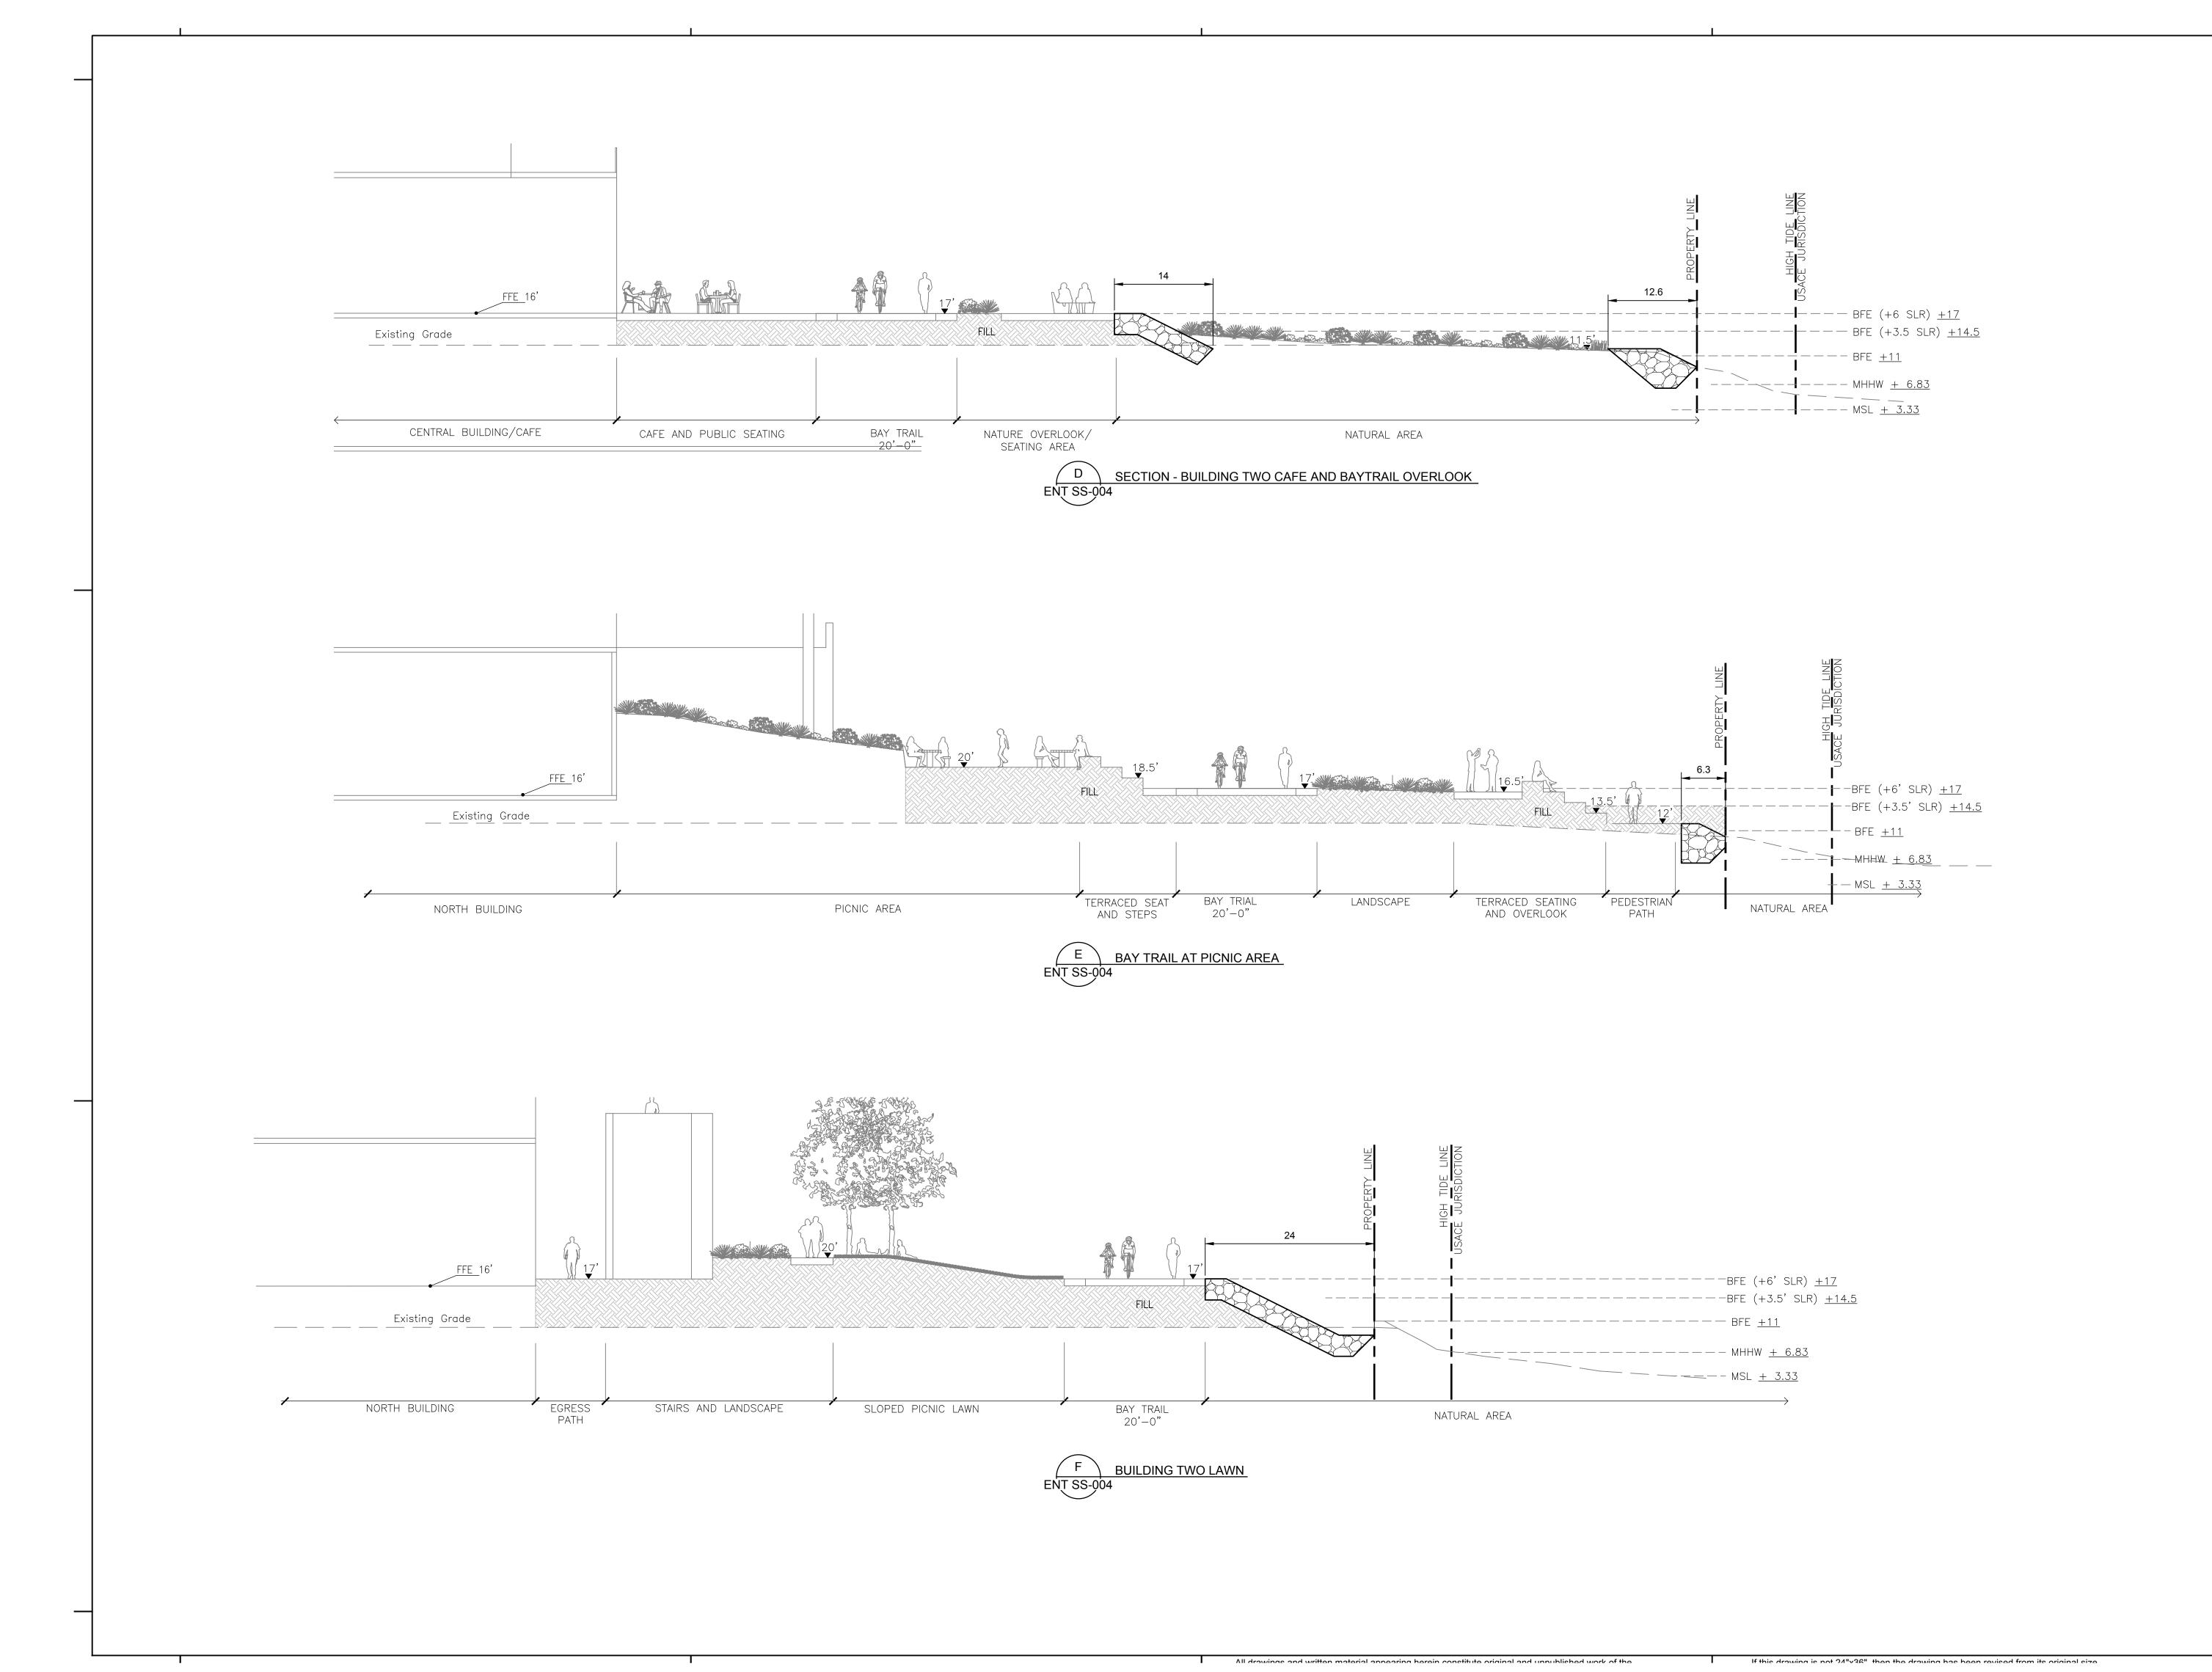

501 SECOND STREET 4TH FLOOR, STE. 402 SAN FRANCISCO CALIFORNIA 94107 415.489.2224 TEL 415.358.9100 FAX WWW.WRNSSTUDIO.COM










moffatt & nich

WATT

ISSUES	DATE
ENTITLEMENT APPLICATION	03/24/2022
ENTITLEMENT APPLICATION #2	08/19/2022
ENTITLEMENT APPLICATION #3	12/09/2022
ENTITLEMENT APPLICATION #4	09/18/2023

KEYPLAN

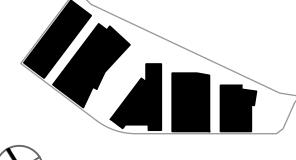




PROJECT NO.: 20045.00 DATE: 08/19/2022 SCALE: 1" = 10'

SHEET TITLE:

SHORELINE SECTIONS 2 OF 3

SHEET NO:

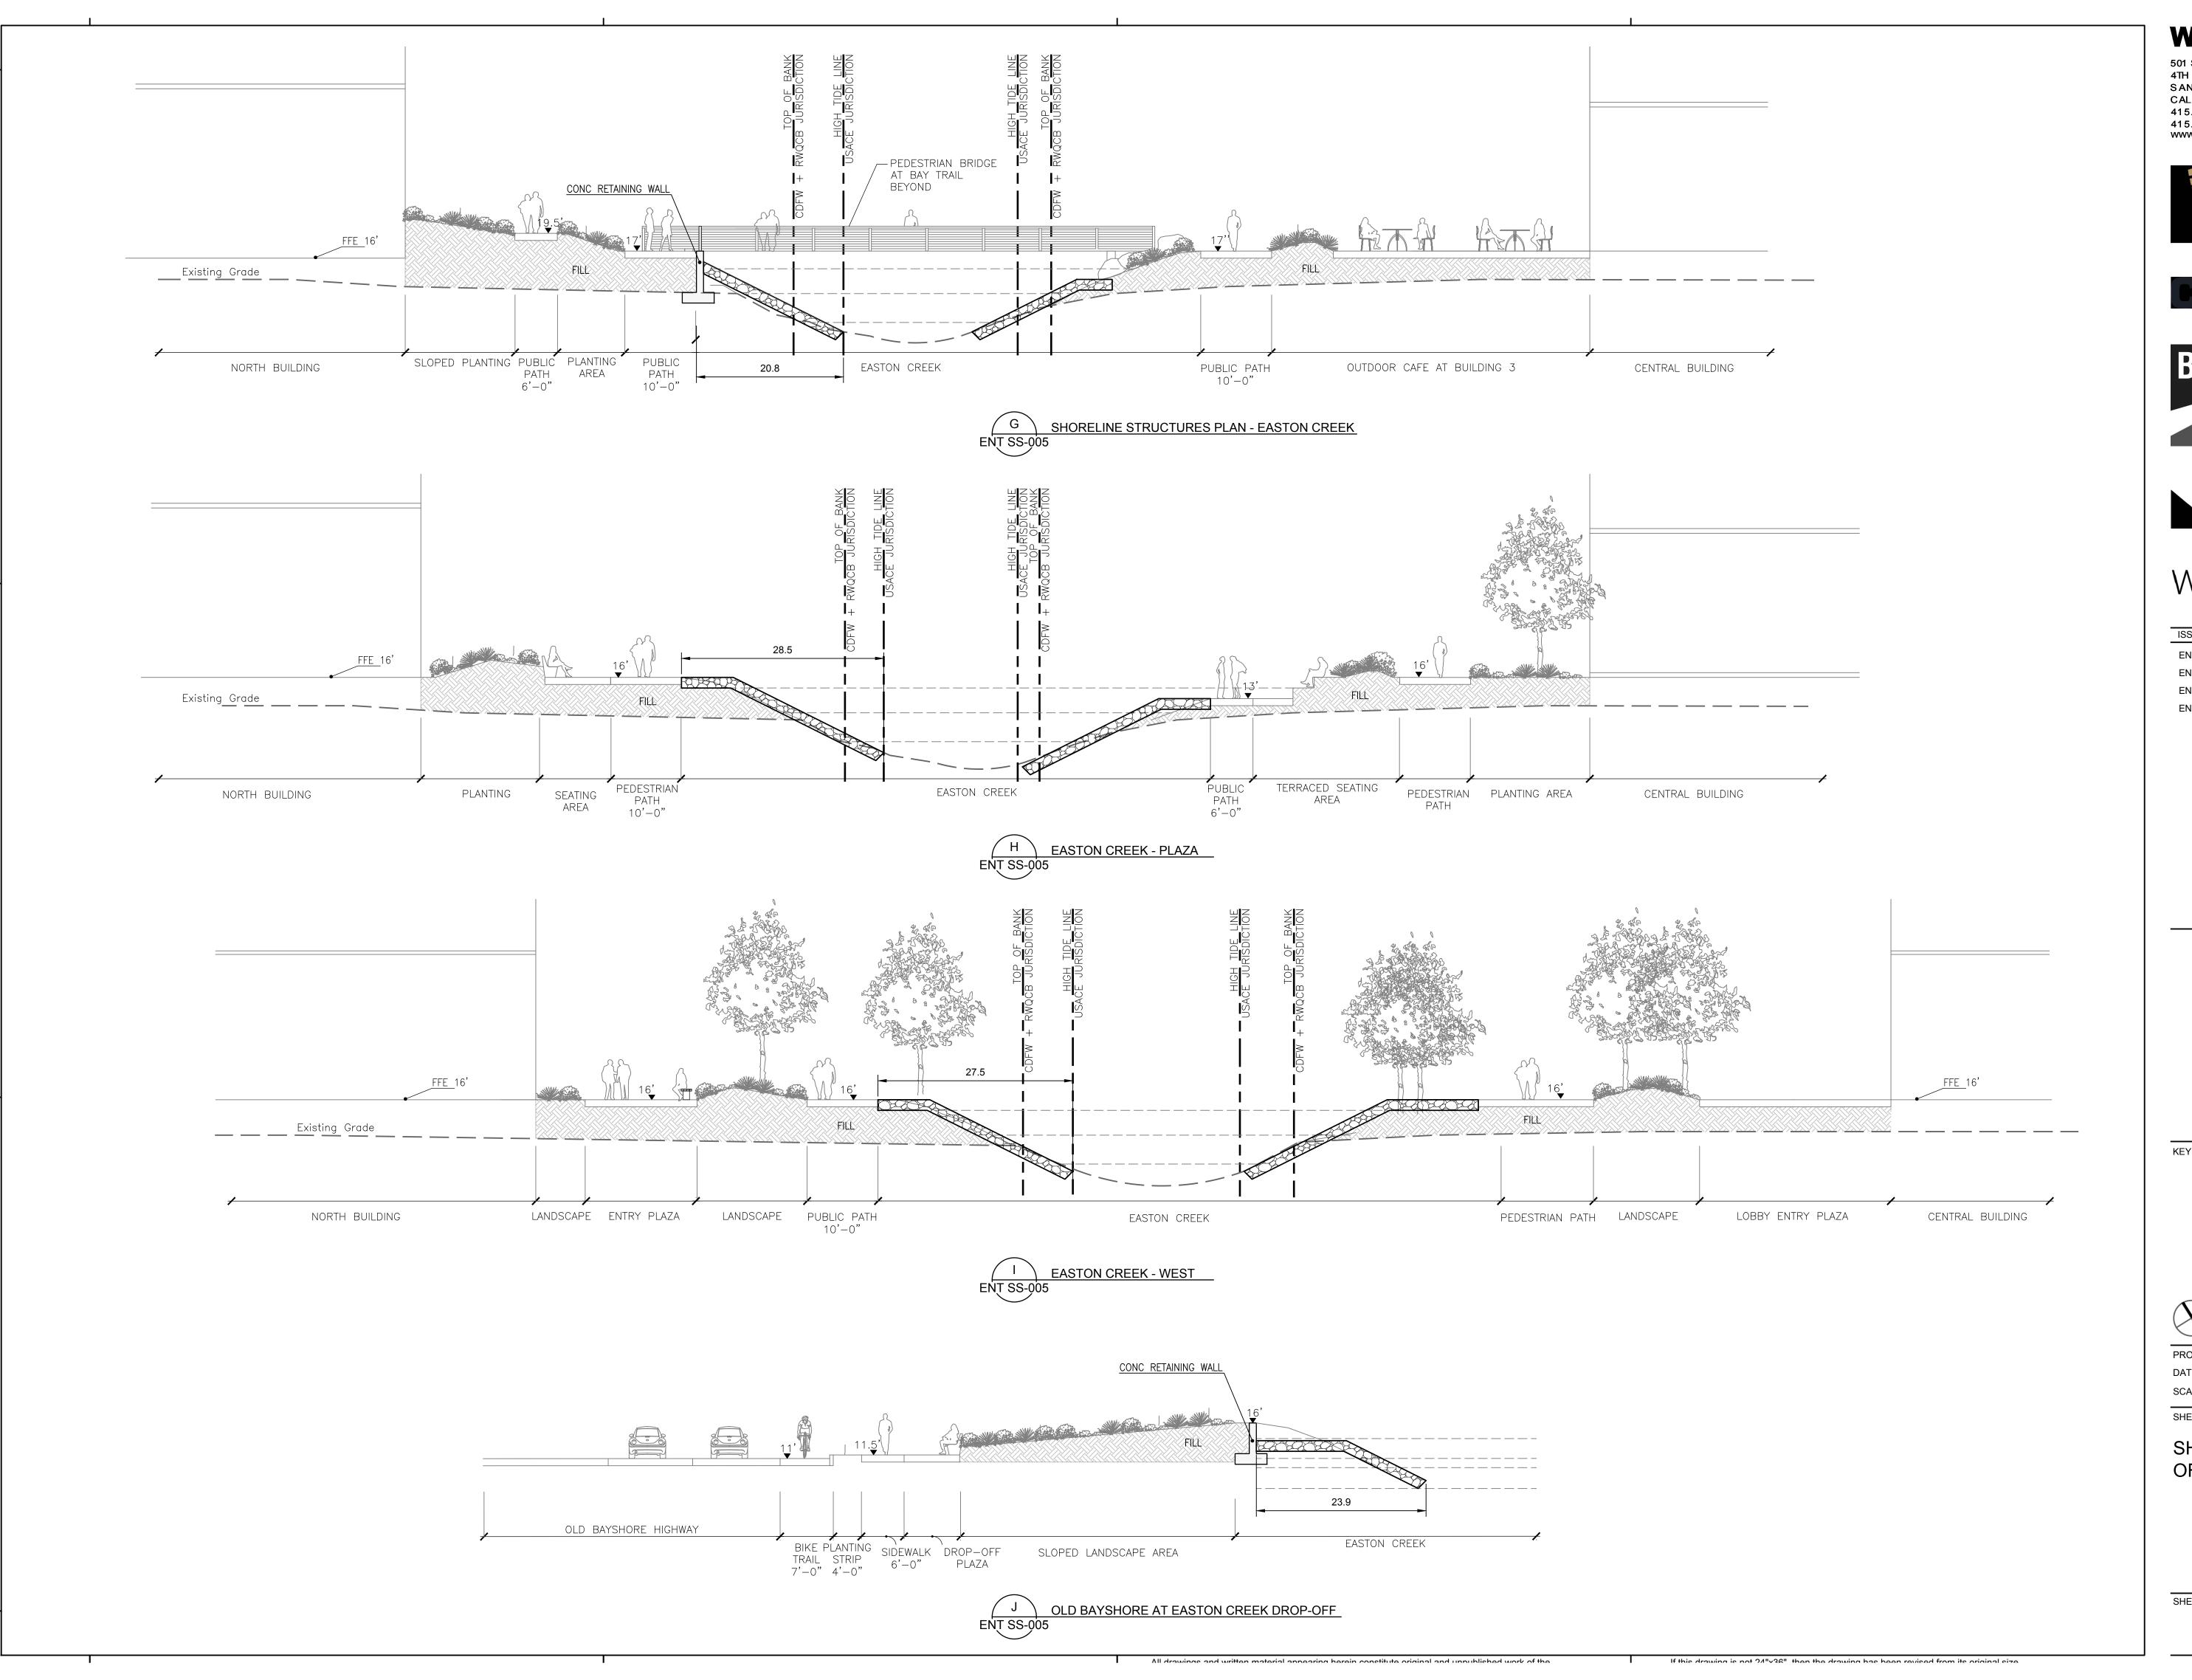

501 SECOND STREET
4TH FLOOR, STE. 402
SAN FRANCISCO
CALIFORNIA 941 07
415. 489. 2224 TEL
415. 358. 91 00 FAX
WWW.WRNSSTUDIO.COM










moffatt & nich

WATT

ISSUES	DATE
ENTITLEMENT APPLICATION	03/24/2022
ENTITLEMENT APPLICATION #2	08/19/2022
ENTITLEMENT APPLICATION #3	12/09/2022
ENTITLEMENT APPLICATION #4	09/18/2023

KEYPLAN

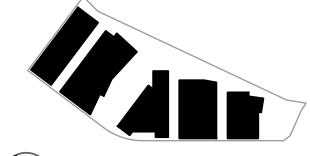




PROJECT NO.: 20045.00 DATE: 08/19/2022 SCALE: 1' = 10'

SHEET TITLE:

SHORELINE SECTIONS 3
OF 3

SHEET NO:

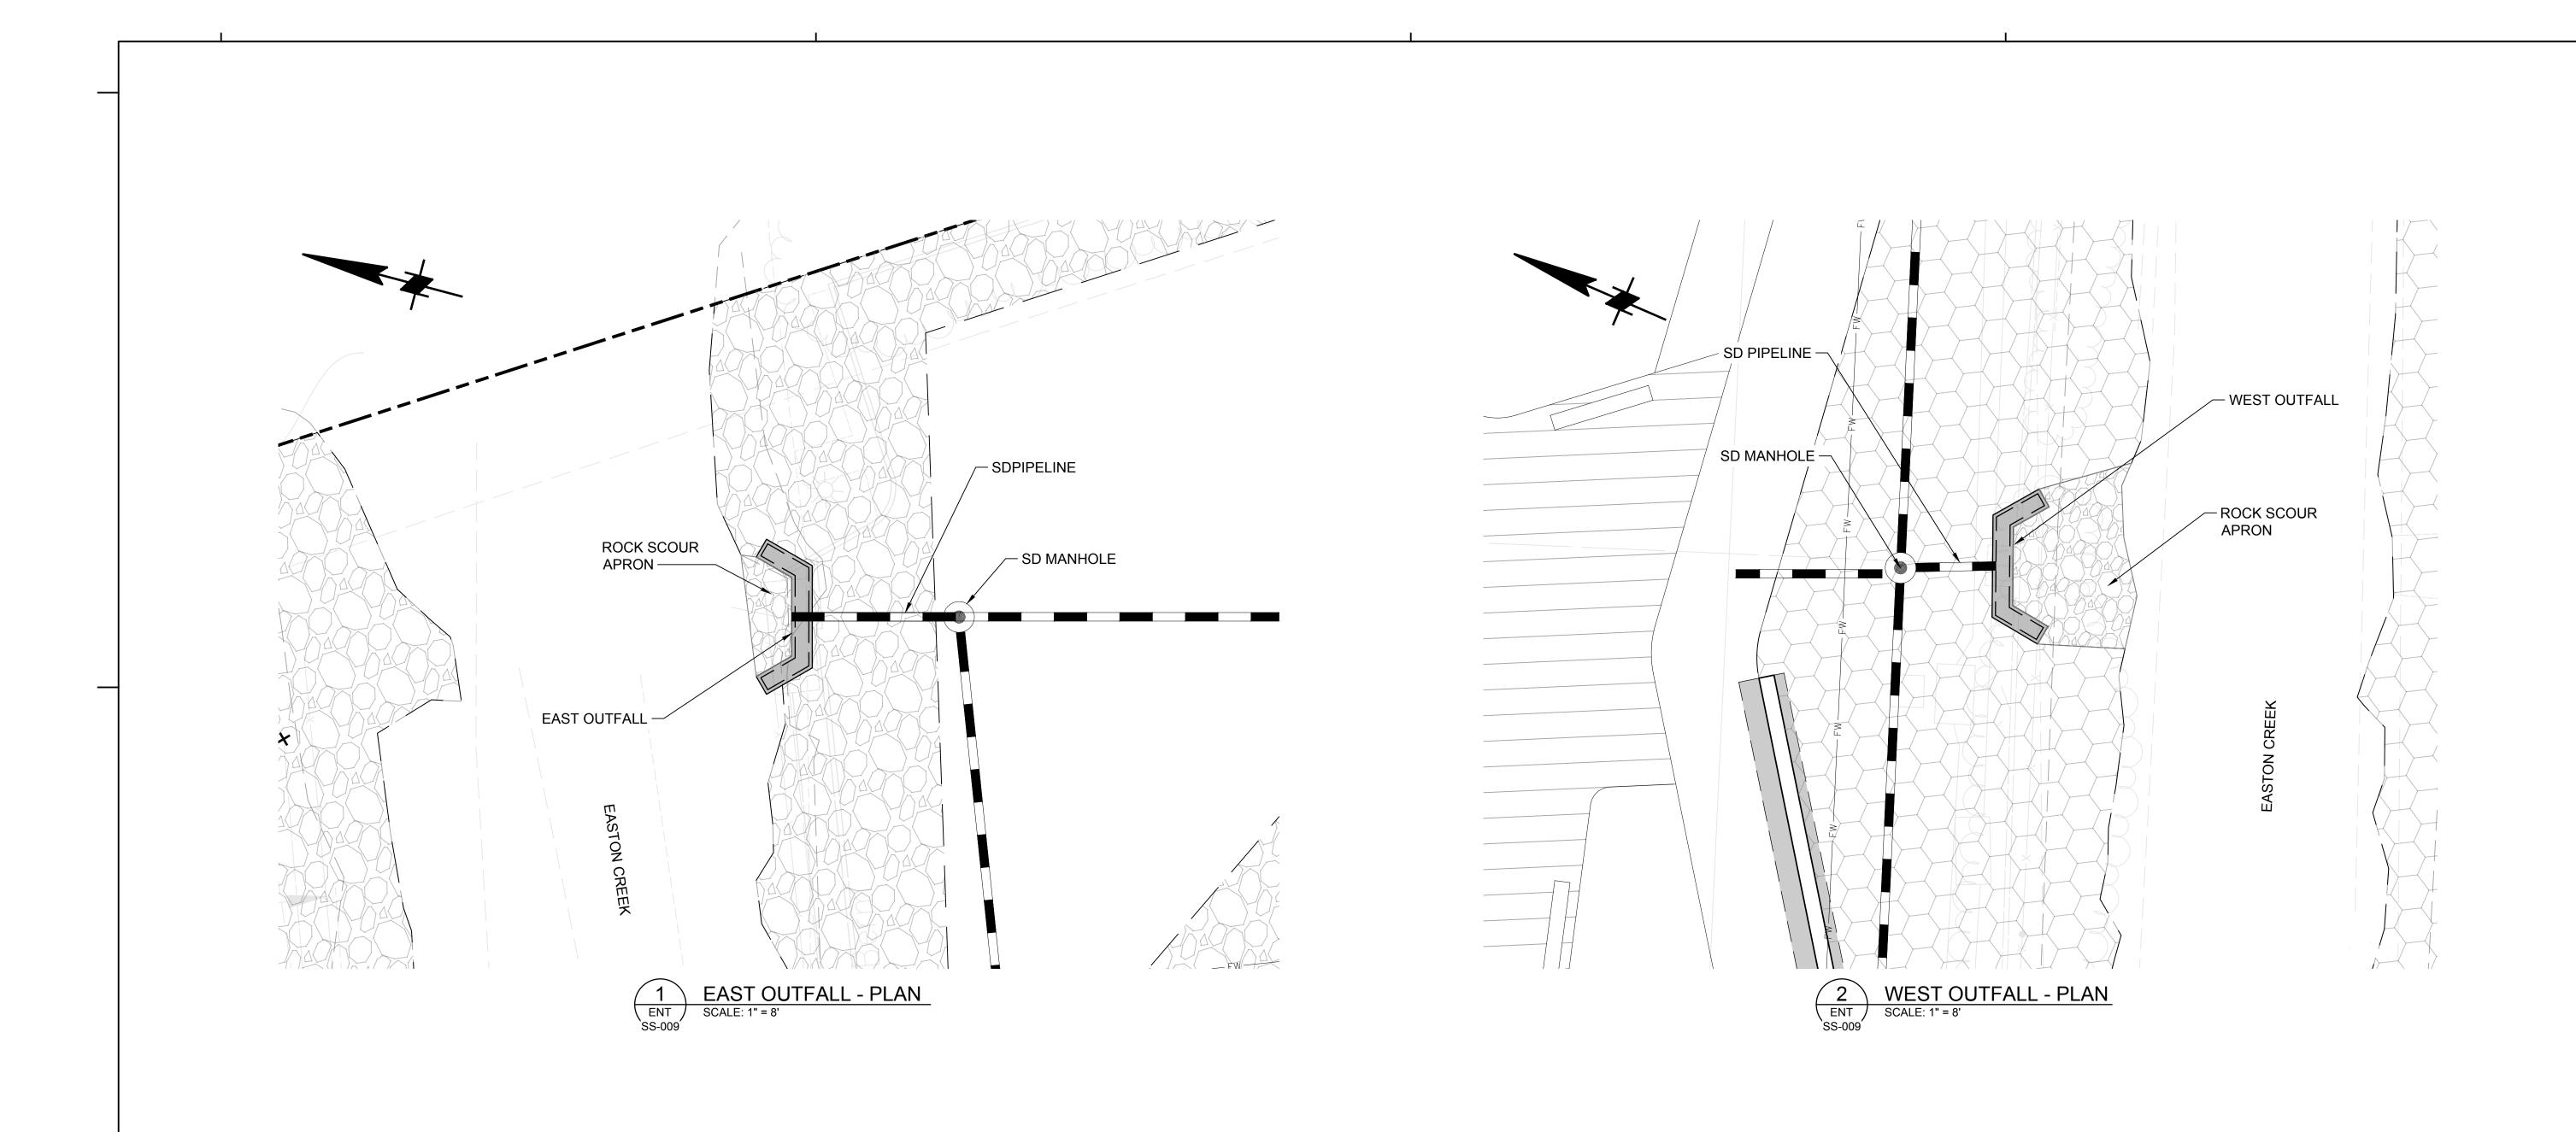

All drawings and written material appearing herein constitute original and unpublished work of the

WRNSSTUDIO

501 SECOND STREET 4TH FLOOR, STE. 402 SAN FRANCISCO CALIFORNIA 94107 415. 489. 2224 TEL 415. 358. 9100 FAX WWW.WRNSSTUDIO.COM










moffatt & nic

WATT

ISSUES	DATE
ENTITLEMENT APPLICATION	03/24/2022
ENTITLEMENT APPLICATION #2	08/19/2022
ENTITLEMENT APPLICATION #3	12/09/2022
ENTITLEMENT APPLICATION #4	09/18/2023

KEYPL

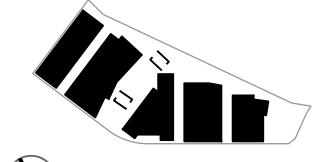




PROJECT NO.: 20045.00 DATE: 08/19/2022 SCALE: AS SHOWN

SHEET TITLE:

STORMWATER OUTFALL

SHEET NO

If this drawing is not 21"v26" than the drawing has been revised from its original size

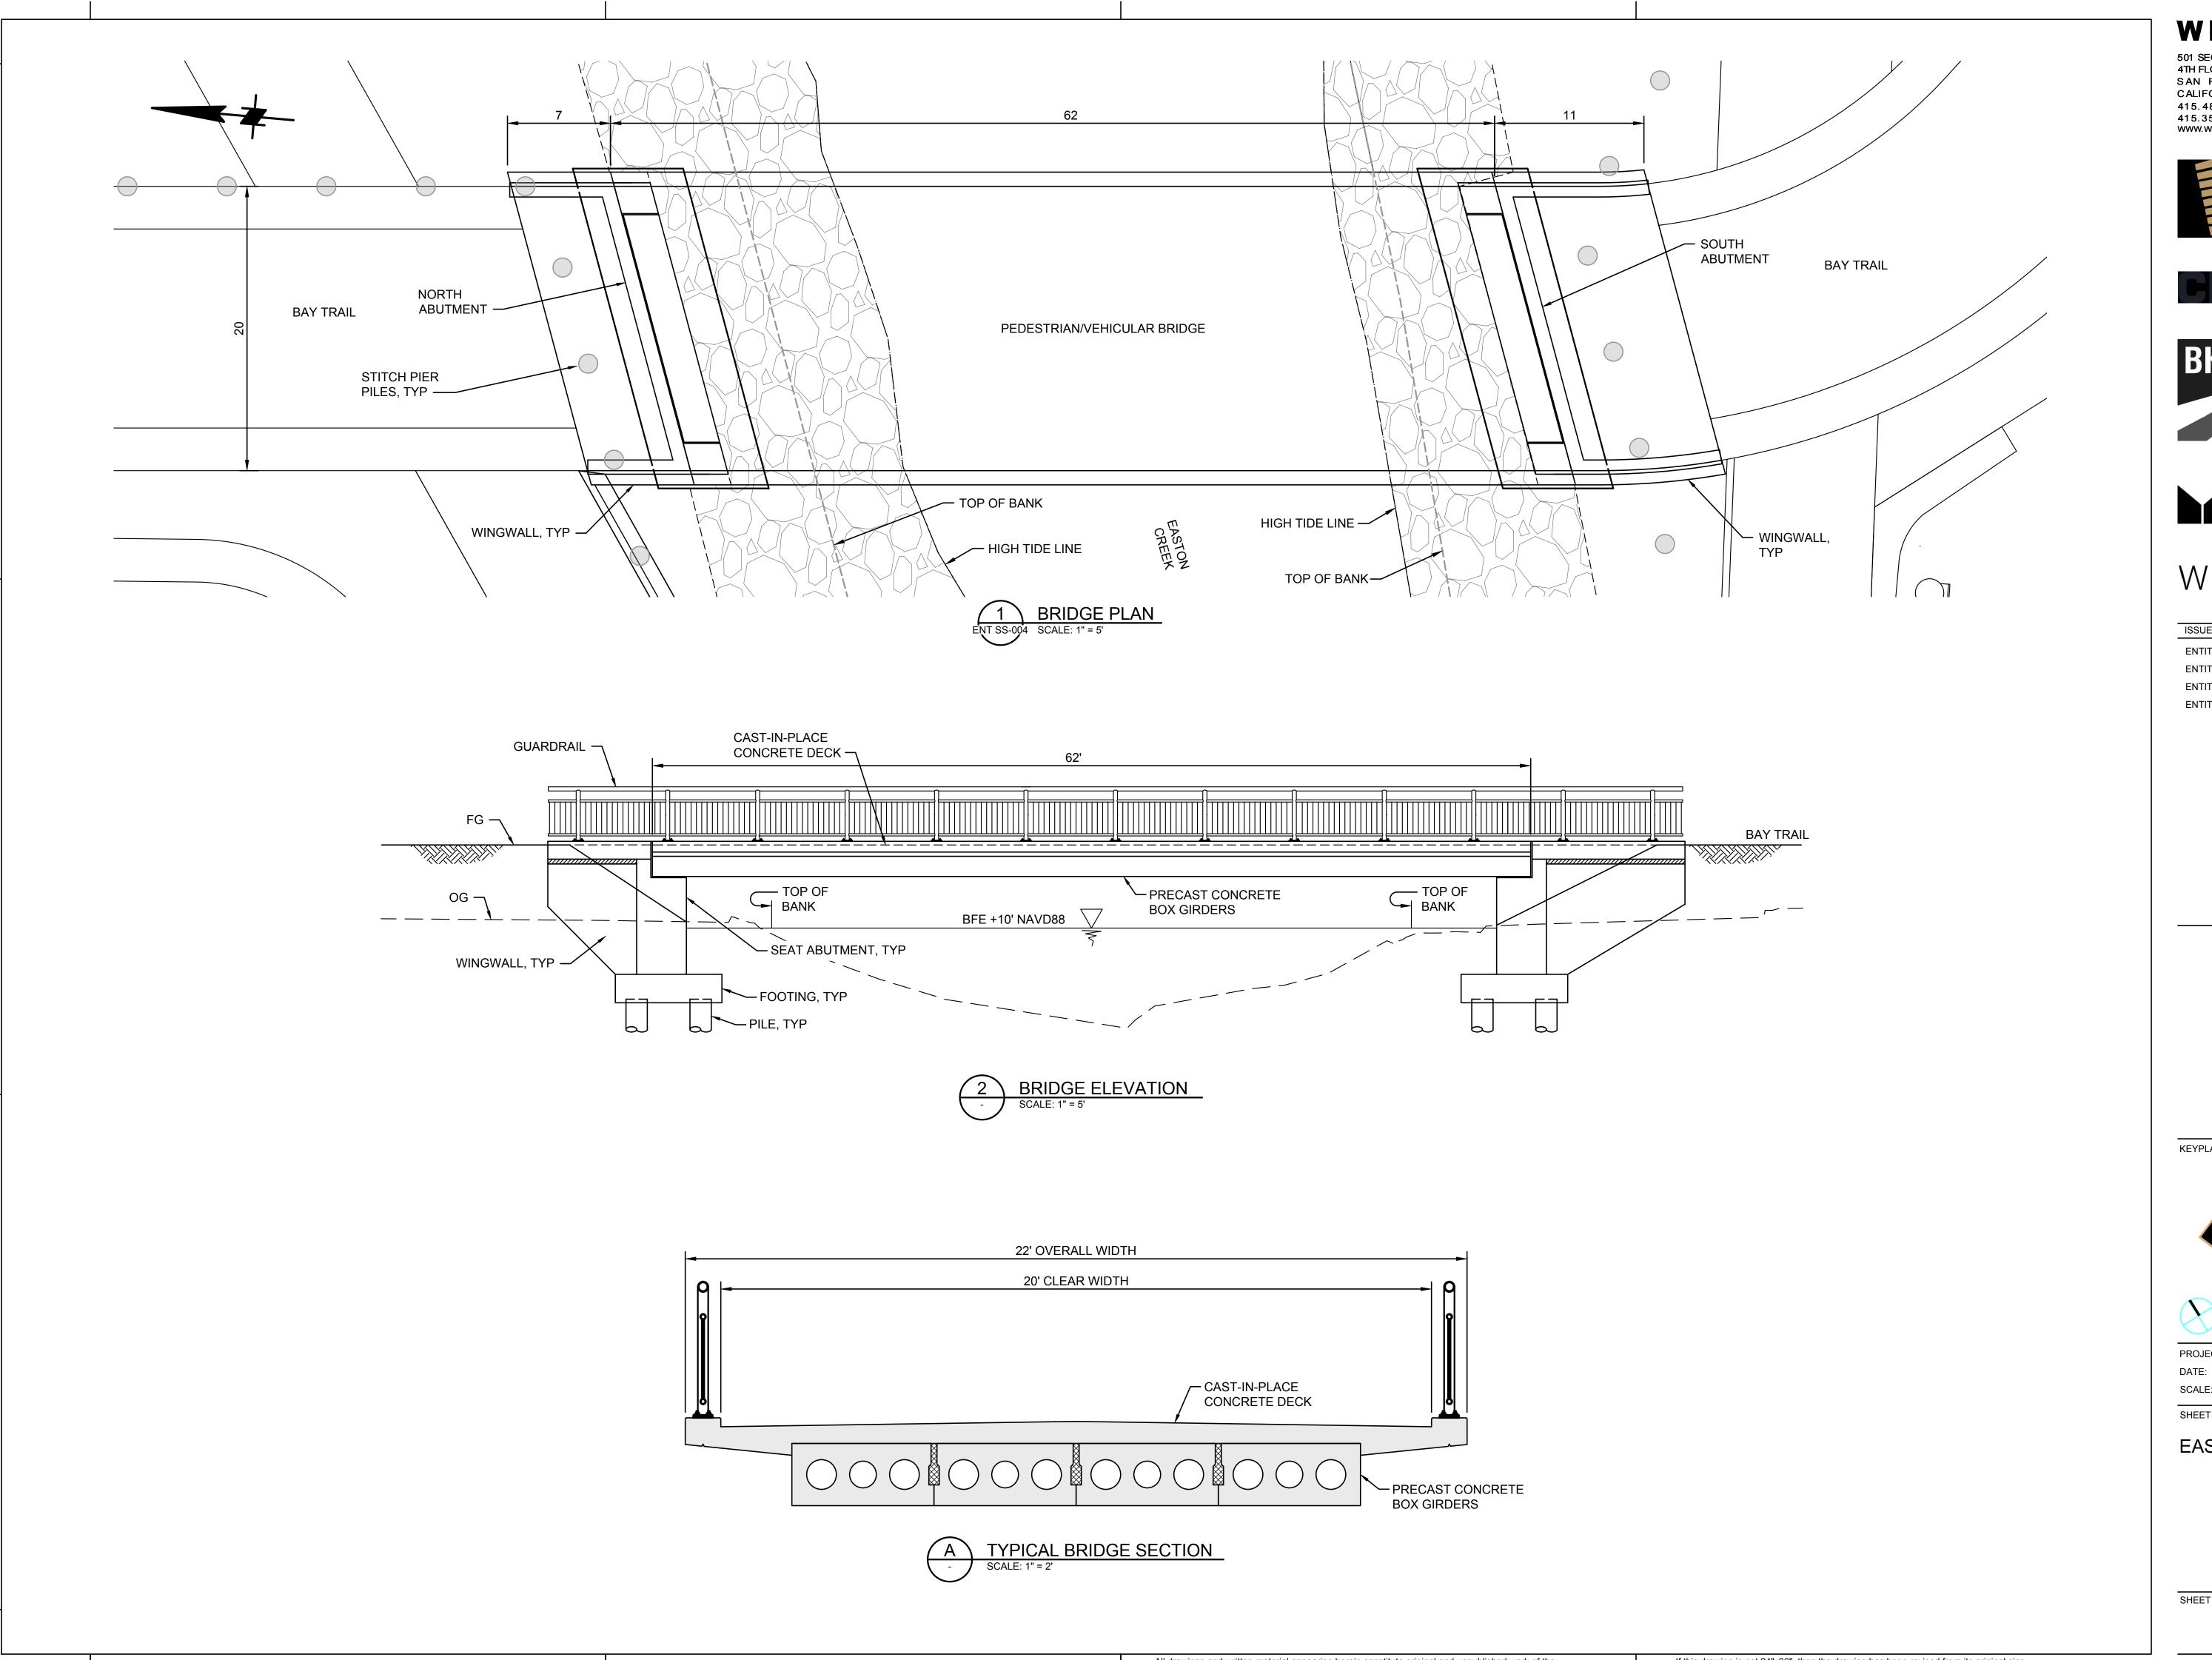

501 SECOND STREET 4TH FLOOR, STE. 402 SAN FRANCISCO CALIFORNIA 94107 415.489.2224 TEL 415.358.9100 FAX www.wrnsstudio.com










WATT

ISSUES	DATE
ENTITLEMENT APPLICATION	03/24/2022
ENTITLEMENT APPLICATION #2	08/19/2022
ENTITLEMENT APPLICATION #3	12/09/2022
ENTITLEMENT APPLICATION #4	09/18/2023

KEYPLAN

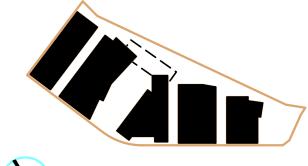



PROJECT NO.:

SCALE: AS SHOWN

SHEET TITLE:

EASTON CREEK BRIDGE



ILLUSTRATIVE SITE LIGHTING PLAN

<u>Lighting Character - Precedent Images</u>



8/1/2022 5:48:22 PM
















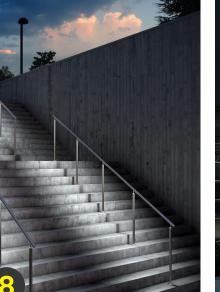

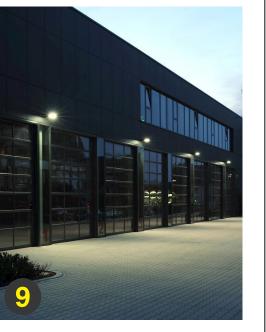

WRNSSTUDIO

501 SECOND STREET 4TH FLOOR, STE. 402 SAN FRANCISCO CALIFORNIA 94107 415.489.2224 TEL 415.358.9100 FAX WWW.WRNSSTUDIO.COM

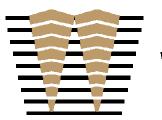

CMG









WATT

ISSUES	DATE
ENTITLEMENT APPLICATION	03/24/2022
ENTITLEMENT APPLICATION #2	08/19/2022
ENTITLEMENT APPLICATION #3	12/09/2022
ENTITLEMENT APPLICATION #4	09/18/2023

1200-1340 OLD BAYSHORE HIGHWAY Burlingame, CA 94010

KEYPLAN

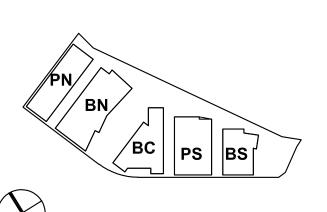

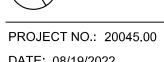

DATE: 08/19/2022 SCALE: NOT TO SCALE

SHEET TITLE:


ILLUSTRATIVE SITE LIGHTING PLAN

5:48:22

/2022

WRNSSTUDIO

501 SECOND STREET 4TH FLOOR, STE. 402 SAN FRANCISCO CALIFORNIA 94107 415.489.2224 TEL 415.358.9100 FAX WWW.WRNSSTUDIO.COM

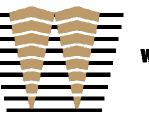

WATRY DESIGN, INC.
Architects • Engineers • Parking Planners










ISSUES	DATE
ENTITLEMENT APPLICATION	03/24/2022
ENTITLEMENT APPLICATION #2	08/19/2022
ENTITLEMENT APPLICATION #3	12/09/2022
ENTITLEMENT APPLICATION #4	09/18/2023

1200-1340 OLD BAYSHORE HIGHWAY Burlingame, CA 94010

KEYPLAN

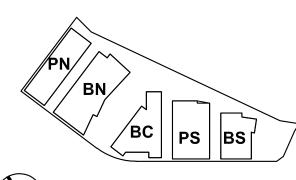



PROJECT NO.: 20045.00

DATE: 08/19/2022

SCALE: 1" = 60'

SHEET TITLE:

SITE LIGHTING PHOTOMETRICS

Eunstianal Classification	Pedestr	E /E		
Functional Classification	High	Medium	Low	$E_{\text{avg}}/E_{\text{min}}$
Major/Major	34/3.2	26/2.4	18/1.7	3.0
Major/Collector	29/2.7	22/2.0	15/1.4	3.0
Major/Local	26/2.4	20/1.9	13/1.2	3.0
Collector/Collector	24/2.2	18/1.7	12/1.1	4.0
Collector/Local	21/2.0	16/1/5	10/0.9	4.0
Local/Local	18/1.7	14/1.3	8/0.7	6.0

Project will use these IES target light levels @ intersections based on expected pedestrian activity

3

TARGET ILLUMINATION FOR INTERSECTIONS

Table 11-1. Lighting Design Criteria for Streets

(Source: IES-RP8-2021, Recommended Practice: Lighting Roadway and Parking Facilities)

Street Classification	Pedestrian Activity Classification*	Average Luminance* L _{avg} (cd/m²)	Average Uniformity Ratio Lavg/Lmin	Maximum Uniformity Ratio $L_{\rm max}/L_{\rm min}$
	High	1.2 (1.7fc)	3.0	5.0
Major	Medium	0.9	3.0	5.0
(Old Bayshore Hwy)	Low	0.6	3.5	6.0
	High	0.8 (1.1fc)	3.0	5.0
Collector	Medium	0.6	3.5	6.0
(Airport Blvd)	Low	0.4	4.0	8.0
	High	0.6	6.0	10.0
Local	Medium	0.5 (0.7fc)	6.0	10.0
(Service Roads)	Low	0.3	6.0	10.0

PEDESTRIAN CLASSIFICATIONS (Source: IES-RP8-2021)

HIGH = over 100 pedestrians/hour


MEDIUM = 1 to 100 pedestrians / hour

LOW = 10 or fewer pedestrians / hour

* Equivalent illuminance level (in footcandles) shown in red for R2 / R3 pavement types



TARGET ILLUMINATION FOR ROADWAYS

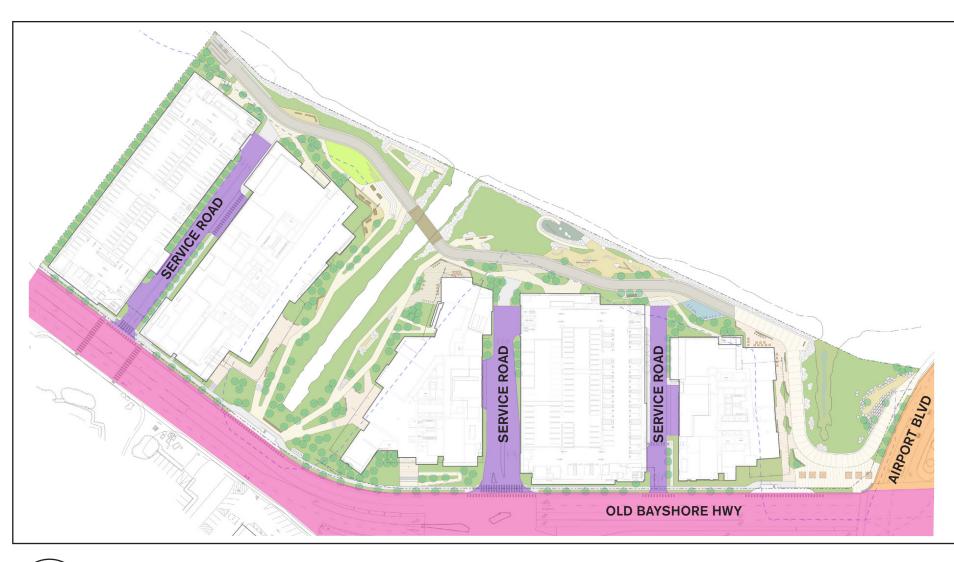

ROADWAY CLASSIFICATIONS: (Source: IES-RP8-2021)

MAJOR = Principal network for throughtraffic flow [but not Freeway or Expressway]; often known as "arterials or thoroughfares."

COLLECTOR = Roadways servicing traffic between major and local streets.


LOCAL = Primarily for direct access to residential, commercial, industrial, or other abutting property.

Traffic-scale "cobrahead" roadway fixture per Caltrans and City of Burlingame standards

- Type POE01
- · Caltrans "Type 15" standard pole @ nominal 30' pole height with
- 12' length arm (fixture mounting height @ nominal 34').
- LED "cobrahead" fixture, Type III Medium lighting distribution, 15,900 delivered lumens @ 4000K color temperature, 203 Watts.
- Exact manufacturer and catalog number of POE01 fixture head to be confirmed by Caltrans and City of Burlingame.

Pedestrian-scale roadway fixture per City of Burlingame standard.

- Type POE02
- Nominal 19.5' height with tapered pole
- LED fixture, Type III Short lighting distribution, 4,530 delivered lumens @ 4000K color temperature, 50.6 Watts.
- Exact manufacturer and catalog number of POE02 fixture head to be confirmed by City of Burlingame.

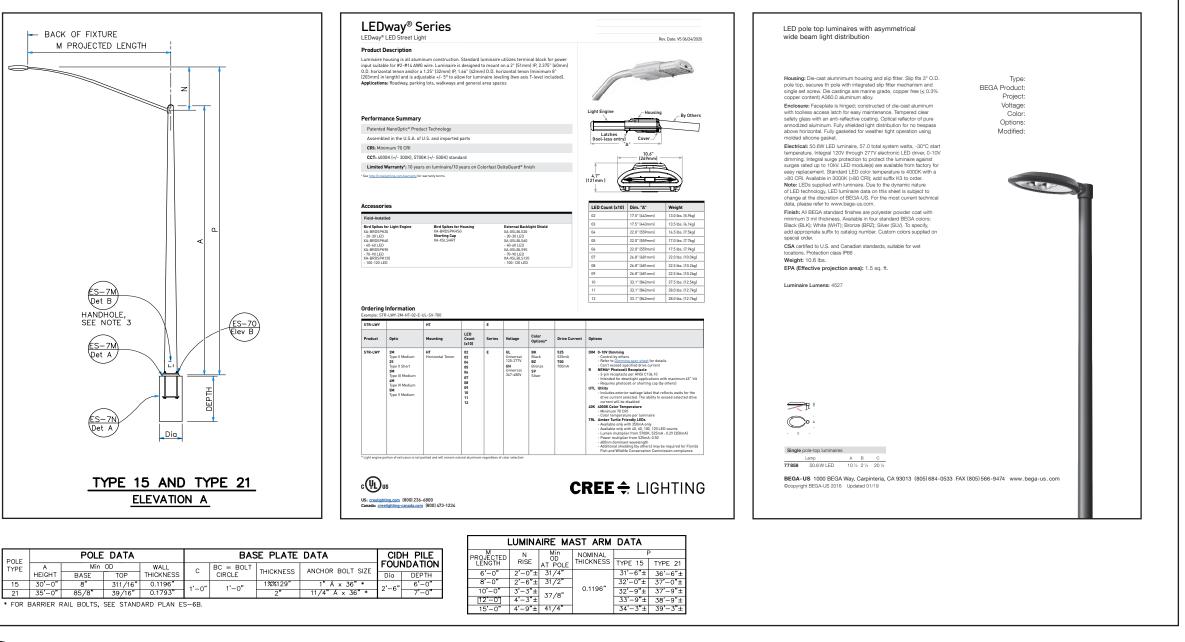



STREET LIGHTING EQUIPMENT (OLD BAYSHORE HWY & AIRPORT BLVD)

OLD BAYSHORE HWY SIDEWALK	1.3fc Average*
AIRPORT BLVD SIDEWALK	0.9fc Average*
SERVICE ROAD SIDEWALK	0.6fc Average*

* IES recommends that sidewalk illumination (adjacent roadways) be 80% of roadway, using conversion factor $1cd/m^2 = 15lux (1.5fc)$



TARGET ILLUMINATION FOR SIDEWALKS

Table 11-2. Recommended Design Criteria for Walkways [and Bikeways] Within Road Right of Way (Source: IES-RP8-2021, Recommended Practice: Lighting Roadway and Parking Facilities)

Condition	E _{avg} , lux (fc)	E _{v,avg} lux (fc)	E _{avg} /E _{min} *
High pedestrian activity	10 (0.9)	5 (0.5)	5.0
Medium pedestrian activity	5 (0.5)	2 (0.2)	5.0
Low pedestrian activity	2 (0.2)	1 (0.1)	10.0

4

TARGET ILLUMINATION FOR BIKEWAYS WITHIN ROAD RIGHT OF WAY (aka Bike Lanes)

WRNSSTUDIO

501 SECOND STREET 4TH FLOOR, STE. 402 SAN FRANCISCO CALIFORNIA 94107 415.489.2224 TEL 415.358.9100 FAX WWW.WRNSSTUDIO.COM














ISSUES	DAT
ENTITLEMENT APPLICATION	03/24/202
ENTITLEMENT APPLICATION #2	08/19/202
ENTITLEMENT APPLICATION #3	12/09/202
ENTITLEMENT APPLICATION #4	09/18/202

1200-1340 OLD BAYSHORE HIGHWAY Burlingame, CA 94010

KEYPLAN

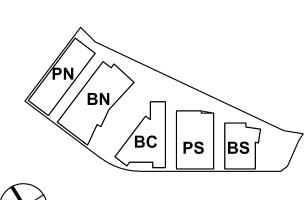



PROJECT NO.: 20045.00

DATE: 08/19/2022

SCALE: NOT TO SCALE


SHEET TITLE:

SITE LIGHTING CHARACTER


CHEET NO.

ENT LT-103

8/1/2022 5:48:22 PM

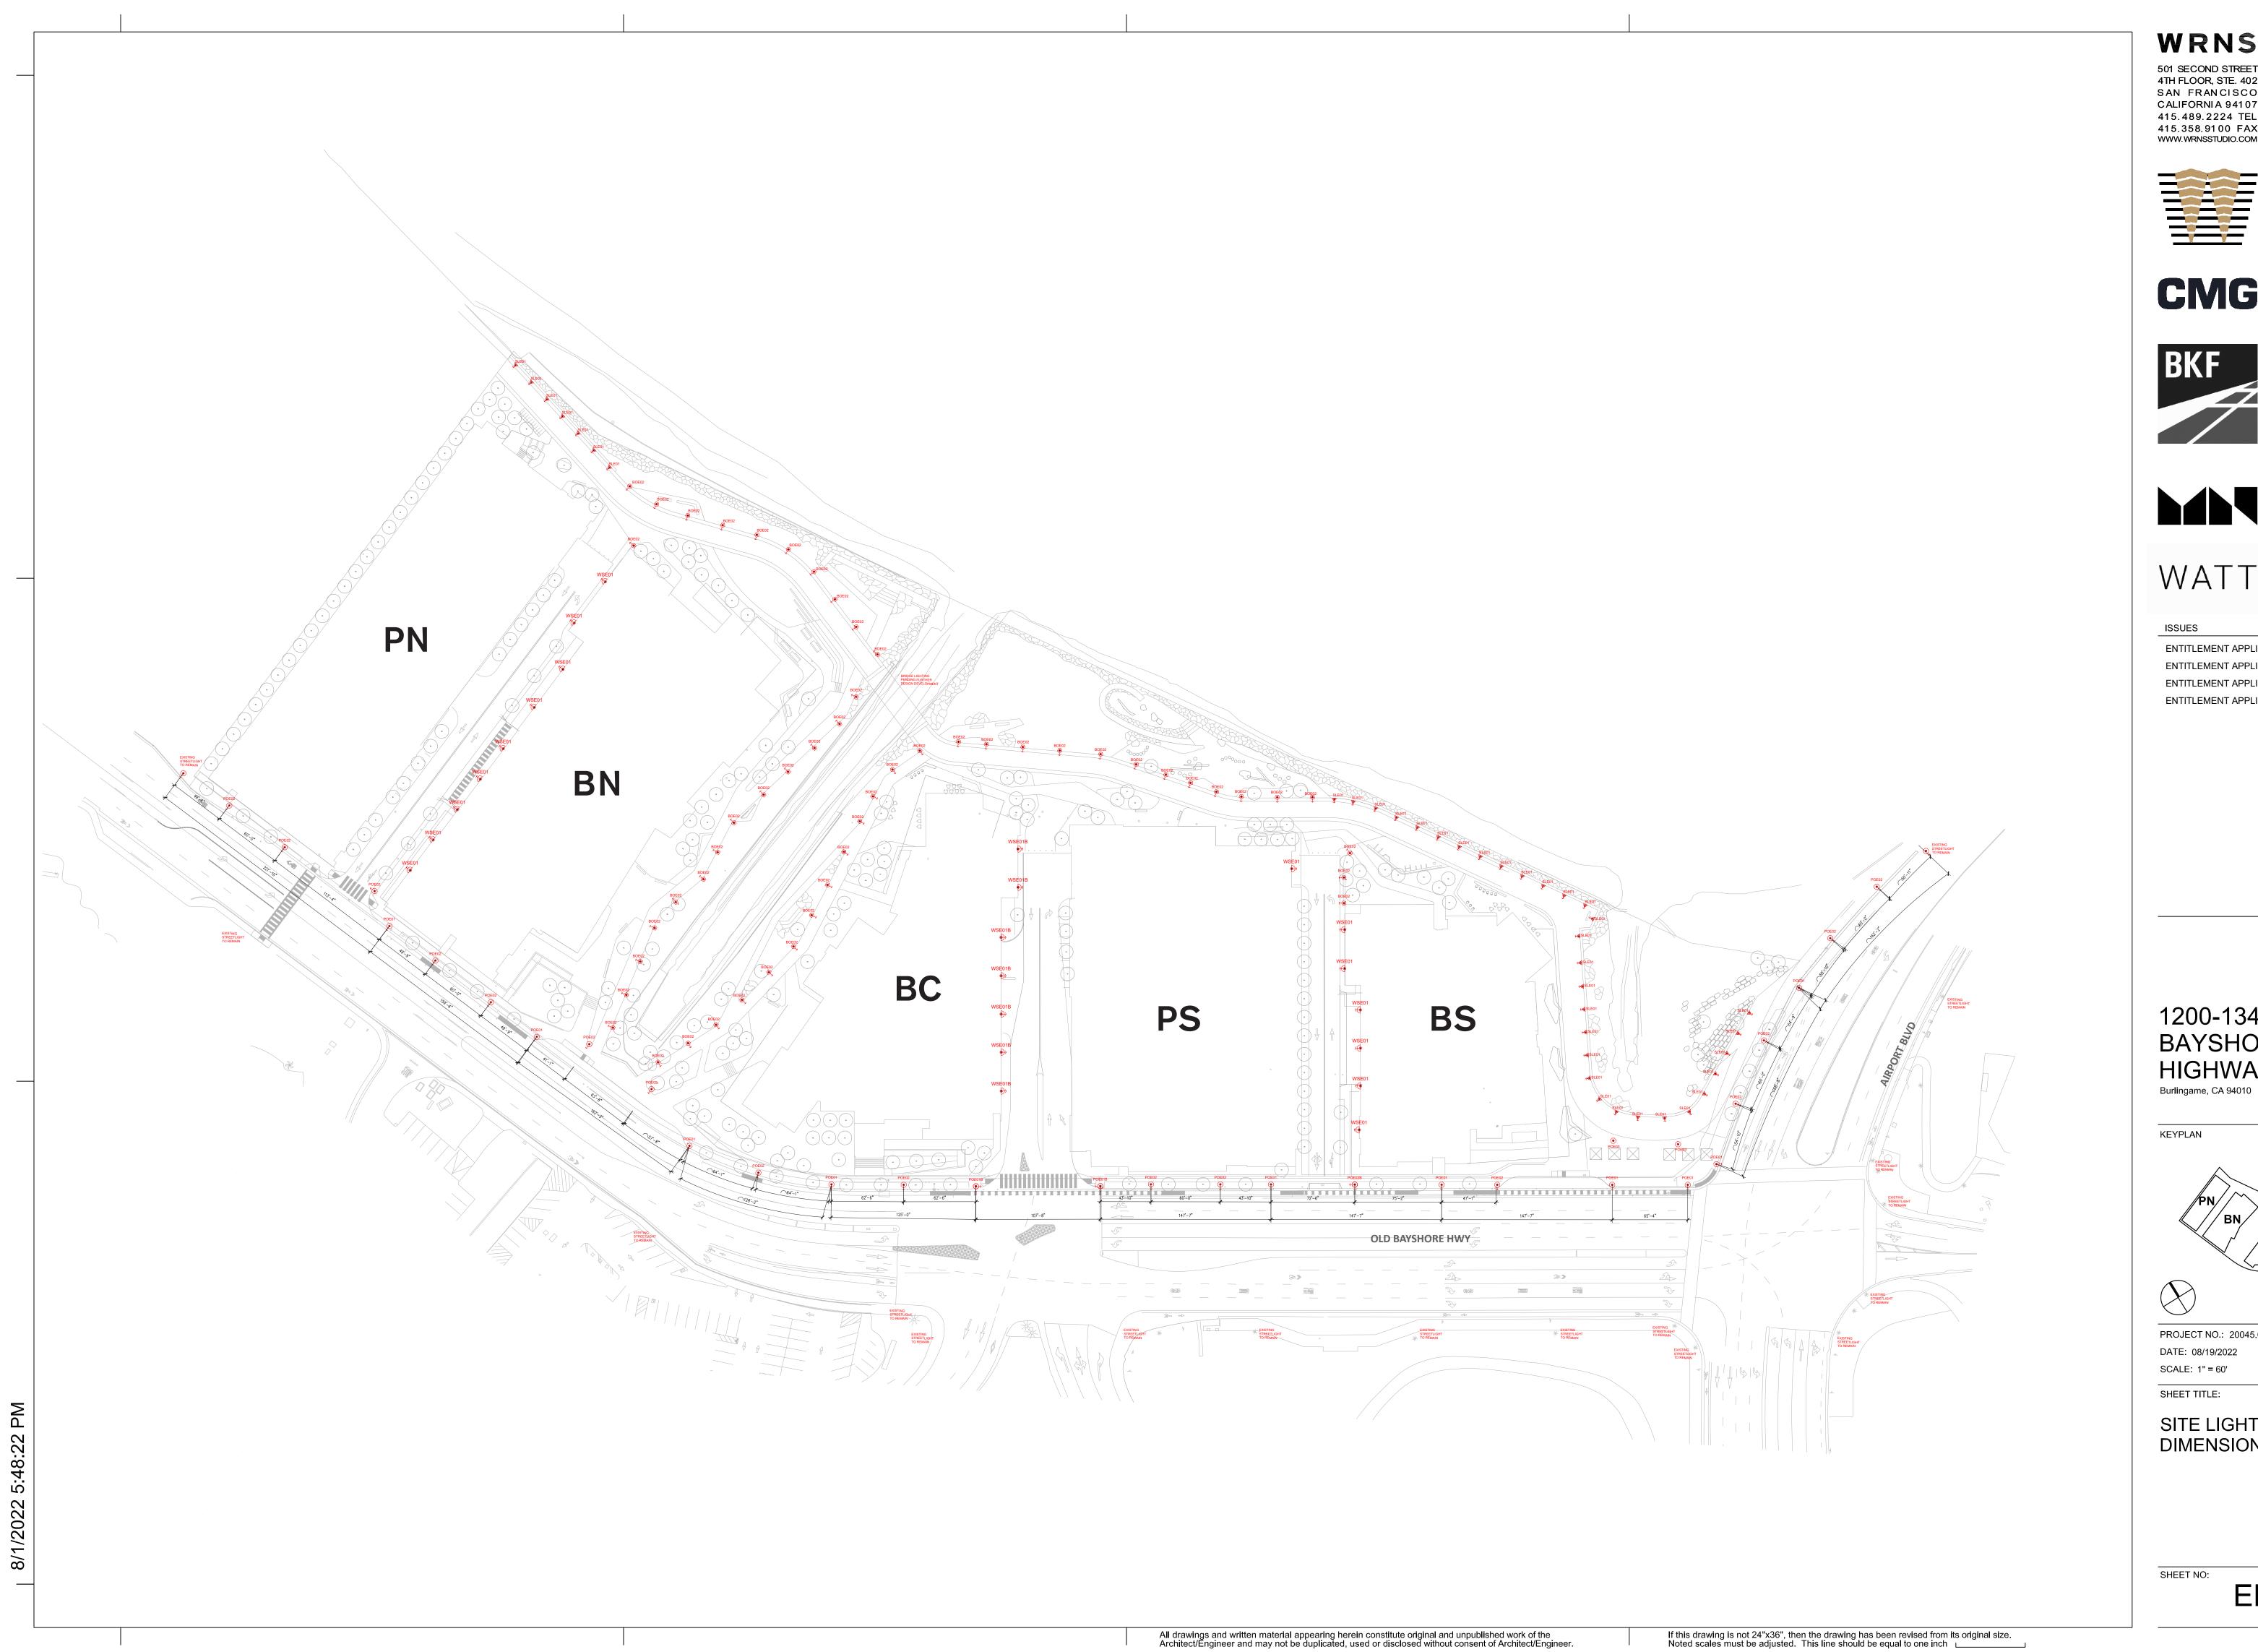

501 SECOND STREET 4TH FLOOR, STE. 402 SAN FRANCISCO CALIFORNIA 94107 415.489.2224 TEL 415.358.9100 FAX WWW.WRNSSTUDIO.COM

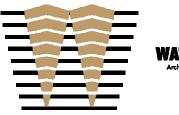











ISSUES	DATE
ENTITLEMENT APPLICATION	03/24/2022
ENTITLEMENT APPLICATION #2	08/19/2022
ENTITLEMENT APPLICATION #3	12/09/2022
ENTITLEMENT APPLICATION #4	09/18/2023

1200-1340 OLD BAYSHORE HIGHWAY

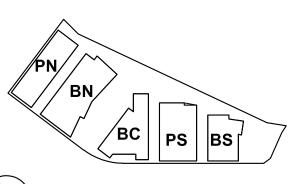

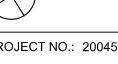

PROJECT NO.: 20045.00 DATE: 08/19/2022 SCALE: 1" = 60'

SHEET TITLE:

SITE LIGHTING **DIMENSIONS**