

**Bayshore Project** Tree Data

Tag # Botanic Name Common Name Eucalyptus Red Ironbark Gum 21.8 68.5 40 70 Fair sideroxylon Eucalyptus Red Ironbark Gum 23.5 73.8 40 70 Poor sideroxylon Eucalyptus 10.5 33.0 30 30 Fair lehmanii Eucalyptus 12.0 37.7 30 35 Fair lehmanii Bushy Yate Eucalyptus lehmanii **Bushy Yate** 9.5 29.8 25 25 Fair Eucalyptus sideroxylon Red Ironbark Gum 18.7 58.7 40 40 Poor Low Eucalyptus Red Ironbark Gum 21.3 66.9 30 40 Fair sideroxylon Low Eucalyptus Red Ironbark Gum 20.2 63.5 40 25 Poor sideroxylon Eucalyptus sideroxylon Red Ironbark Gum 12.8 40.2 25 25 Very Poor Low Eucalyptus 410 sideroxylon Red Ironbark Gum 10.1 31.7 25 20 Very Poor Low Acacia Baileyana Bailey's Acacia 5.2 16.3 10 15 Dead Eucalyptus Red Ironbark Gum 19.9 62.5 40 40 Good sideroxylon Eucalyptus sideroxylon Red Ironbark Gum 21.3 66.9 40 40 Good Low Eucalyptus sideroxylon Red Ironbark Gum 19.6 61.6 40 30 Poor Eucalyptus sideroxylon Red Ironbark Gum 28.7 90.2 30 40 Poor 415 Populus nigra 'Italica' Lombardy Poplar | 32.0 | 100.5 | 60 | 30 | Fair 416 Populus nigra 6.2 19.5 50 10 Fair 417 'Italica' Lombardy Poplar 5.5 17.3 15 15 Dead Pyracantha spp. Firethorn Populus nigra Lombardy Poplar 419 'Italica' 44.9 141.1 60 50 Fair Pyracantha spp. Firethorn 5.3 16.7 15 15 Fair 6.0 18.8 15 15 Fair lucidum Glossy Privet Unknown 9.1 28.6 25 20 Very Poor Low Unknown

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**Bayshore Project** Tree Data

Tag #	Botanic Name	Common Name	Diameter (in)	Circumference (in)	Height (ft)	Spread (ft)	Health	Risk	Regulated Tree
423	Eucalyptus sideroxylon	Red Ironbark Gum	24.8	77.9	35	35	Fair	Low	x
424	Eucalyptus sideroxylon	Red Ironbark Gum	20.2	63.5	25	25	Poor	Low	x
425	Eucalyptus sideroxylon	Red Ironbark Gum	24.9	78.2	30	30	Good	Low	x
426	Eucalyptus sideroxylon	Red Ironbark Gum	25.0	78.5	30	30	Fair	Low	x
427	Eucalyptus sideroxylon	Red Ironbark Gum	25.3	79.5	30	30	Fair	Low	x
428	Persea americana	Avocado	4.1	12.9	20	20	Excellent	Low	
429	Araucaria columnaris Araucaria	Cook Pine	6.5	20.4	15	15	Good	Low	
430	columnaris Araucaria	Cook Pine	7.0	22.0	15	15	Good	Low	
431	columnaris  Metrosideros	Cook Pine New Zealand	8.0	25.1	15	15	Good	Low	
432	excelsa	Christmas Tree	8.7	27.3	15	10	Fair	Low	
433	Acacia Baileyana	Bailey's Acacia	1.0	3.1	8	4	Excellent	Low	
434	Acacia Baileyana Tristaniopsis	Bailey's Acacia	7.6	23.9	18	20	Fair	Low	
435	laurina Trachycarpus	Small-Leaf Tristania	2.3	7.2	10	6	Good	Low	
436	fortunei Trachycarpus	Windmill Palm	8.8	27.6	8	6	Good	Low	
437	fortunei Trachycarpus	Windmill Palm	7.6	23.9	6	4	Fair	Low	
438	fortunei Trachycarpus	Windmill Palm	8.8	27.6	8	6	Fair	Low	
439	fortunei Trachycarpus	Windmill Palm	9.2	28.9	7	5	Fair	Low	
440	fortunei Trachycarpus	Windmill Palm	5.3	16.7	6	4	Fair	Low	
441	fortunei Trachycarpus	Windmill Palm	9.2	28.9	9	7	Fair	Low	
442	fortunei Trachycarpus	Windmill Palm	8.8	27.6	8	5	Fair	Low	
443	fortunei Myoporum	Windmill Palm	8.9	28.0	7	4	Poor	Low	
444	laetum	Ngaio	15.5	48.7	20	20	Very Poor	Low	x

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			Tree Dat	a					
Tag #	Botanic Name	Common Name	Diameter (in)	Circumference (in)	Height (ft)	Spread (ft)	Health	Risk	Regulated Tree
	Myoporum								
445	laetum	Ngaio	8.8	27.6	15	18	Very Poor	Low	
440	Myoporum	Nesia	0.0	00.0	45	45	Dood		
446	laetum	Ngaio	9.3	29.2	15	15	Dead	Low	
447	Myoporum laetum	Ngaio	11.8	37.1	20	25	Very Poor	Low	
447	Myoporum	Ngaio	11.0	37.1	20	23	very r oor	LOW	
448	laetum	Ngaio	11.4	35.8	20	20	Very Poor	Low	
	Myoporum			00.0				2011	
449	laetum	Ngaio	11.8	37.1	25	25	Very Poor	Low	
	Myoporum	_					-		
450	laetum	Ngaio	8.1	25.4	25	25	Very Poor	Low	
	Myoporum								
451	laetum	Ngaio	10.0	31.4	25	25	Very Poor	Low	
450	Myoporum	Nicolo	44.0	07.4		0.5	\/ D		
452	laetum	Ngaio	11.8	37.1	25	25	Very Poor	Low	
453	Myoporum laetum	Ngaio	0.4	20.6	20	20	Very Poor	Laur	
455	Myoporum	ingaio	9.1	28.6	20	20	very Poor	LOW	
454	laetum	Ngaio	11.3	35.5	20	20	Very Poor	Low	
101	Myoporum	rigaio	11.0	00.0	20	20	10171 001	LOW	+
455	laetum	Ngaio	9.8	30.8	25	25	Very Poor	Low	
	Myoporum								
456	laetum	Ngaio	9.7	30.5	25	25	Very Poor	Low	
	Myoporum								
457	laetum	Ngaio	10.2	32.0	20	25	Very Poor	Low	
	Myoporum								
458	laetum	Ngaio	7.2	22.6	15	15	Dead	Low	
450	Myoporum laetum	Nacio	11.0	27.4	20	20	Vory Boor	Laur	
459	Myoporum	Ngaio	11.9	37.4	20	20	Very Poor	Low	
460	laetum	Ngaio	10.4	32.7	15	15	Dead	Low	
+00	Myoporum	rigaio	10.4	02.1	10	10	Dodd	LOVV	
461	laetum	Ngaio	5.9	18.5	10	10	Dead	Low	
	Myoporum								+
462	laetum	Ngaio	11.8	37.1	20	25	Very Poor	Low	
	Myoporum								
463	laetum	Ngaio	11.9	37.4	20	25	Very Poor	Low	
	Myoporum						., -		
464	laetum	Ngaio	10.5	33.0	20	20	Very Poor	Low	
465	Myoporum laetum Myoporum	Ngaio	12.0	37.7	20	25	Very Poor	Low	
466	laetum	Ngaio	13.7	43.0	20	25	Very Poor	LOW	

Tree Management Experts 2021 Page 3 of 5

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**Bayshore Project** 

Tag #	Botanic Name	Common Name	Diameter (in)	Circumference (in)	Height (ft)	Spread (ft)	Health	Risk	Regulated Tree
467	Myoporum laetum	Ngaio	10.7	33.6	20		Very Poor	Low	
468	Myoporum laetum Metrosideros	Ngaio New Zealand	15.2	47.8			Very Poor	Low	
469	excelsa	Christmas Tree	5.3	16.7	15	15	Good	Low	
470	Juniperus chinensis 'Torulosa' Magnolia	Hollywood Juniper	11.0	34.6	15	15	Good	Low	
471	soulangeana	Saucer Magnolia	7.2	22.6	20	25	Good	Low	
472	Myoporum laetum	Ngaio	7.2	22.6	25	15	Very Poor	Low	
473	Chamaerops humilis	Mediterranean Fan Palm	12.8	40.2	10	15	Fair	Low	
474	Pyrus Calleryana 'Aristocrat'	Aristocrat Callery Pear	14.3	44.9	30	30	Good	Low	
475	Yucca gloriosa	Spanish Dagger	20.0				Good	Low	х
476 477	Eucalyptus polyanthemos Juniperus chinensis 'Torulosa'	Silver-Dollar Gum Hollywood Juniper	16.4			35	Fair Very Poor	Low	x
478	Juniperus chinensis 'Torulosa'	Hollywood Juniper	7.4	23.2			Very Poor		
479	Juniperus chinensis 'Torulosa' Eucalyptus	Hollywood Juniper	9.2	28.9	20	20	Very Poor	Low	
480	polyanthemos	Silver-Dollar Gum	19.6	61.6	35	25	Good	Low	x
481	Callistemon viminalis	Weeping Bottlebrush	20.0	62.8	30	30	Good	Low	x
482	Eucalyptus polyanthemos Callistemon	Silver-Dollar Gum Weeping	3.0	9.4	15	6	Good	Low	
483	viminalis	Bottlebrush	9.6	30.2	25	10	Fair	Low	
484	Callistemon viminalis	Weeping Bottlebrush	13.0	40.8	30	25	Fair	Low	
485	Callistemon viminalis	Weeping Bottlebrush	12.0	37.7	30	25	Fair	Low	
486	Pinus thunbergiana	Japanese Black Pine	14.8	46.5	30	30	Poor	Low	


**Bayshore Project** 

Tag #	Botanic Name	Common Name	Diameter (in)	Circumference (in)	Height (ft)	Spread (ft)	Health	Risk	Regulated Tree
· • 9 ··	Dodonaea							1.011	(D
	viscosa								
487	'Purpurea'	Purple Hopseed	2.1	6.6	10	8	Good	Low	
	Schinus								
488	terebinthifolia	Brazilian Pepper	16.3	51.2	30	30	Good	Low	X
	Schinus								
489	terebinthifolia	Brazilian Pepper	18.1	56.9	30	30	Fair	Low	X
	Dodonaea								
100	viscosa	Dumala Hamasası	- 4	40.0	-00	45	D		
490	'Purpurea'	Purple Hopseed	5.1	16.0			Poor	Low	
491	Pinus radiata	Monterey Pine	20.1	63.1	25		Very Poor	Moderate	X
492	Pinus radiata	Monterey Pine	23.2				Fair	Low	X
493	Pinus radiata	Monterey Pine	21.0		50		Fair	Low	X
494	Pinus radiata	Monterey Pine	11.6	36.4	25	20	Very Poor	Low	
495	Eucalyptus polyanthemos	Silver-Dollar Gum	16.3	51.2	30	20	Good	Low	x
496	Eucalyptus polyanthemos	Silver-Dollar Gum	13.0	40.8	20	25	Fair	Low	
490 497	Pinus radiata	Monterey Pine	14.2		20		Very Poor	Low	
731	Juniperus	Wilding 1 mo	17.2	77.0	20	50	10191001	LOW	
498	chinensis 'Torulosa'	Hollywood Juniper	8.0	25.1	20	15	Good	Low	
	Juniperus chinensis							-	
499	'Torulosa'	Hollywood Juniper	4.0	12.6	15	15	Good	Low	

Tree Data

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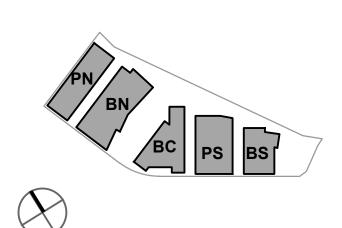


WATT

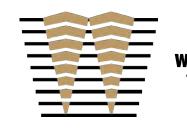ISSUES DATE ENTITLEMENT APPLICATION 03/24/2022 ENTITLEMENT APPLICATION #2 08/19/2022 **ENTITLEMENT APPLICATION #3** 12/09/2022

Peninsula Crossing 1200-1340 Old Bayshore Hwy, Burlingame, CA 94010

KEYPLAN



PROJECT NO.: 20045.00 DATE: 08/19/2022 SCALE: N/A

SHEET TITLE:

**EXISTING TREE** INVENTORY

SHEET NO:

Page 5 of 5


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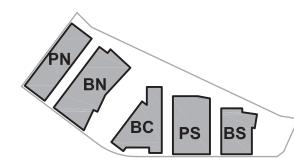


## WATT

ISSUES	DATE
ENTITLEMENT APPLICATION	03/24/2022
ENTITLEMENT APPLICATION #2	08/19/2022
ENTITLEMENT APPLICATION #3	12/09/2022

#### Peninsula Crossing 1200-1340 Old Bayshore Hwy, Burlingame, CA 94010

KEYPLAN

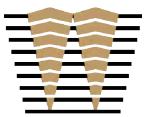



PROJECT NO.: 20045.00 DATE: 08/19/2022 SCALE: 1"=50'

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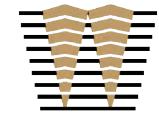
LANDSCAPE SITE PLAN -ILLUSTRATIVE



SHEET NO:



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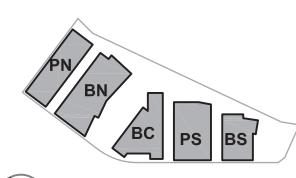


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Peninsula Crossing
1200-1340 Old Bayshore Hwy, Burlingame, CA 94010

KEYPLAN





PROJECT NO.: 20045.00 DATE: 08/19/2022 SCALE: 1"=50'

SHEET TITLE:

LANDSCAPE ROOF PLAN
- ILLUSTRATIVE




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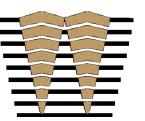
All drawings and written material appearing herein constitute original and unpublished work of the Architect/Engineer and may not be duplicated, used or disclosed without consent of Architect/Engineer.

If this drawing is not 24"x36", then the drawing has been revised from its original size.

Noted scales must be adjusted. This line should be equal to one inch

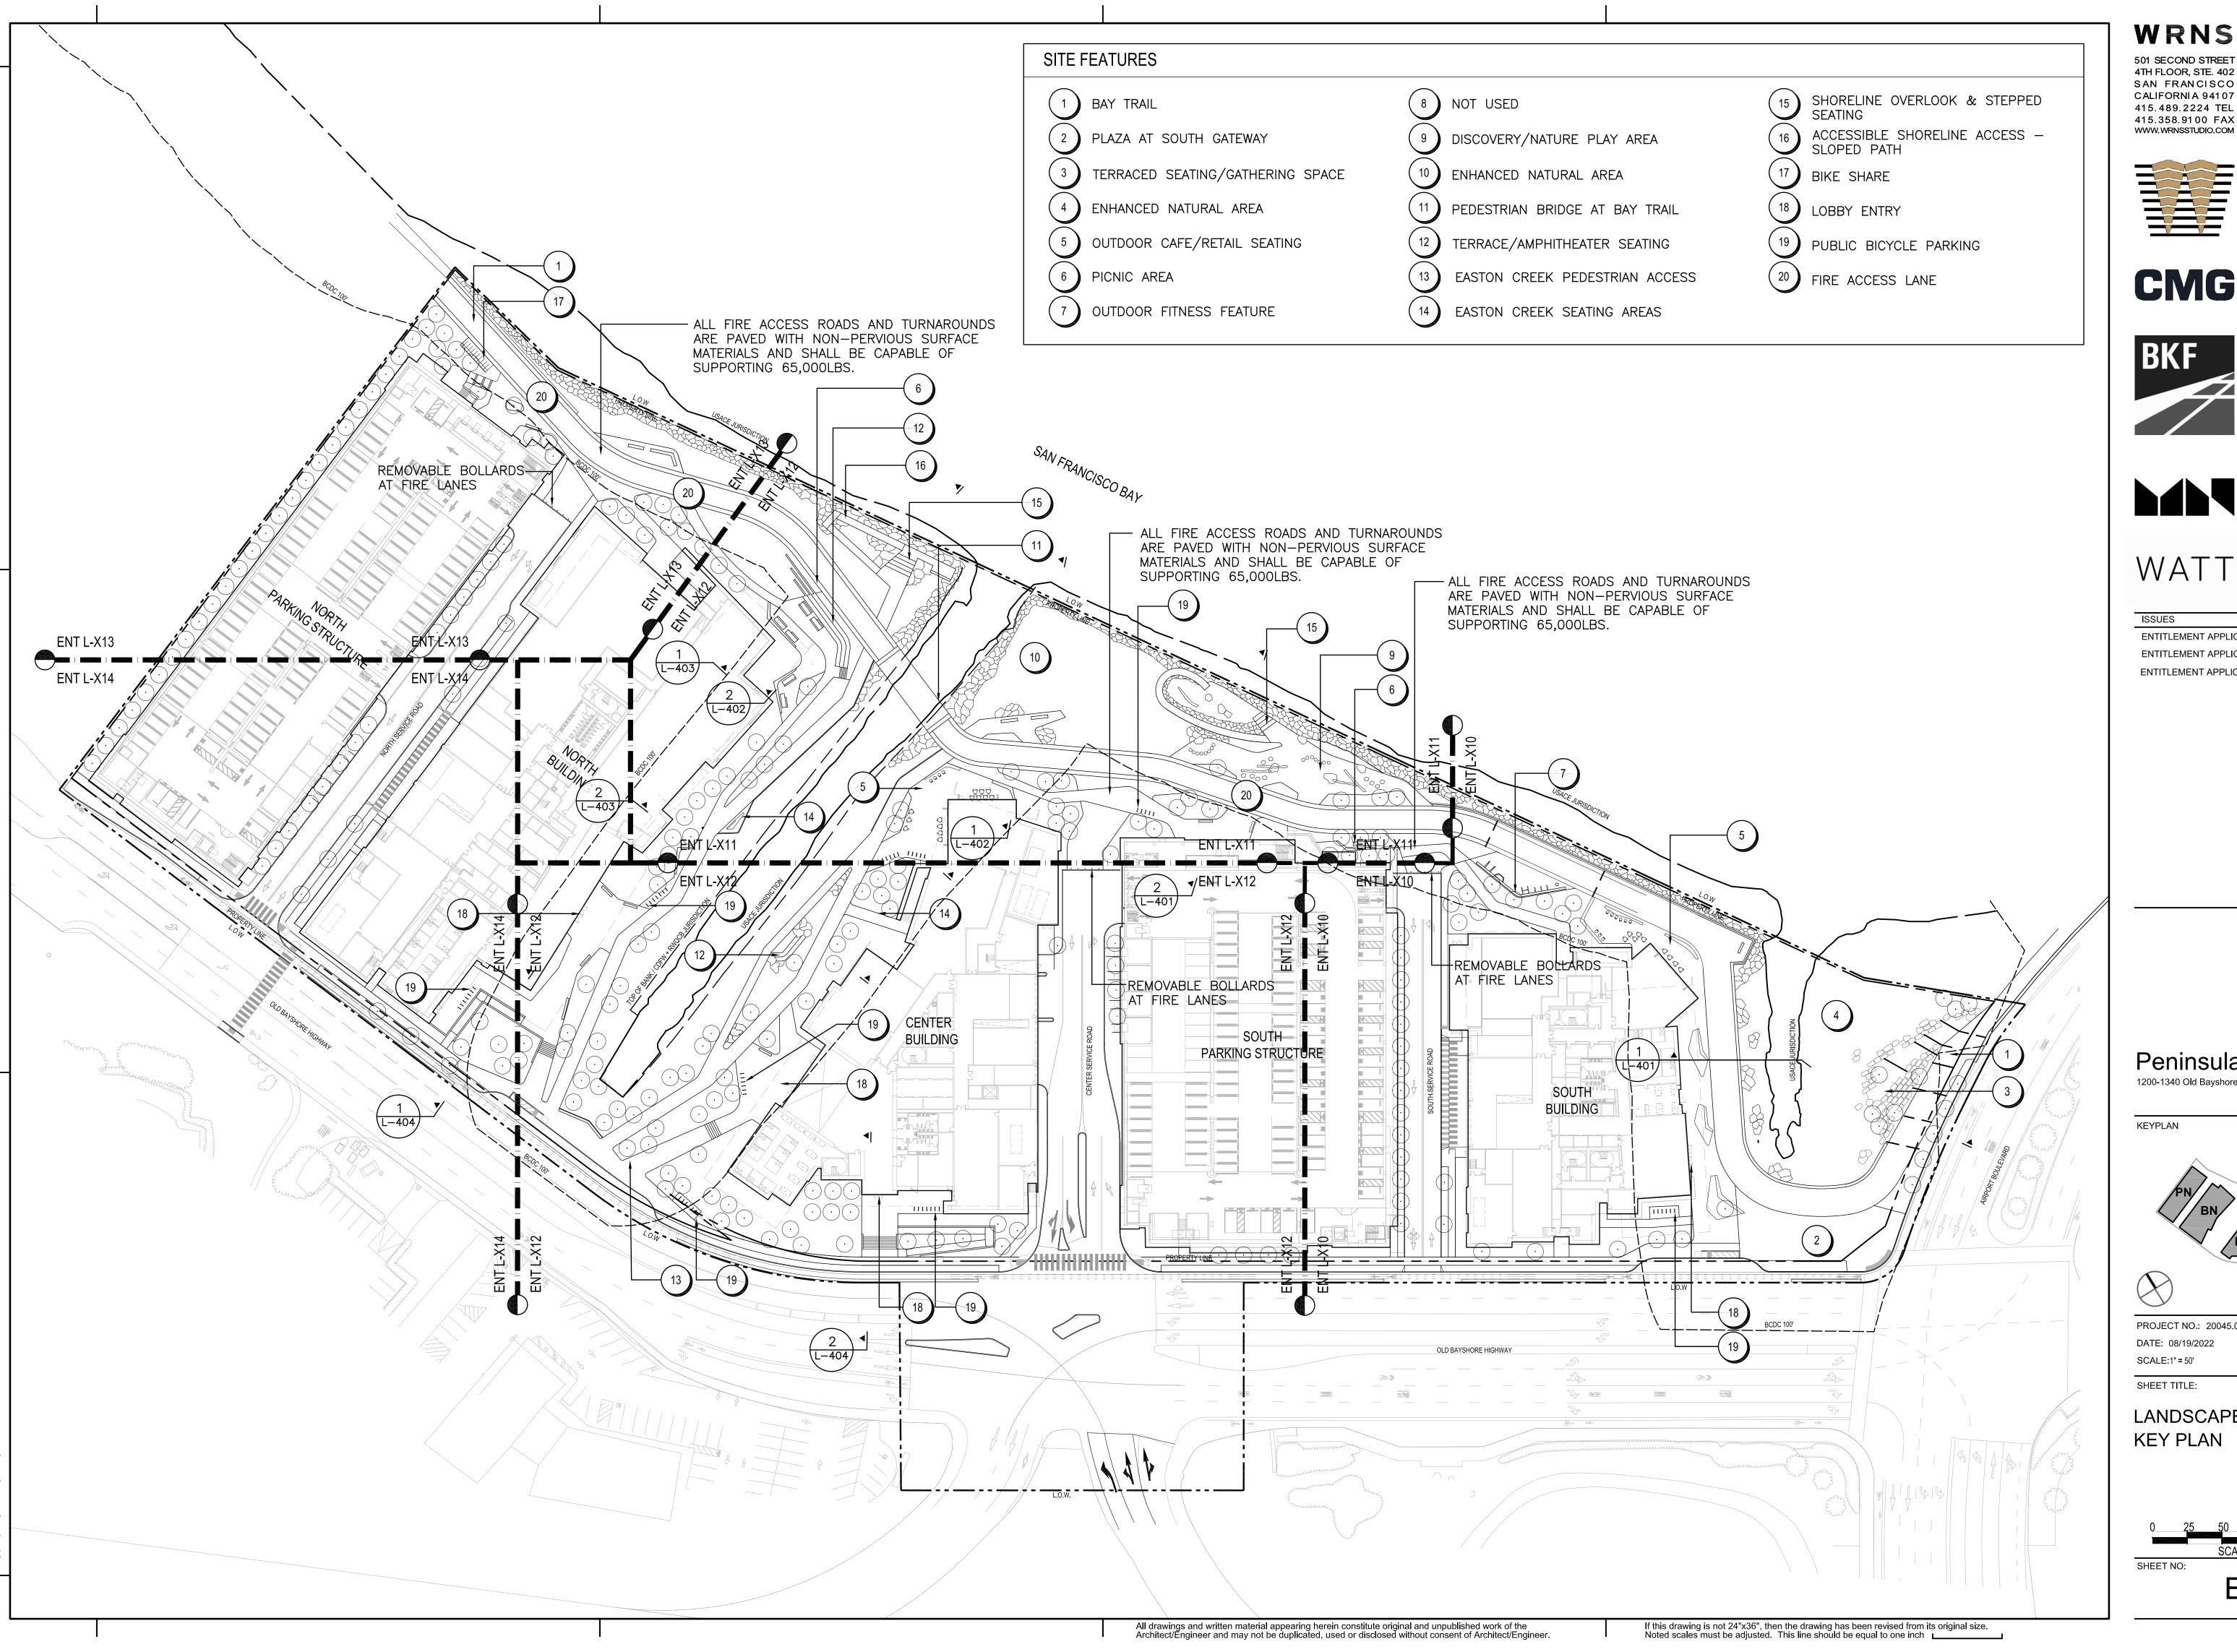

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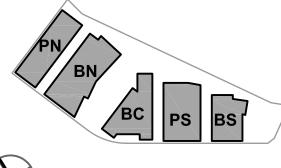


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KEYPLAN






PROJECT NO.: 20045.00 DATE: 08/19/2022

SCALE:1" = 50'

LANDSCAPE PLAN -**KEY PLAN** 

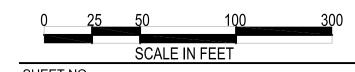


GENERAL NOTES	MATERIALS	SCHEDULE		
. SEE CIVIL AND ARCHITECTURE DRAWINGS FOR PARKING LOT PAVING AND STRIPING,	PAVING			
DRIVEWAYS, AND CURBS.	TAG SYMBOL	TYPE	DESCRIPTION	NOTES
2. SEE ARCHITECTURAL PLANS FOR ADDITIONAL DETAILS AND DIMENSIONING OF WALLS, RAILING AND FENCES 3. EXTERIOR BIKE PARKING: CALGREEN BUIDING CODE REQUIRES EXTERIOR BIKE PARKING TO	P1A	CIP CONCRETE -PEDESTRIAN	4" CIP CONCRETE OVER 4" AGGREGATE BASE, STANDARD GREY, TOOLED JOINTS	
EQUAL 5% OF PUBLIC CAR PARKING. PROJECT WILL COMPLY WITH GALGREEN BUILDING CODE BIKE PARKING REQUIREMENTS.  VEHICULAR PAVING AT ALL FIRE ACCESS LANES TO BE RATED FOR FIRE TRUCK LOADING,	P1B	CIP CONCRETE -VEHICULAR	6" CIP CONCRETE OVER 4" AGGREGATE BASE, STANDARD GREY, TOOLED JOINTS. VEHICULAR CONC. SHALL SUPPORT FIRE TRUCK LOADING — MIN. 65,000 LBS.	
MINIMUM 65,000 LBS.	P2A	SPECIAL CIP CONCRETE -PEDESTRIAN	4" CIP CONCRETE OVER 4" AGGREGATE BASE, INTEGRAL COLOR, TOP SEEDED AGGREGATE, SAW CUT JOINTS. VEHICULAR CONC. SHALL SUPPORT MAINTENANCE VEHICLE LOADING	
	Р2В	SPECIAL CIP CONCRETE -VEHICULAR	6" CIP CONCRETE OVER 4" AGGREGATE BASE, INTEGRAL COLOR, TOP SEEDED AGGREGATE, SAW CUT JOINTS. VEHICULAR CONC. SHALL SUPPORT FIRE TRUCK LOADING — MIN. 65,000 LBS.	
EGEND	P3	BAY TRAIL ASPHALT	VEHICULAR ASPHALT PAVING — 5% ASPHALT CEMENT AND 95% AGGREGATES (STONE, SAND, AND GRAVEL).	
L.O.W  LIMIT OF WORK  PA  PLANTING AREA — SEE PLANTING PLANS	P4	GRAVEL AT GRAVEL "BEACH"	MIXED GRAVEL: 50% 3/8 " PEA GRAVEL, 30% \( \frac{1}{4} \)" PEA GRAVEL, 20% CLEAN DRAIN ROCK.	
+17 SPOT ELEVATION	P5A	STABILIZED CRUSHED STONE PAVING	GRANITECRETE STABILIZED CRUSHED STONE COLOR: NATURAL GOLD	
USACE UNITED STATES ARMY CORPS OF ENGINEERS JURISDICTION  CALIFORNIA DEPARTMENT OF FISH AND WILDLIFE JURISDICTION REGIONAL WATER QUALITY CONTROL BOARD	P5B	STABILIZED CRUSHED STONE PAVING -VEHICULAR	GRANITECRETE STABILIZED CRUSHED STONE COLOR: NATURAL GOLD VEHICULAR SCSP SHALL SUPPORT FIRE TRUCK LOADING — MIN. 65,000 LBS.	
BCDC 100' SAN FRANCISCO BAY CONSERVATION AND DEVELOPMENT COMMISSION 100' JURISDICTION	P6	RUBBERIZED SURFACE	POURED-IN-PLACE RUBBER.	FITNESS PLAZA
	SITE ELEME	NTS		
	TAG	TYPE	DESCRIPTION	
	E1	RIP RAP	FINAL LOCATION OF RIPRAP TO BE LOCATED WHERE NECESSARY TO PREVENT SHORELINE EROSION.	REFER TO SHORELINE ENGINEERING DRAWINGS
	E2	NATURAL BOULDERS	LARGE SCALE NATRUAL BOULDERS — SONOMA FIELD STONE OR GRANITE BOULDERS	
	E3 >	NATURE PLAY FEATURES	LARGE SCALE NATUUAL BOULDERS, STRIPPED AND SANDED LOGS, LOG SEGMENTS.	
	E4	BRIDGE	PEDESTRIAN BRIDGE AT EASTON CREEK BAY TRAIL. BEAM BRIDGE WITH WOOD DECKING AND GALVANIZED STEEL RAILIINGS	
	E5	GUARD RAIL	STAINLESS STEEL GUARD RAIL 42" HEIGHT	
		BIKE SHARE		
	E7 \	STACKED BLOCKS	CAST-IN-PLACE CONCRETE, PRECAST CONCRETE, OR MONOLITHIC STONE BLOCK FOR TERRACED SEATING.	
	E8 E9	BLEACHER SETAING A  BLEACHER SETAING B	CAST-IN-PLACE CONCRETE BLEACHER SEATING  CAST-IN-PLACE CONCRETE BLEACHER SEATING WITH STAIRS	
	E10	SEAT WALL	CAST-IN-PLACE CONCRETE SEAT WALL	
	E11	SEA WALL	SEA WALL — SEE SHORELINE ENGINEERING DRAWINGS	
	E12	CUSTOM BENCH	CAST-IN-PLACE CONCRETE WITH WOOD AND STEEL SEAT AND BACK.	
	E13	SLOPED WALK	SLOPED WALK, MAXIMUM 4.8% SLOPE. 6" CURBS ON BOTH SIDES OF WALK	
		STAIRS	CAST-IN-PLACE CONCRETE STAIRS WITH STAINLESS STEEL HAND RAILS AND CIP CHEEK WALL	
		PICNIC TABLE  FITNESS EQUIPMENT	MANUFACTURED PICNIC TABLE  EXTERIOR FITNESS STATIONS. SIMILAR TO NATIONAL FITNESS	
	E16 E17	BIKE RACK	CAMPAIGN "FITNESS COURTS."  WELLE CIRCULAR BIKE RACK. GALVANIZED STEEL. ROUND TUBE. SURFACE MOUNT.	
		BIKESHARE STATION	SURFACE MOUNT.	
	E19	REMOVABLE BOLLARD	STAINLESS STEEL REMOVEABLE BOLLARD AT EVA LANES	
	E20	FIRE ACCESS LANE	_	
	\\\	ADA DEDECTRIAL CALL	ACCEPCIBLE DAMP WITH HAMPRAN C	

ADA PEDESTRIAN RAMP

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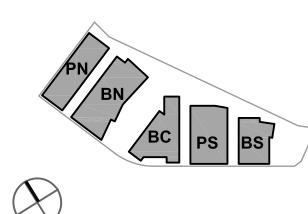



WATT

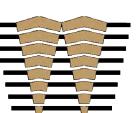ISSUES	DATE
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Peninsula Crossing 1200-1340 Old Bayshore Hwy, Burlingame, CA 94010

KEYPLAN




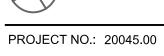

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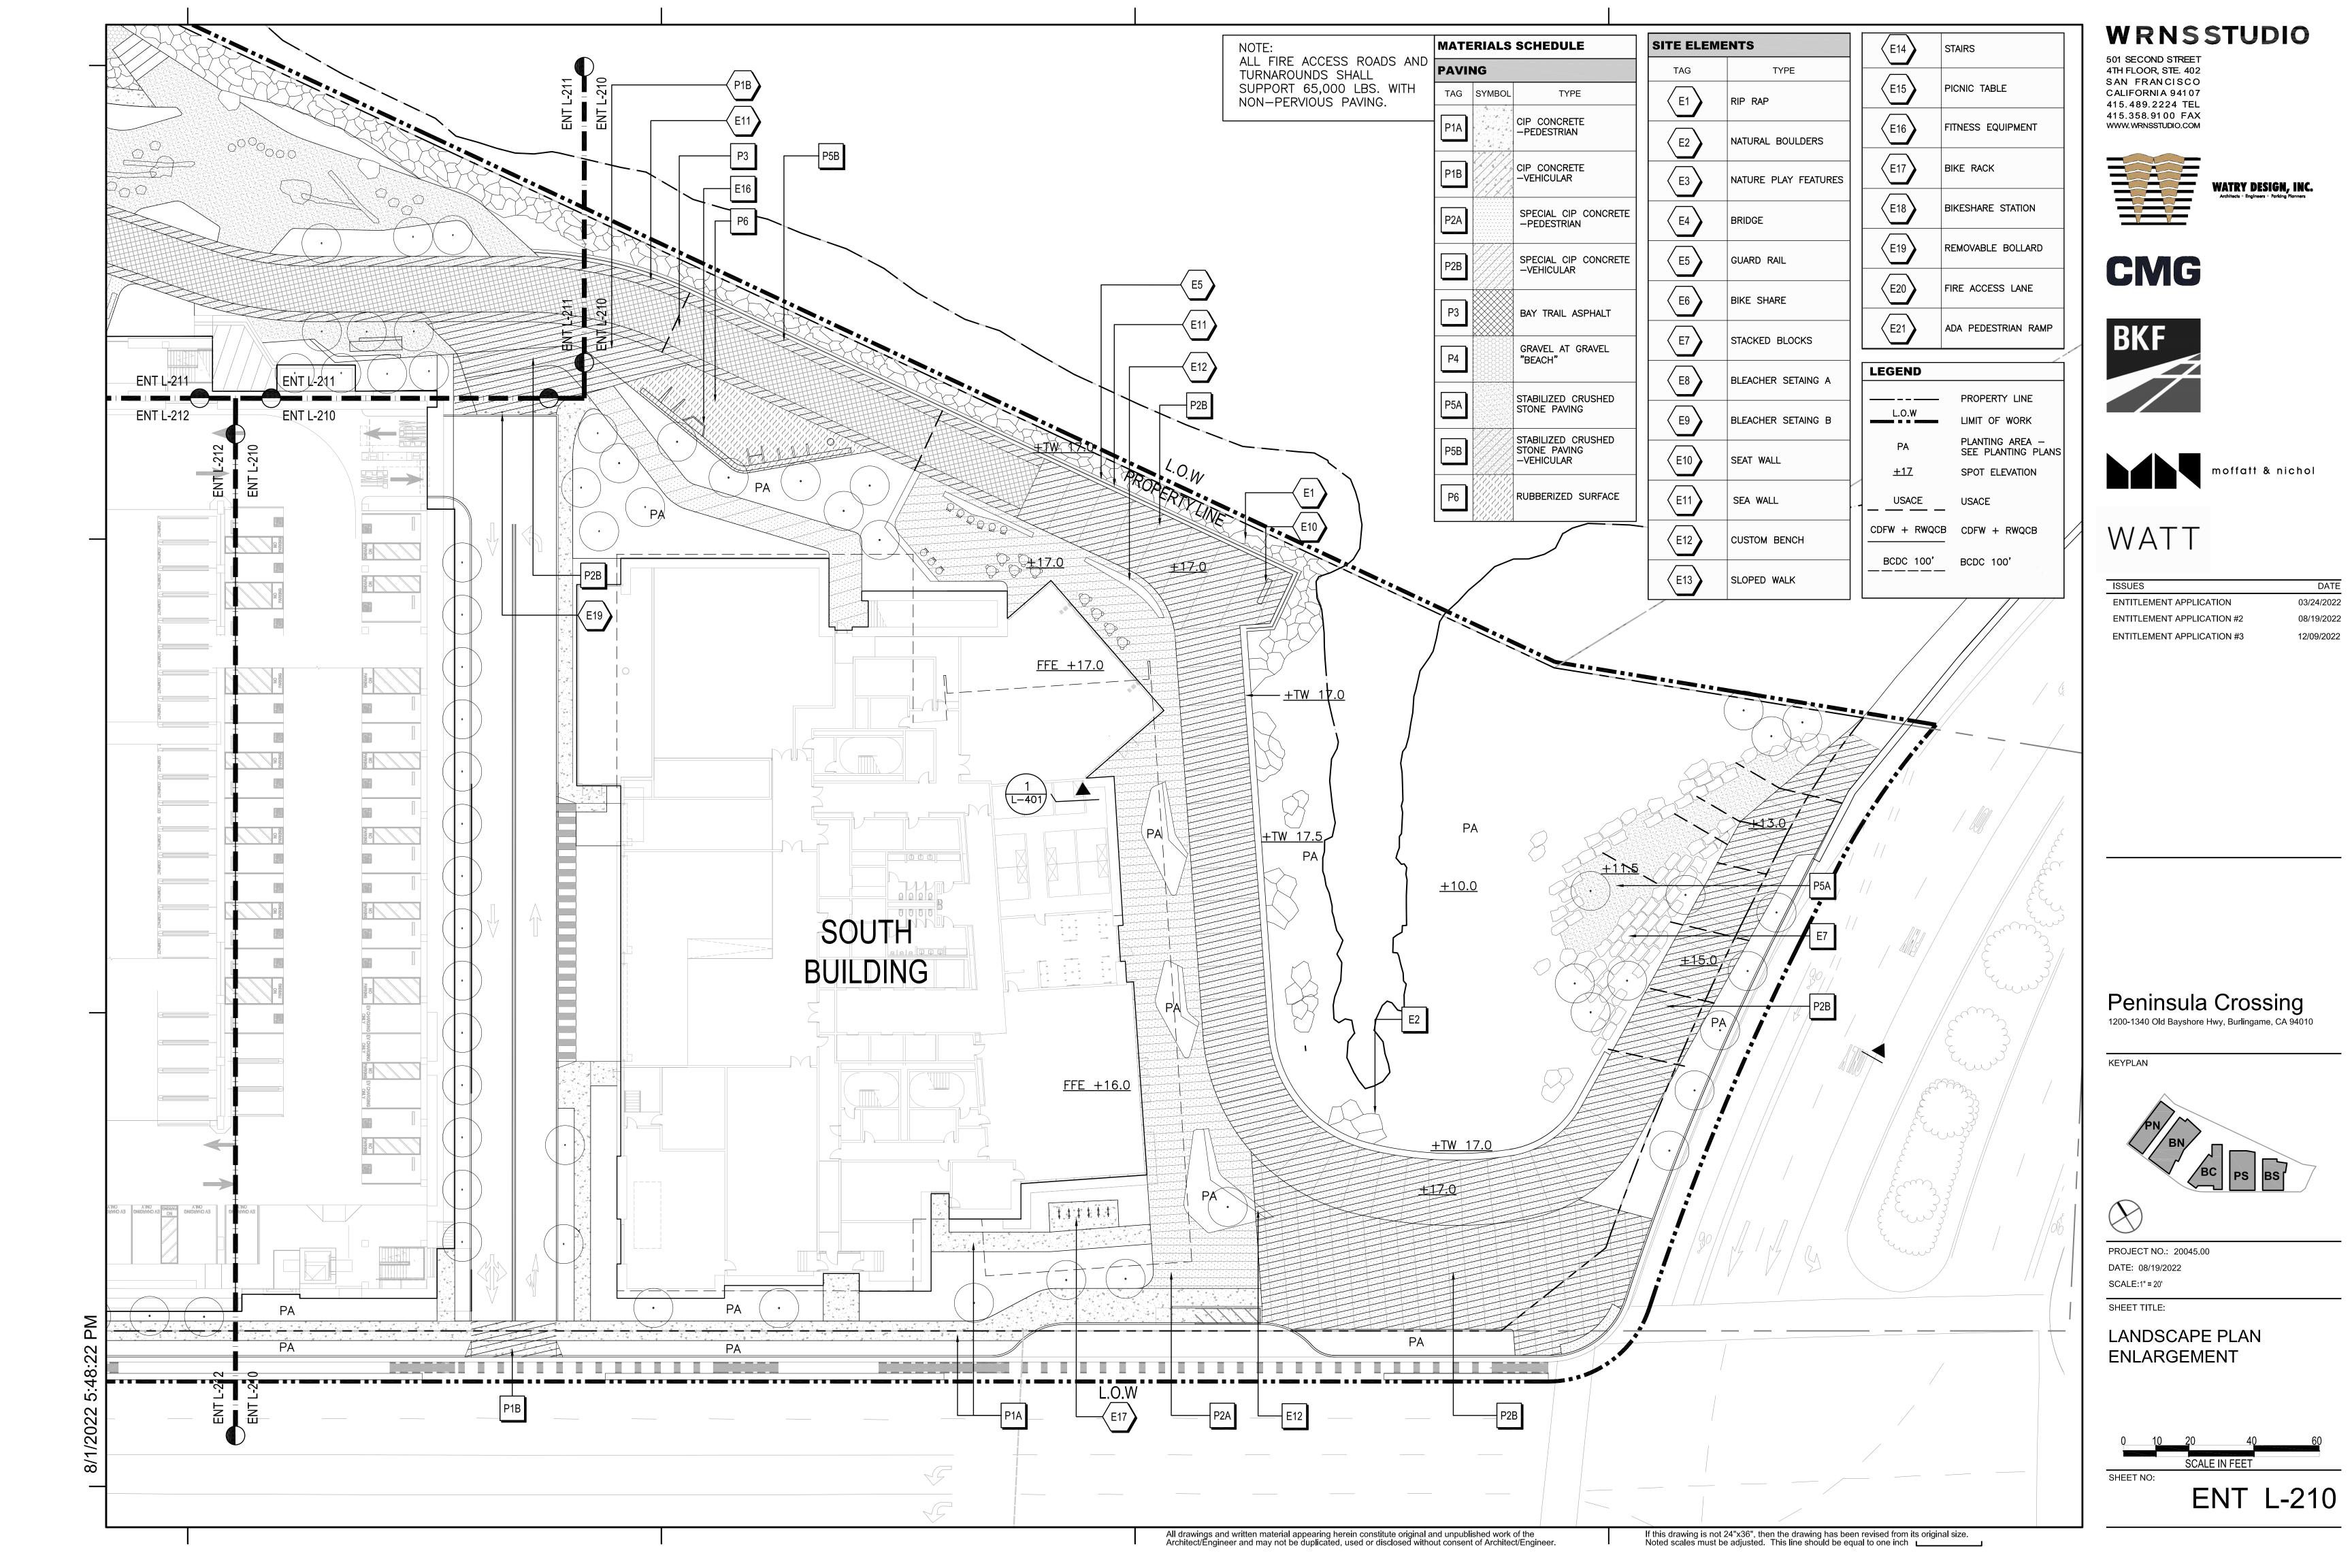
LANDSCAPE MATERIALS SCHEDULE





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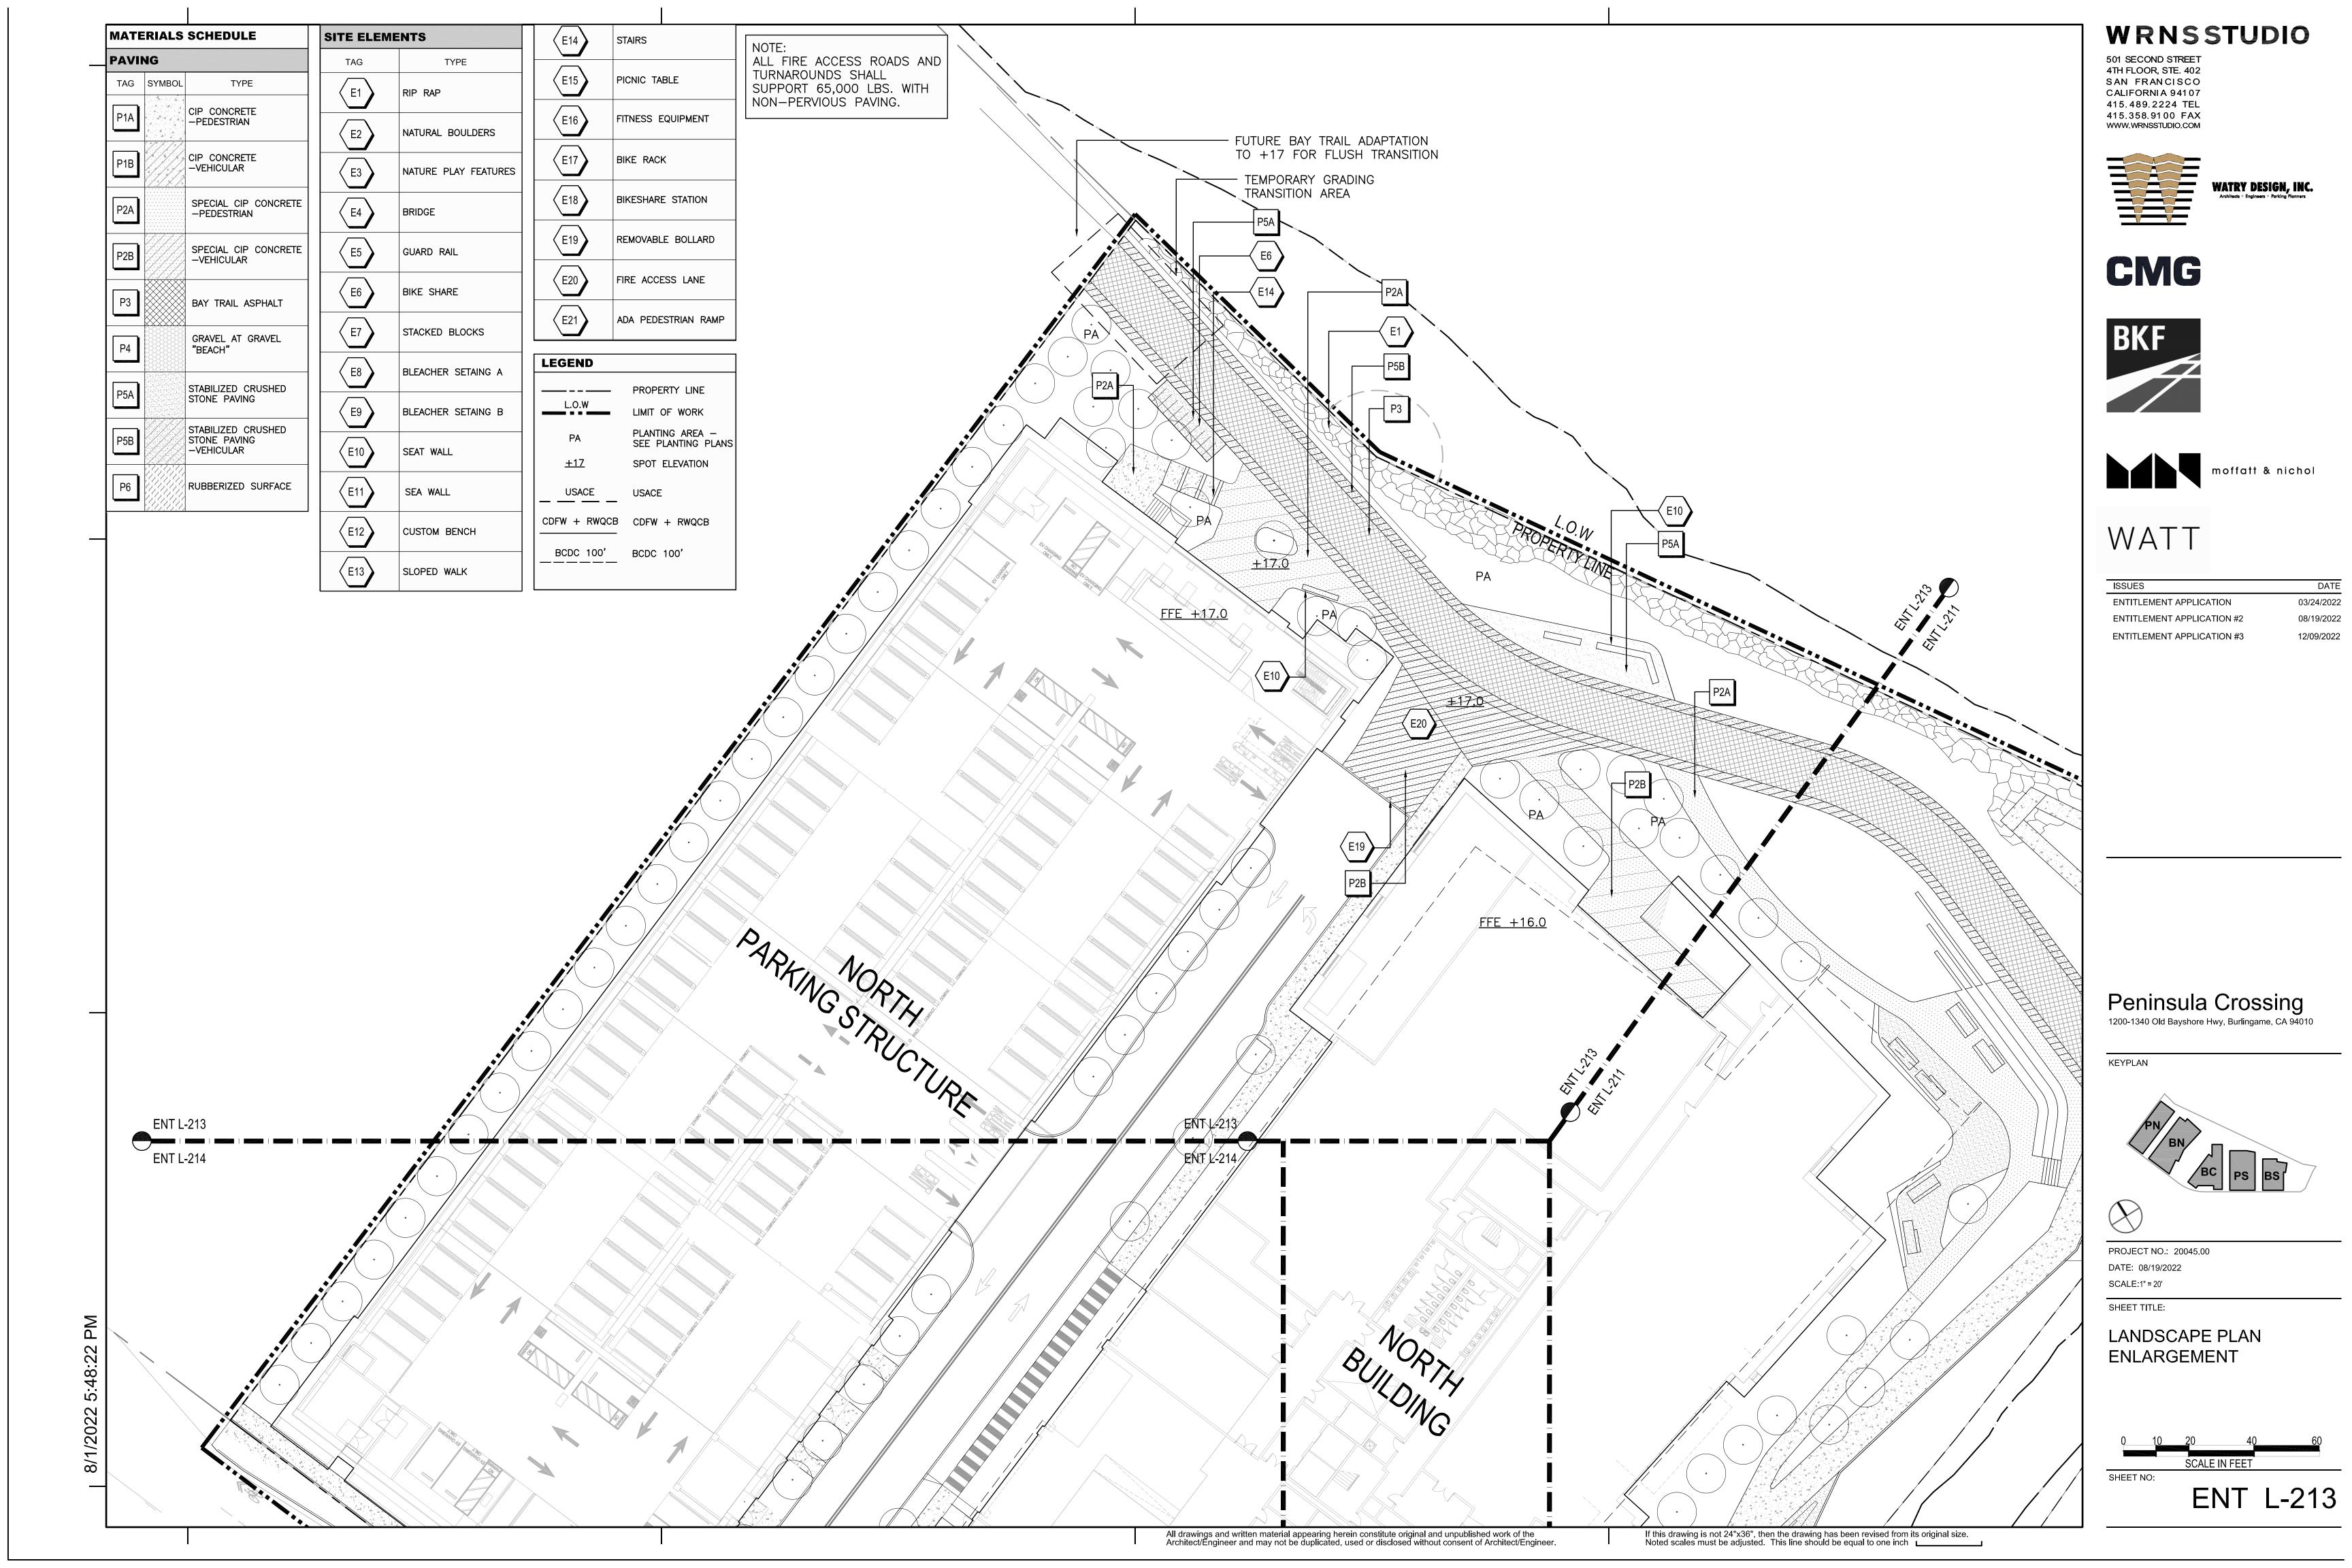
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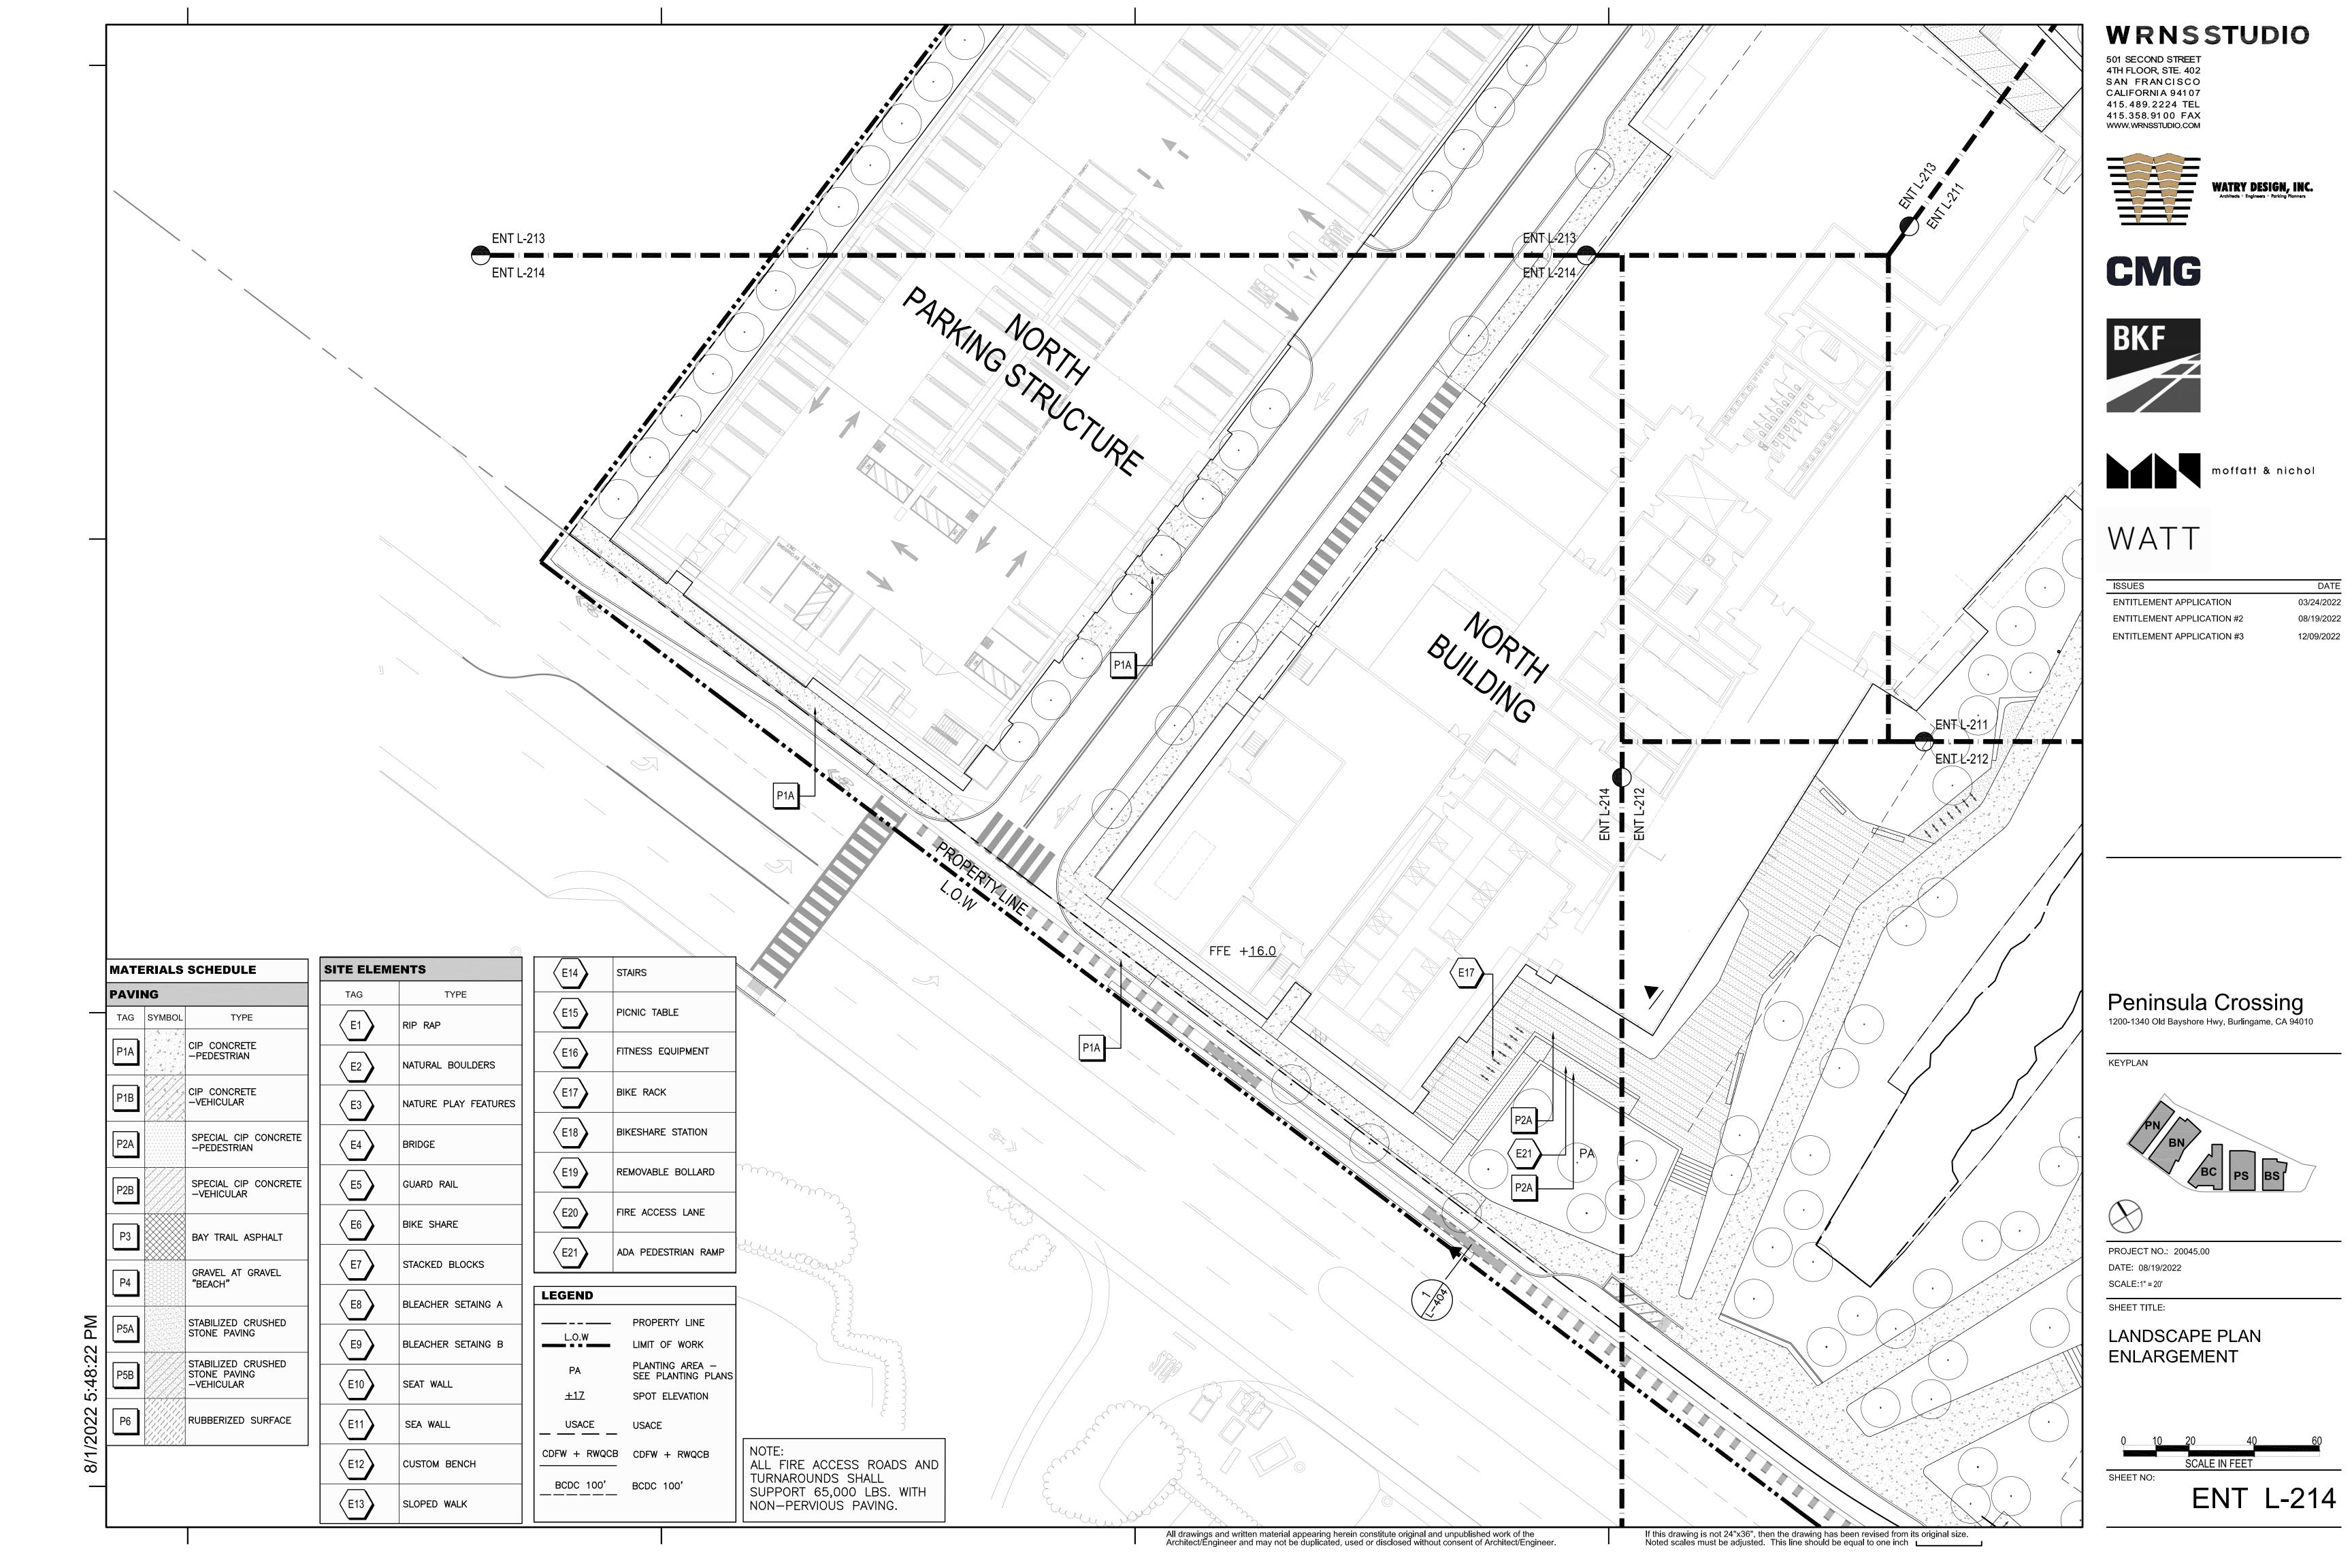
ACCESSIBLE RAMP WITH HANDRAILS - MAX 8.0% SLOPE

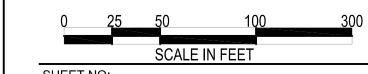






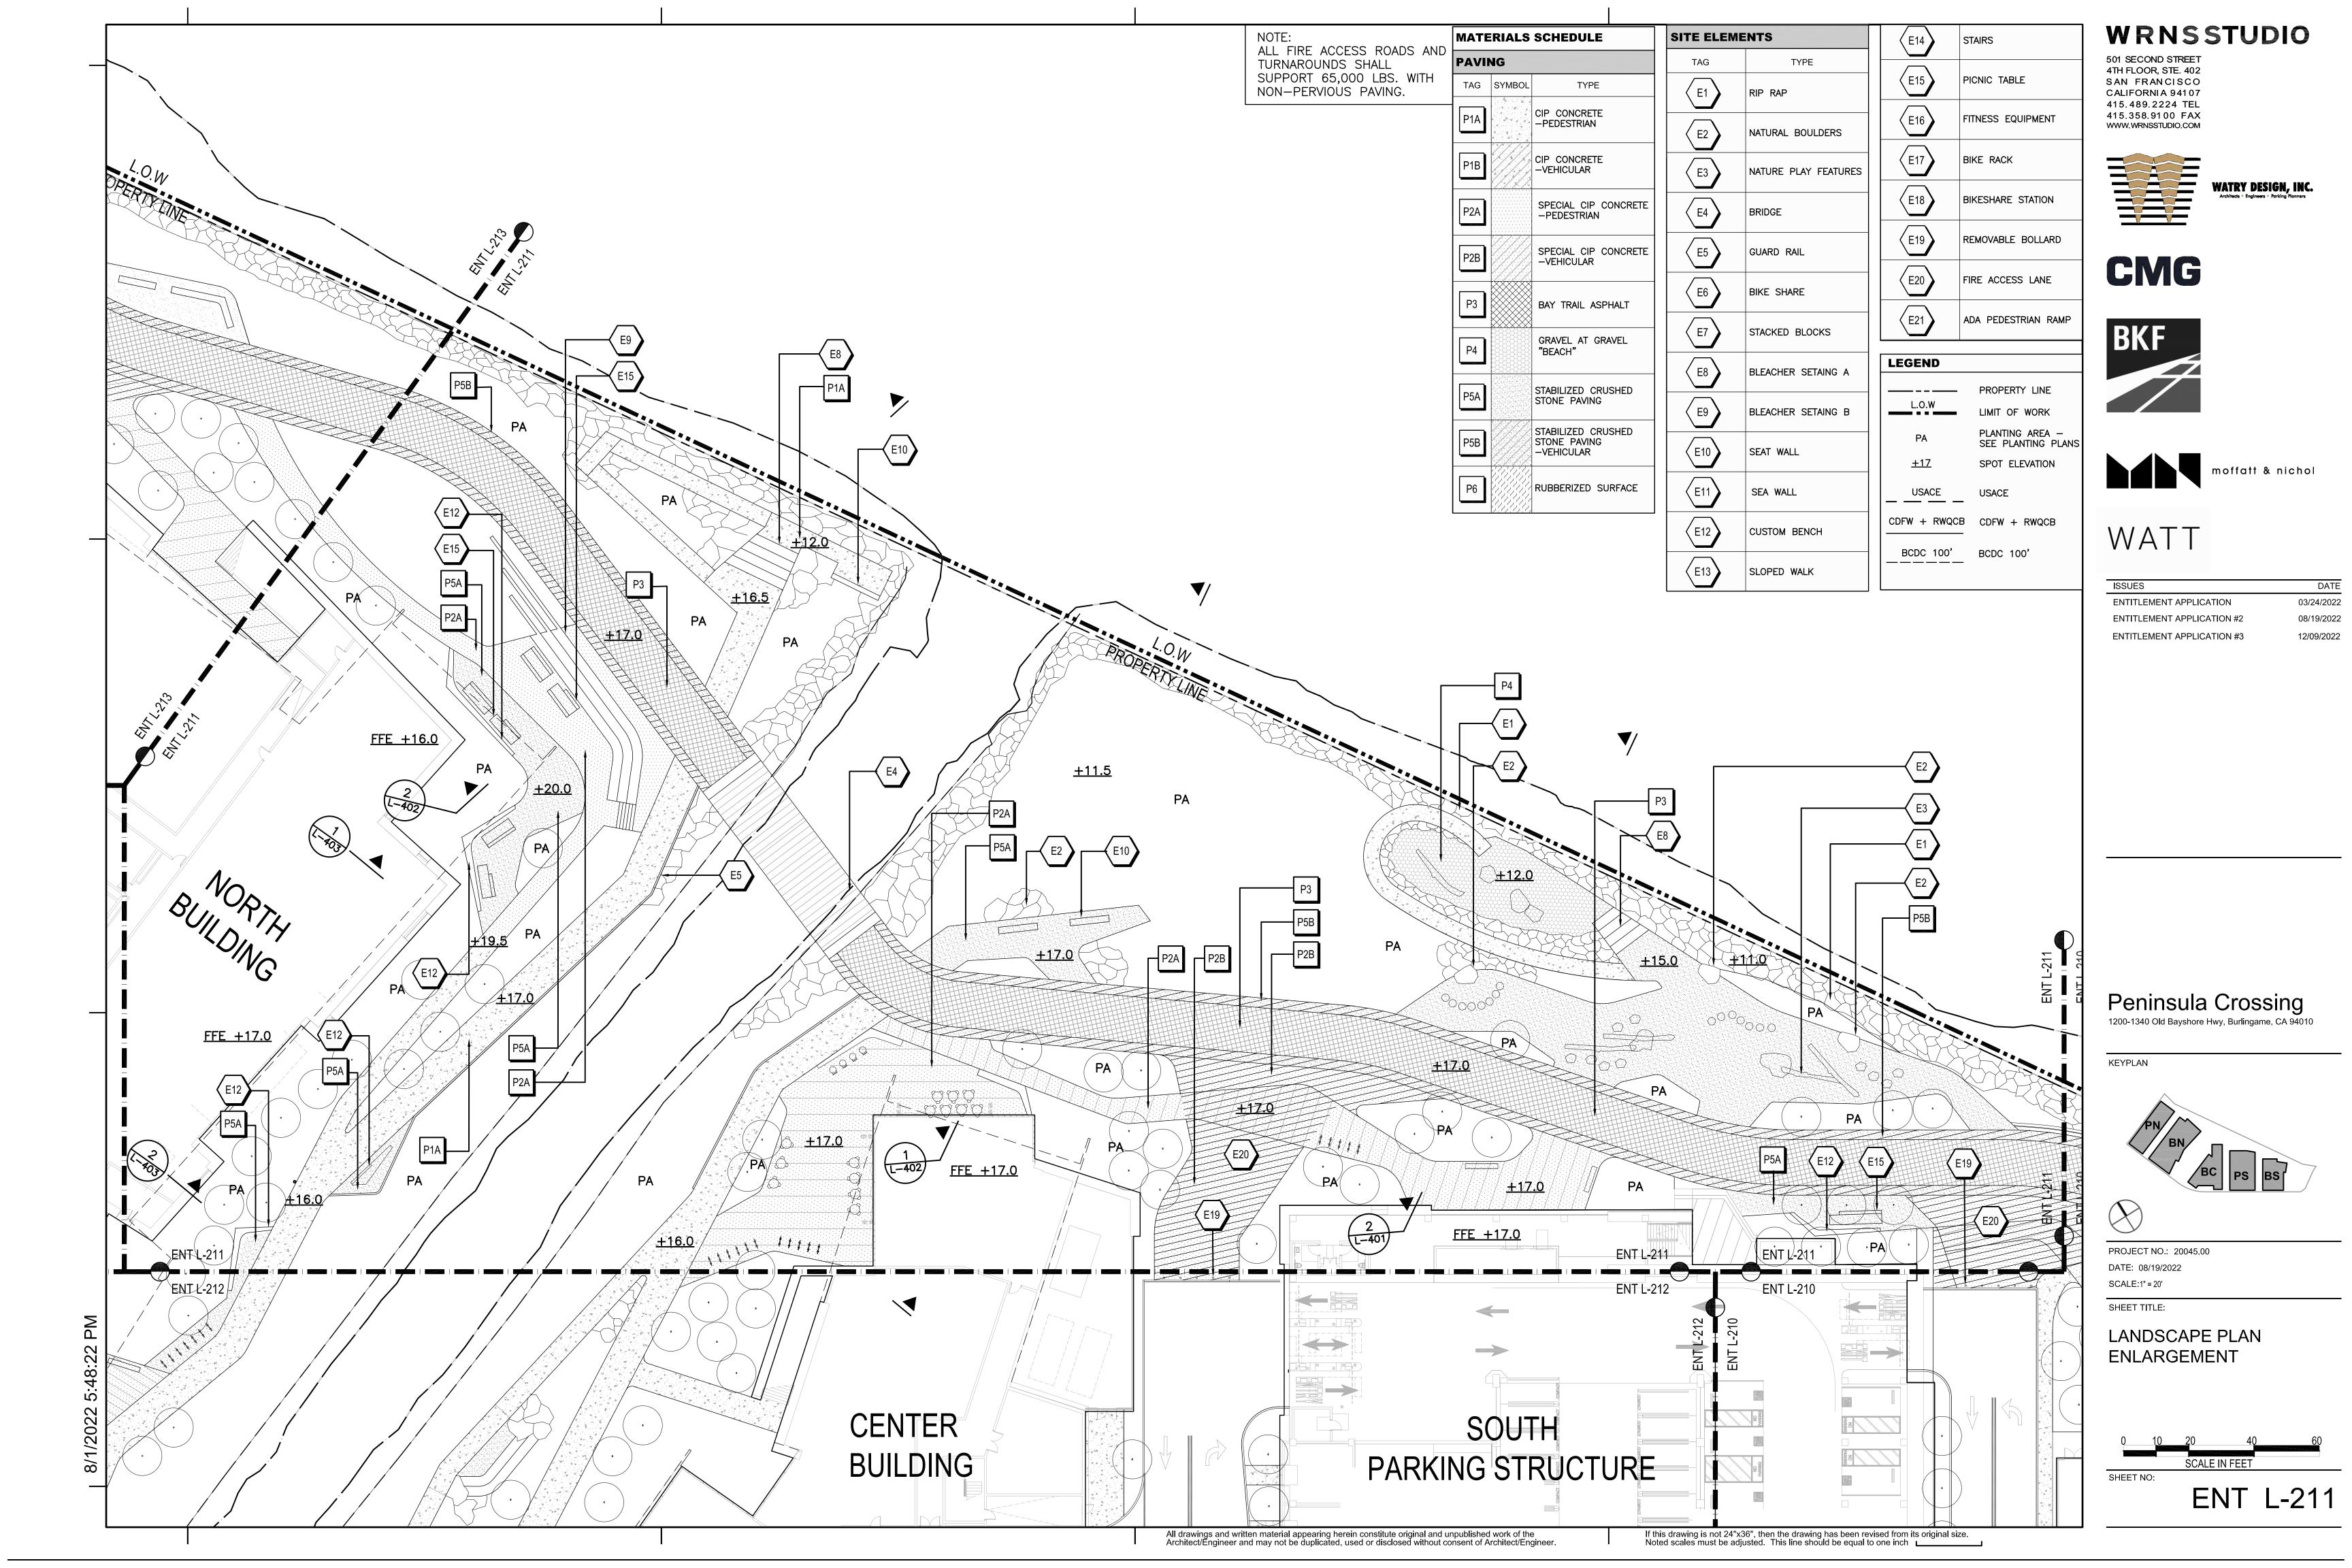

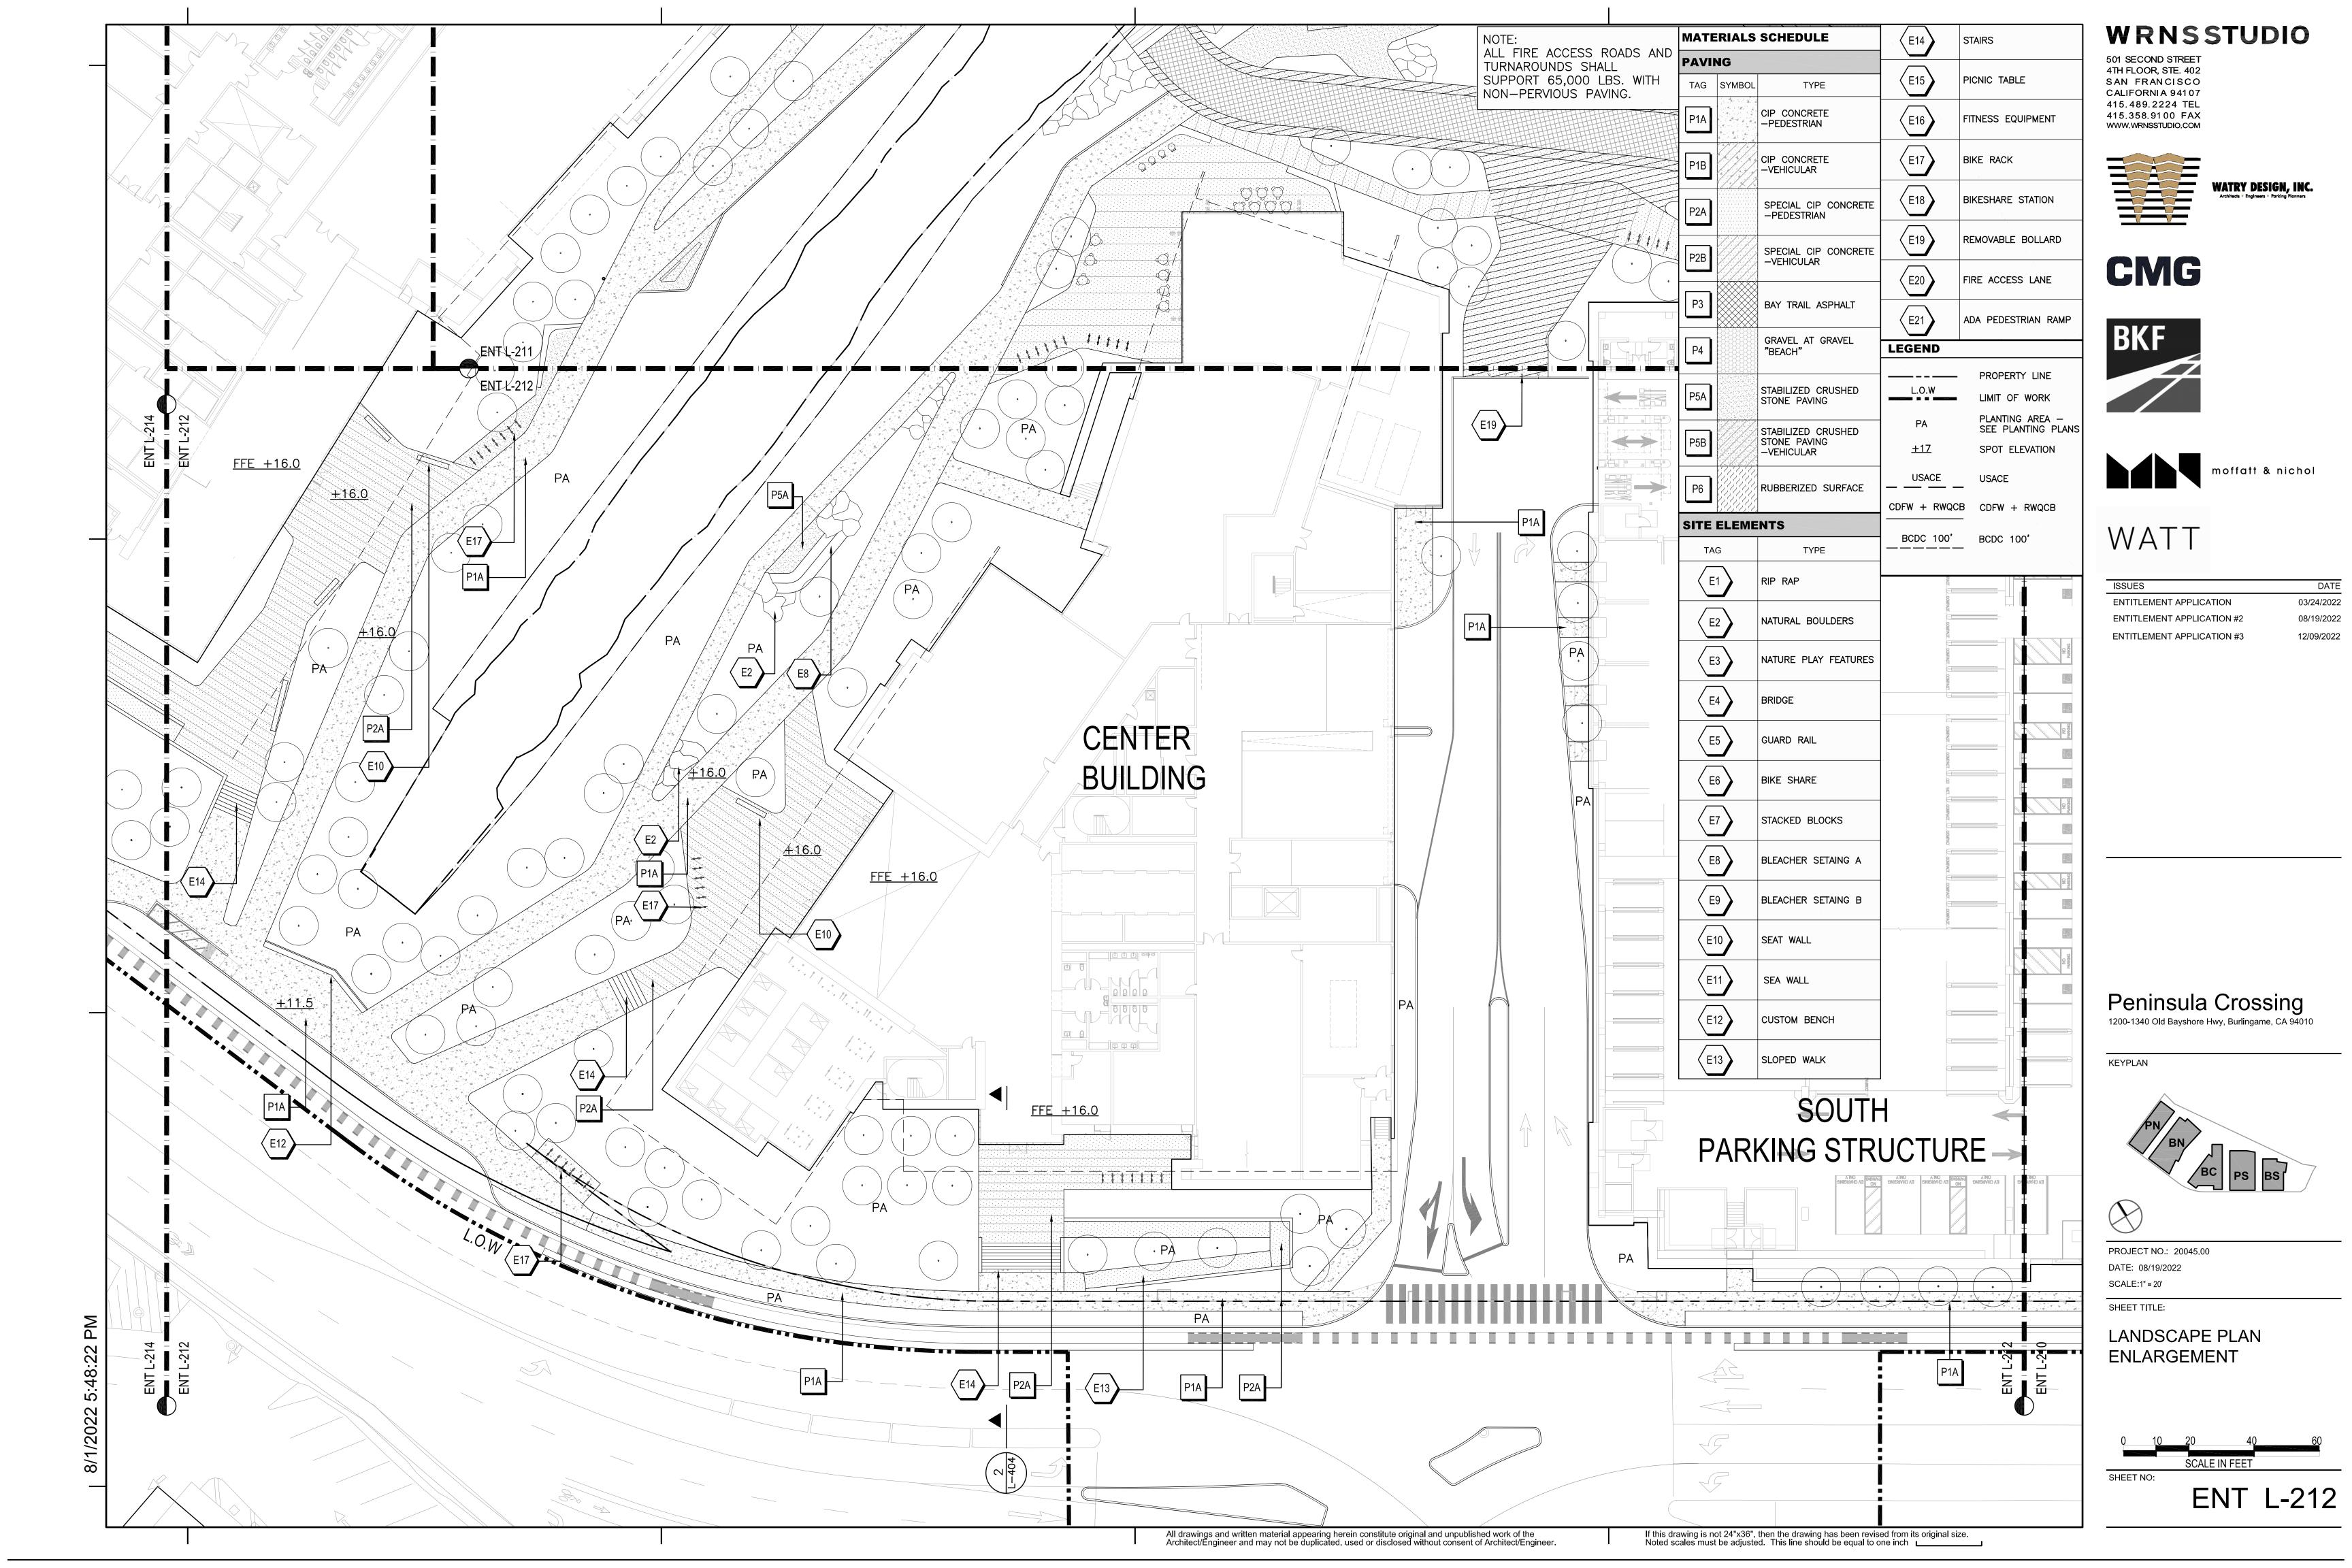

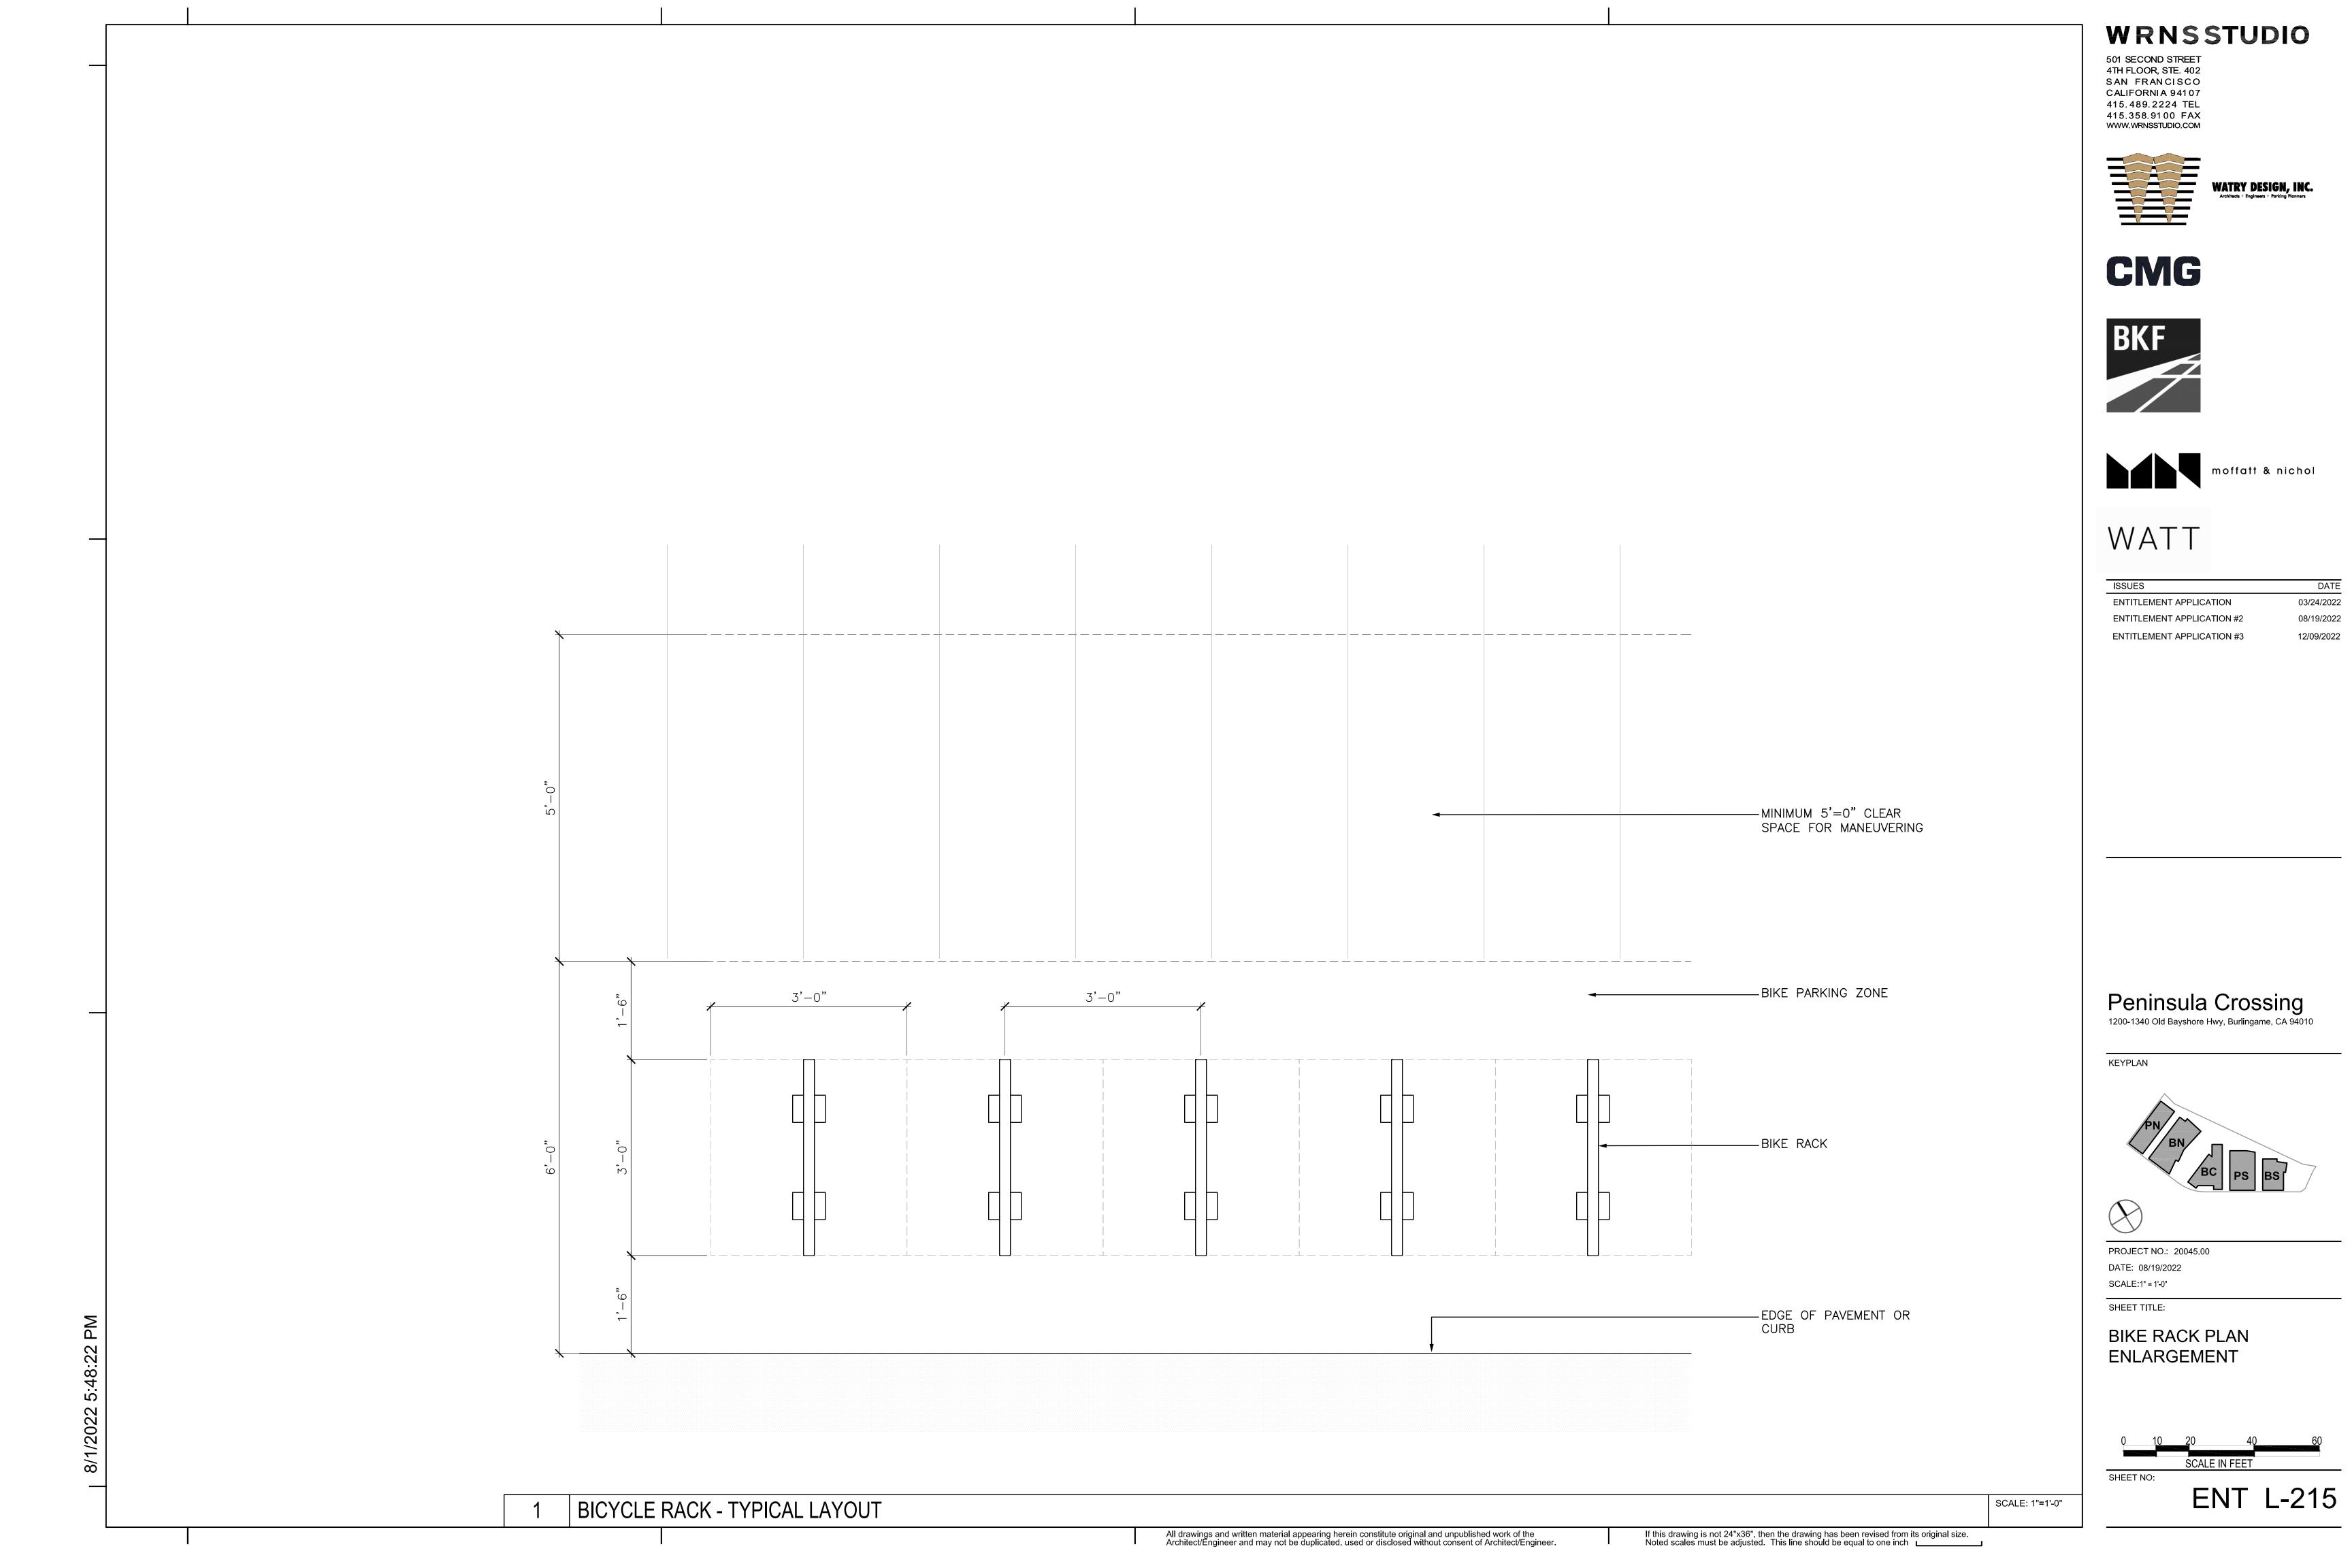

TREES				
SYMBOL	LATIN NAME	COMMON NAME	QTY.	SIZE
AES CAL  [•] 24	AESCULUS CALIFORNICA	CALIFORNIA BUCKEYE	3	24" BOX
ALN RHO  [•] 24	ALNUS RHOMBIFOLIA	WHITE ALDER	15	24" BOX
ARB MAR  [•  24	ARBUTUS MARINA	STRAWBERRY TREE	13	24" BOX
CER OCC  [•  24	CERCUS OCCIDENTALIS	WESTERN REDBUD	6	24" BOX
LOP CON  [•  24	LOPHOSTEMON CONFERTUS	BRISBANE BOX	93	24" BOX
			11	36" BOX
PIS CHI	PISTACIA CHINENSIS 'KIETH DAVEY'	CHINESE PISTACHE	20	24" BOX
			2	36" BOX
PLA ACE [ • ] 36	PLATANUS X ACERIFOLIA 'COLUMBIA'	COLUMBIA LONDON PLANE TREE	8	36" BOX
QUE AGR	QUERCUS AGRIFOLIA	COAST LIVE OAK	13	24" BOX
24			12	36" BOX
QUE VIR	QUERCUS VIRGINIANA	SOUTHERN LIVE OAK	29	24" BOX
24			6	36" BOX

#### TREE PLANTING NOTES

- BIRD-SAFE DESIGN: FRUITING TREES AND SHRUBS THAT ATTRACT BIRDS SHALL BE KEPT CLEAR OF BUILDING EDGES AND GLAZING, LANDSCAPE ARCHITECT SHALL CONSULT WITH ECOLOGIST PRIOR TO FINALIZING PLANTING PLAN TO ASSURE BIRD-SAFE DESIGN.
- ALL SITE TREES SHALL HAVE SUBDRAINAGE UNLESS OTHERWISE NOTED BY LANDSCAPE FINAL TREE SELECTION AND LAYOUT SHALL BE REFINED BASED ON THE FOLLOWING
- SELECTION CRITERIA: SOILS AND HORTICULTURAL SUITABILITY SALT AND WIND TOLERANCE
- WATER EFFICIENT LANDSCAPE ORDINANCE (WELO) REQUIREMENTS AESTHETIC QUALITY
- SUN & SHADE
- ECOLOGICAL VALUE/HABITAT AND ENVIRONMENTAL CONSIDERATIONS.

### **PLANTING NOTES**

**STREETCAPE** 

**TURF GRASS** 

**CONCEPT PLANT LIST** 

TAG

**BAYSHORE UPLAND - COASTAL SCRUB** 

P1-01

**EASTON CREEK UPLAND** 

**BUILDING EDGE PLANTING** 

**BAYSHORE HWY EDGE** 

P1-03

P1-04

P1-05

P1-06

P1-02

SYMBOL

SCIENTIFIC NAME

ARMERIA MARITIMA

ARTEMISIA CALIFORNICA

CEANOTHUS GRISEUS

ERIOGONUM LATIFOLIUM

ERIOGONUM NUDUM

ERIGERON GLAUCUS

ESCHSCHOLZIA CALIFORNICA

FRANGULA CALIFORNICA

LUPINUS ALBIFRONS

MYRICA CALIFORNICA

STIPA PULCHRA

MIMULUS AURANTIACUS

MUHLENBERGIA RIGENS

SISYRINCHIUM BELLUM

CALAMAGROSTIS FOLIOSA

FESTUCA CALIFORNICA

FRANGULA CALIFORNICA

MUHLENBERGIA RIGENS

RIBES SANGUINEUM GLUTINOSUM

MYRICA CALIFORNICA

CEANOTHUS SPECIES

CALAMAGROSTIS FOLIOSA

FESTUCA CALIFORNICA

MUHLENBERGIA RIGENS

LOMANDRA LONGIFOLIA 'BREEZE'

OLEA EUROPEA 'DWARF OLIVE'

WESTRINGIA FRUTICOSA 'MUNDI'

LOMANDRA LONGIFOLIA 'BREEZE'

PHORMIIUM 'SHIRAZ'

TURF GRASS

IRIS DOUGLASIANA

IRIS DOUGLASIANA

JUNCUS PATENS

ARCHTOSTAPHYLOS 'POINT REYES'

CEANOTHUS THYRSIFLORUS REPENS

CEANOTHUS THYRSIFLORUS REPENS

COAST'

ACHILLEA MILLEFOLIUM 'SONOMA

CEANOTHUS THYRSIFLORUS REPENS

BACCHARIS PILULARIS 'PIGEON POINT' DWARF COYOTE BUSH

- BIRD-SAFE DESIGN: FRUTING TREES AND SHRUBS THAT ATTRACT BIRDS SHALL BE KEPT CLEAR OF BUILDING EDGES AND GLAZING. LANDSCAPE ARCHITECT SHALL CONSULT WITH ECOLOGIST PRIOR TO FINALIZING PLANTING PLANS TO ASSURE BIRD-SAFE DESIGN.
- 2. FINAL PLANT SELECTION AND LAYOUT SHALL BE REFINED BASED ON THE FOLLOWING SELECTION CRITERIA:
  - SOILS AND HORTICULTURAL SUITABILITY
  - SALT AND WIND TOLERANCE
  - WATER EFFICIENT LANDSCAPE ORDINANCE (WELO) REQUIREMENTS
  - AESTHETIC QUALITY
- ECOLOGICAL VALUE/HABITAT AND ENVIRONMENTAL CONSIDERATIONS, INCLUDING ADJACENT CREEK AND WETLAND HABITAT
- SUN & SHADE

#### WATER EFFICIENT LANDSCAPING ORDINANCE (WELO)

- PER CODE SECTION 25.36.020, THE PLANTING DESIGN CONFORMS TO CHAPTER 18.17 OF THE MUNICIPAL CODE AND THE CALIFORNIA CODE OF REGULATIONS SECTIONS 490,495, CHAPTER 2.7, DIVISION 2 TITLE 23 MODEL WATER-EFFICIENT LANDSCAPE ORDINANCE. 2. ALL LANDSCAPE PLANTING AREAS SHALL INCLUDE A 3 INCH MINIMUM LAYER OF MULCH.
- 3. PROVIDE DRIP IRRIGATION TO ALL PLANTING AREAS. PROVIDE COPPER SUPPLY LINES AND CONTROL WIRE CONDUIT TO EACH PLANTER.

#### LANDSCAPING NOTES

SIZE

1 GAL

5 GAL

1 GAL

1 GAL

15 GAL

1 GAL

15 GAL

15 GAL

1 GAL

1 GAL

1 GAL

1 GAL

15 GAL

1 GAL

1 GAL

1 GAL

1 GAL

1 GAL

15 GAL

1 GAL

SOD

BOTANICAL NAME

THRIFT SEAPINK

CALIFORNIA LILAC

SEASIDE BUCKWHEAT

SEASIDE SEASIDE DAISY

STICKY MONKEYFLOWER

PURPLE NEEDLE GRASS

POINT REYES MANZANITA

MENDOCINO REED GRASS

PROSTRATE BLUE BLOSSOM

PROSTRATE BLUE BLOSSOM

CALIFORNIA FESCUE

COFFEEBERRY

DOUGLAS IRIS

COMMON RUSH

BLUE BLOSSOM

DOUGLAS IRIS

DEER GRASS

DWARF MAT RUSH

DWARF MAT RUSH

TURF GRASS

NEW ZEALAND FLAX

LOW COAST ROSEMARY

DWARF OLIVE

PACIFIC WAX MYRTLE

PINK FLOWERING CURRANT

MENDOCINO REED GRASS

CALIFORNIA FESCUE

DEER GRASS

BLUE-EYED GRASS

PACIFIC WAX MYRTLE

NUDE BUCKWHEAT

CALIFORNIA POPPY

COFFEEBERRY

SILVER LUPINE

DEERGRASS

YARROW 'SONOMA COAST'

CALIFORNIA SAGEBRUSH

CREEPING BLUE BLOSSOM

- PER CODE SECTION 25.36.020 LANDSCAPE AREAS SHALL PRIMARILY CONSIST OF GRASS, ANNUALS, PERENNIALS, GROUNDCOVER, SHRUBS, TREES AND OTHER LIVING VEGETATION.
- 2. ARTIFICIAL TURF IS NOT USED
- 3. PER CODE SECTION 25.36.020 "LANDSCAPE COVERAGE REQUIREMENTS FOR COMMERCIAL INDUSTRIAL, AND MIXED USE ZONES": SHRUBS, GROUNDCOVER, AND OTHER PLANT MATERIAL SHALL COVER ALL AREAS NOT OCCUPIED BY STRUCTURES, PARKING AREAS, STORAGE, TRASH ENCLOSURES, DRIVEWAYS, AND SIDEWALKS, AND OTHER PEDESTRIAN AREAS.
- 4. PER CODE SECTION 25.36.020 "LANDSCAPE IRRIGATION AND MAINTENANCE" THE PROPERTY OWNER SHALL MAINTAIN RETAINING WALLS, CRIBBING, DRAINAGE STRUCTURES, PLANTED SLOPES, AND OTHER PROTECTIVE DEVICES IN GOOD CONDITION AND REPAIR AT ALL TIMES.

#### **IRRIGATION NOTES**

- Primary irrigation for all planting areas will be sub-surface drip or bubbler based irrigation, with drip tubes at 18-inches on center.
- 2. Secondary microspray at select planting areas.
- 3. Spray or Rotor irrigation in no-mow turf area only.
- 4. Moisture sensors shall be provided in each planting zone/micro-climate.
- 5. Provide quick couplers at every 100 feet of mainline
- 6. Locate controllers in mechanical rooms. 7. Location of valves and other components shall be consolidated and to reduce visual impact.
- 8. PVC lateral pipes will serve the sub-surface system from copper mainline(s) from the building.
- 9. Coordinate irrigation penetrations with MEP and Waterproofing engineers.

#### **SOIL NOTES**


- 1. ALL ON-GRADE PLANTING AREAS SHALL HAVE MINIMUM 12" DEPTH OF IMPORTED HORTICULTURAL TOPSOIL.
- 2. ALL ON-STRUCTURE GROUNDCOVER PLANTING SHALL HAVE 12-24" DEPTH OF IMPORTED SOIL MIX ENGINEERED FOR ON STRUCTURE PLANTING.
- 3. TREE PLANTING ON GRADE SHALL HAVE AMENDED SOIL FOR MINIMUM 10 SQUARE FEET AT THE DEPTH OF THE TREE BOX.

#### LANDSCAPING COVERAGE REQUIREMENTS

#### TOTAL SITE


<u>T</u>	OTAL SITE:				
		LANDSCAPING DEFINITION	ALLOWED/REQUIRED	LANDSCAPING PROVIDED	COMPLIANT?
Т	OTAL SITE:	PER C.S. 25.36.020(B) LANDSCAPING CONSISTS "PRIMARILY OF GRASS, ANNUALS, PERENNIALS, GROUNDCOVER, SHRUBS, TREES, AND OTHER LIVING VEGETATION." THERE IS NO ARTIVICIAL TURF IN THIS PROPOSED PLAN.	20% OF TOTAL SITE AREA WITHIIN PROPERTY LINE SHALL BE LANDSCAPING.	SITE AREA: 523,775 sq. ft.  LANDSCAPING IN SITE AREA: 137,553 sq ft.	YES  26.2%  LANDSCAPE  COVERAGE

### LANDSCAPE COVERAGE

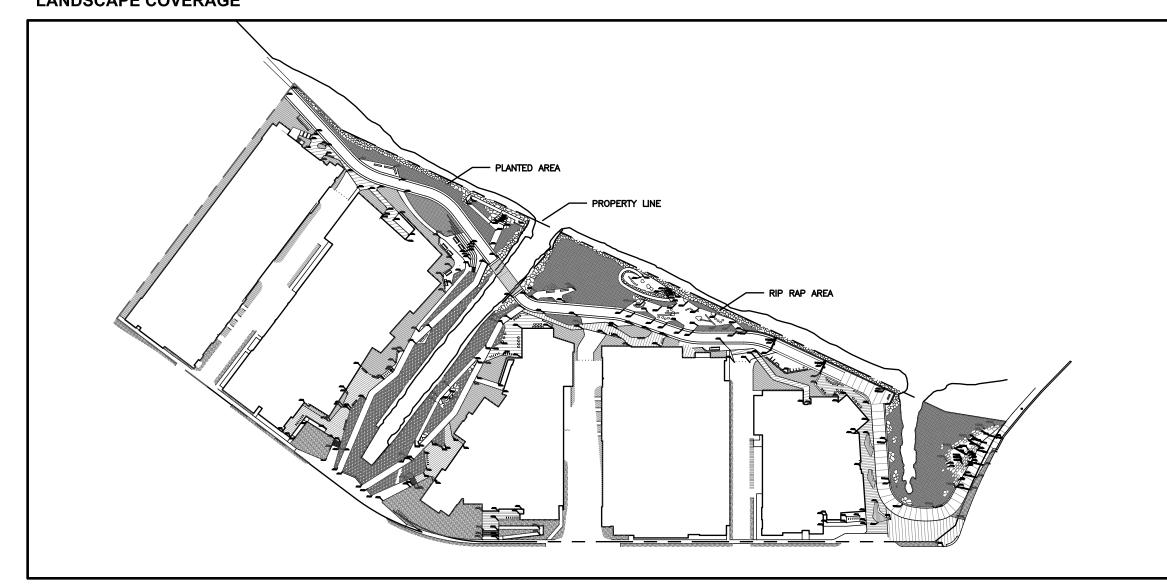

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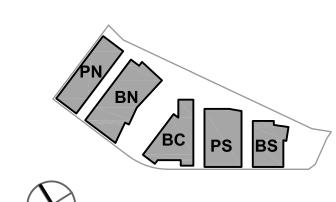


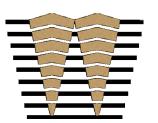

ISSUES	DATE
ENTITLEMENT APPLICATION	03/24/2022
ENTITLEMENT APPLICATION #2	08/19/2022
ENTITLEMENT APPLICATION #3	12/09/2022

Peninsula Crossing 1200-1340 Old Bayshore Hwy, Burlingame, CA 94010

KEYPLAN




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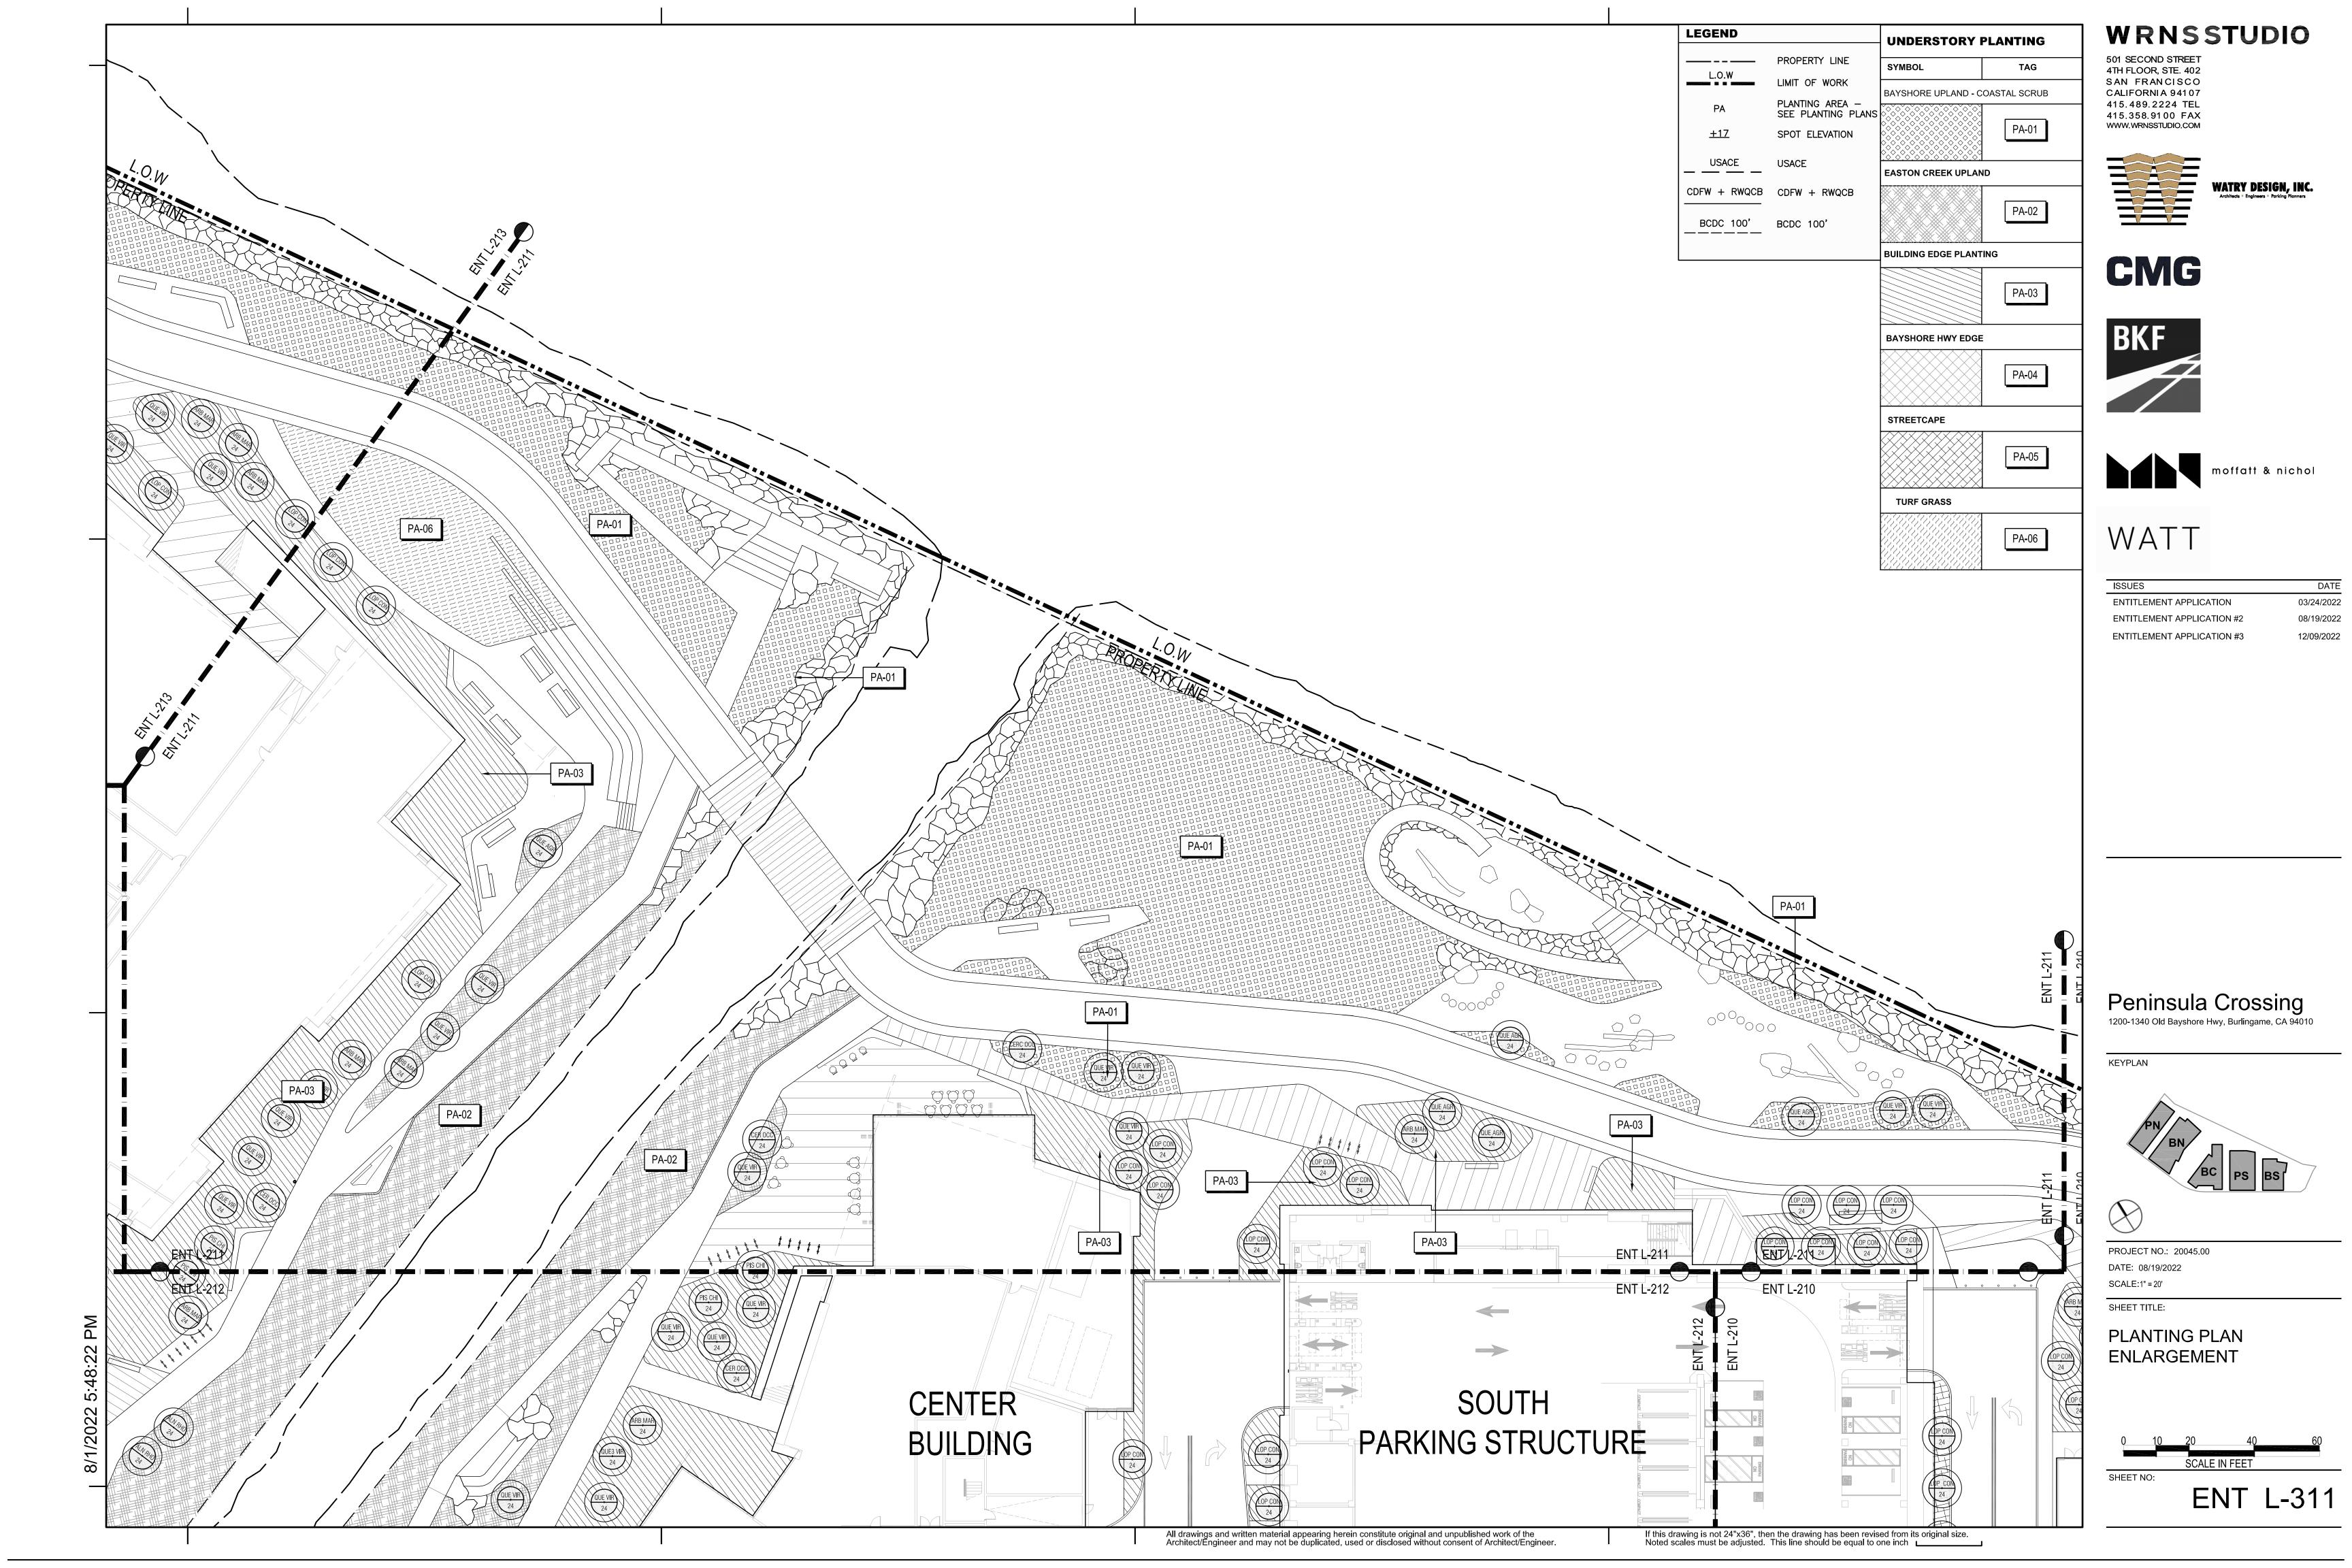
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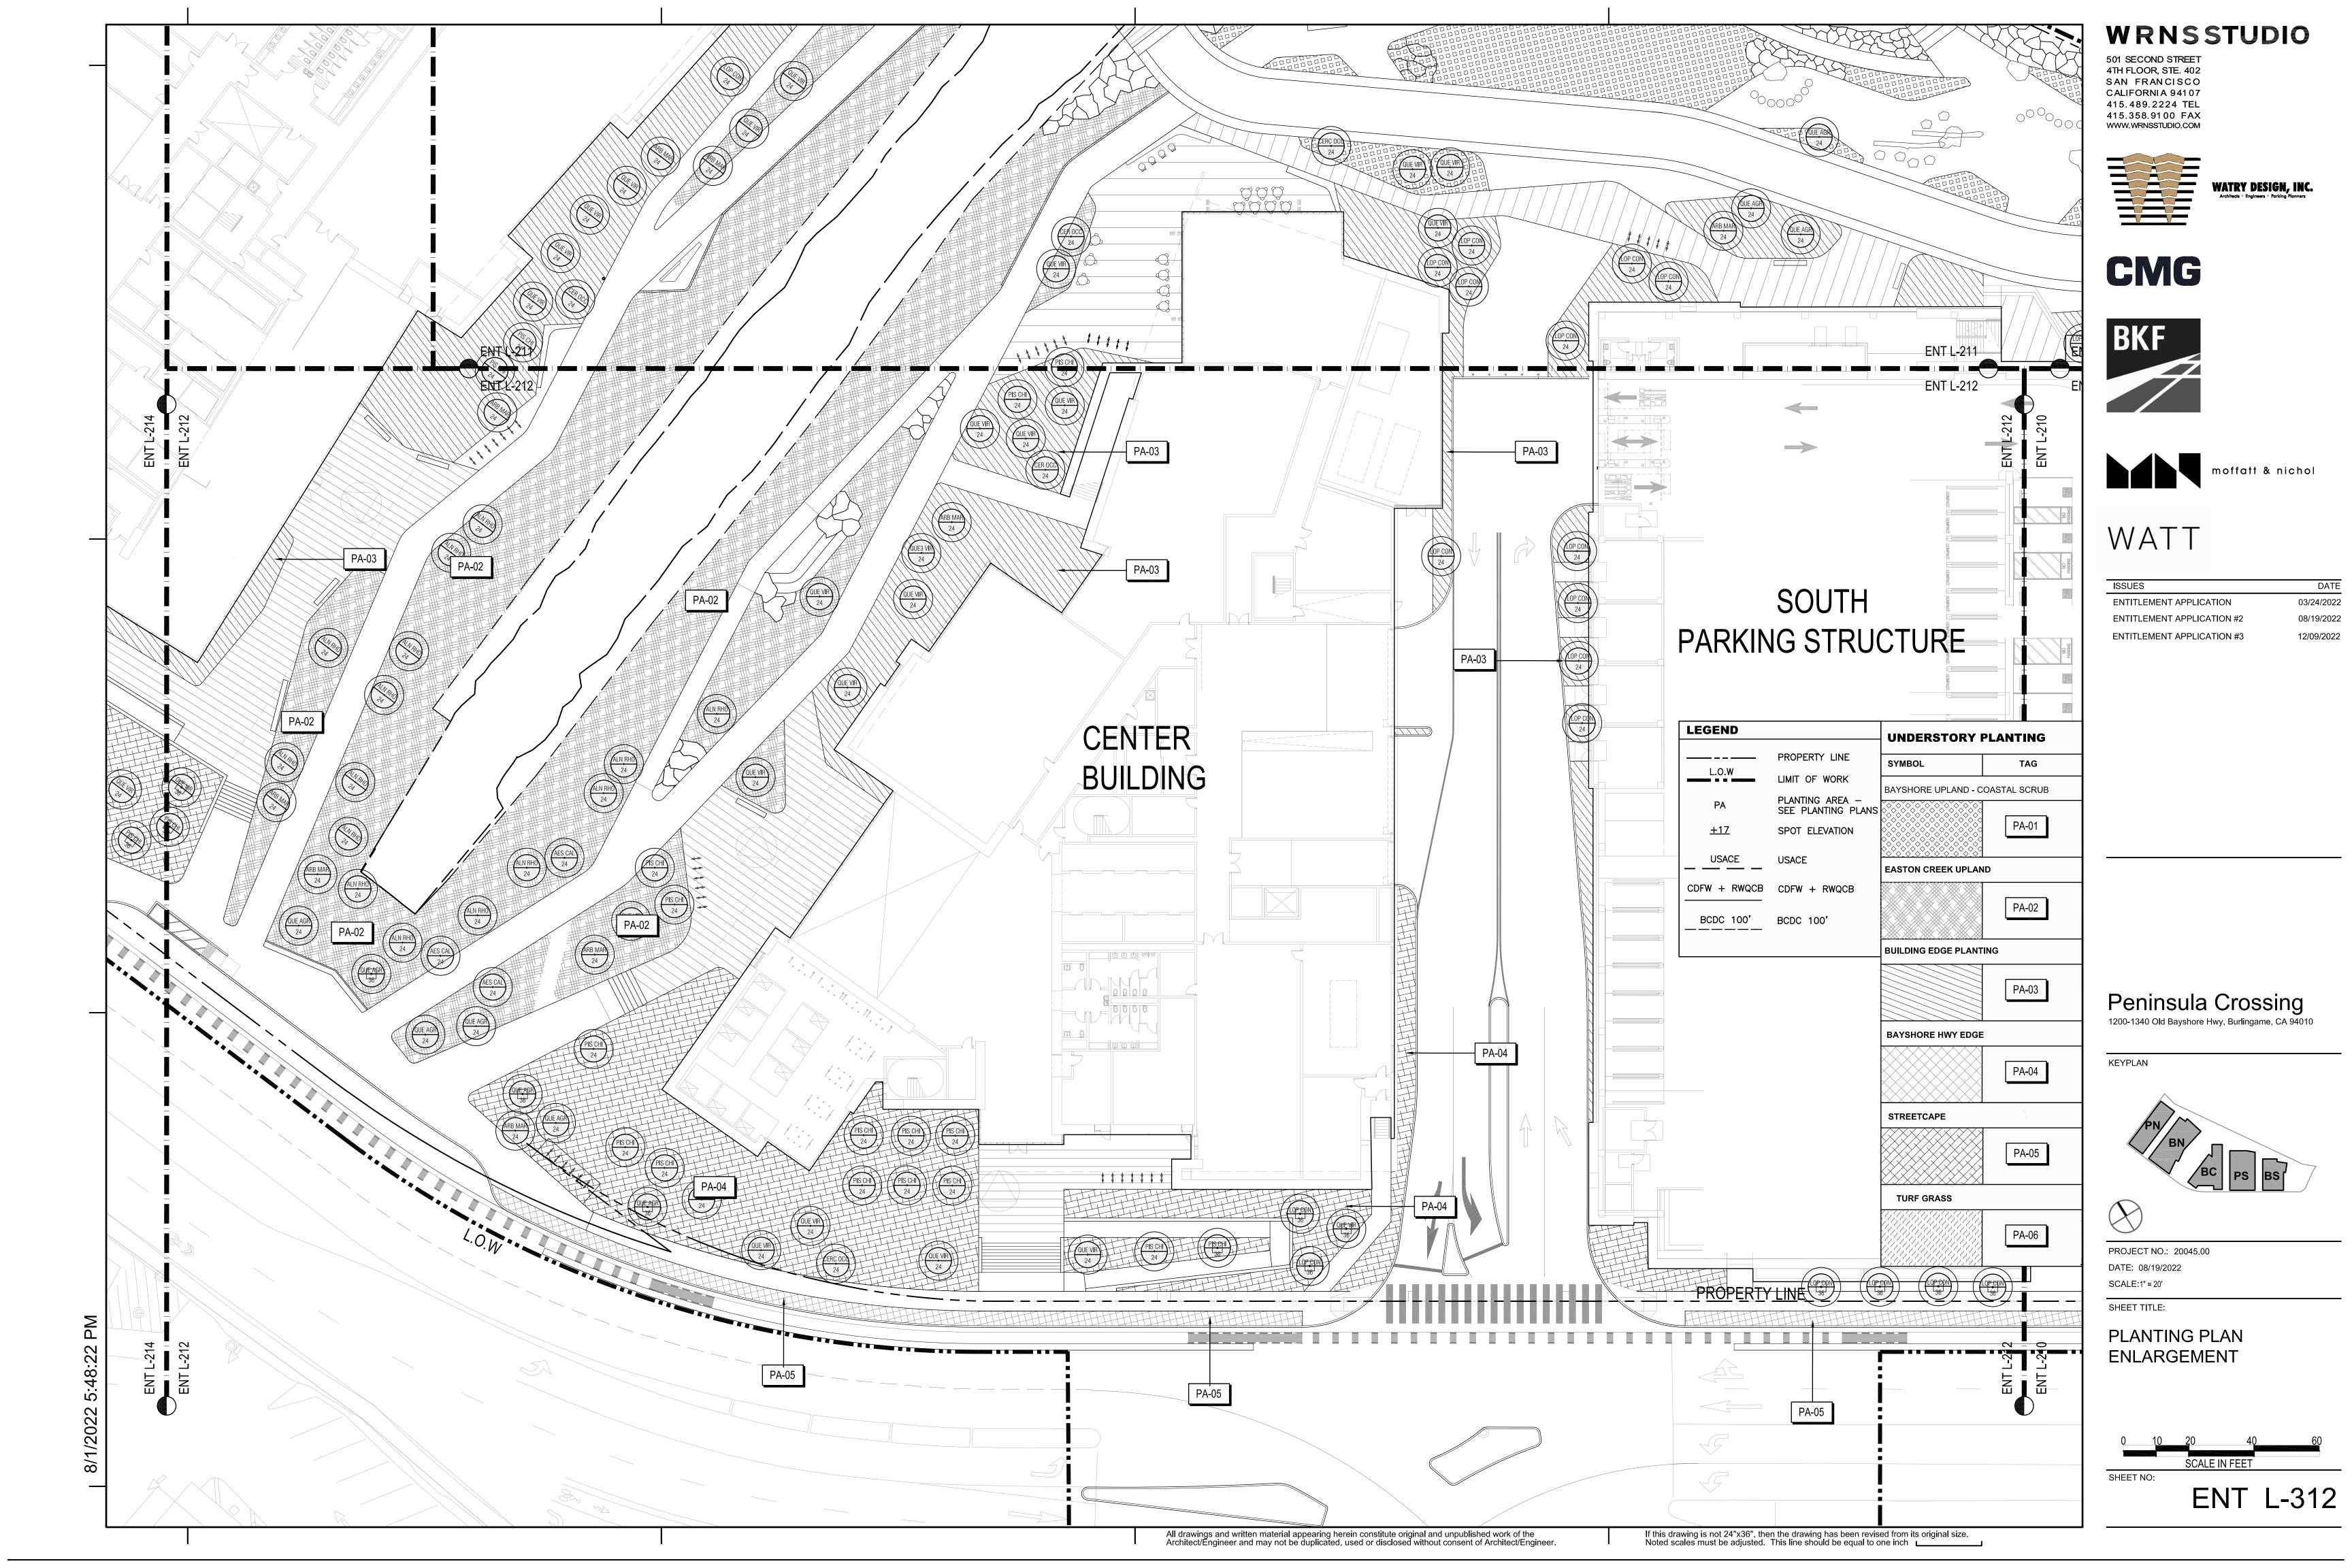
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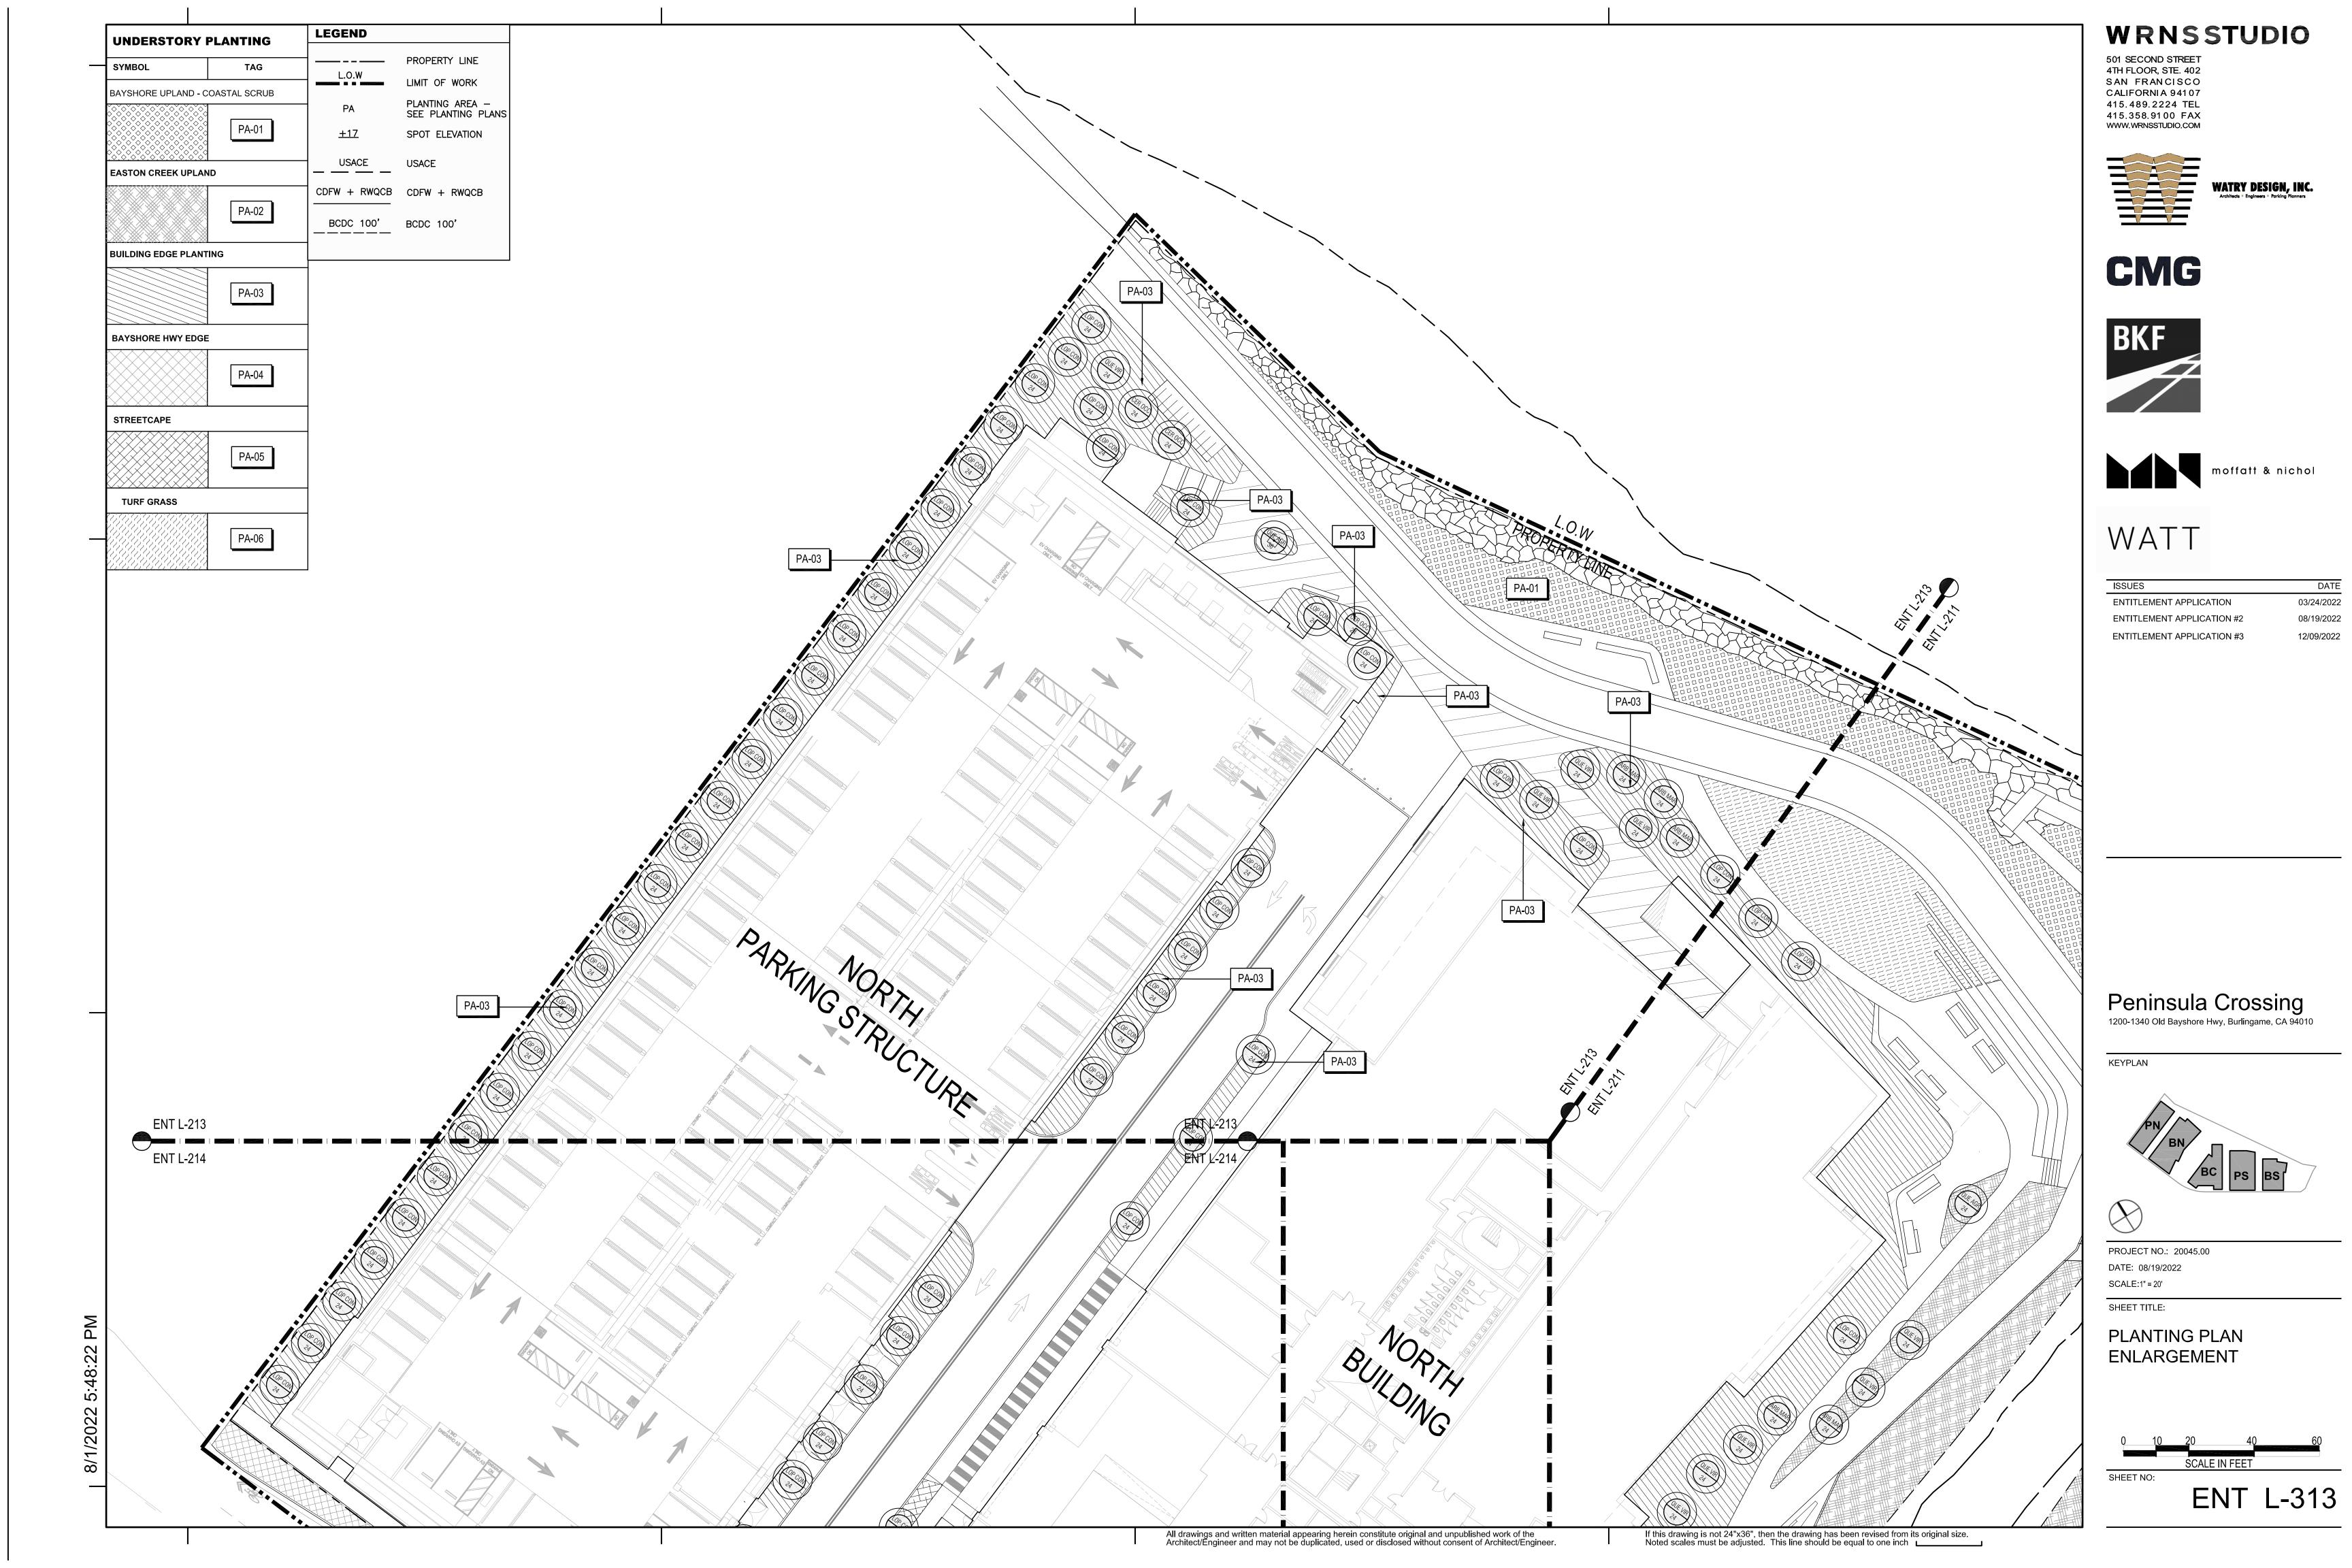
LANDSCAPE PLANTING SCHEDULE











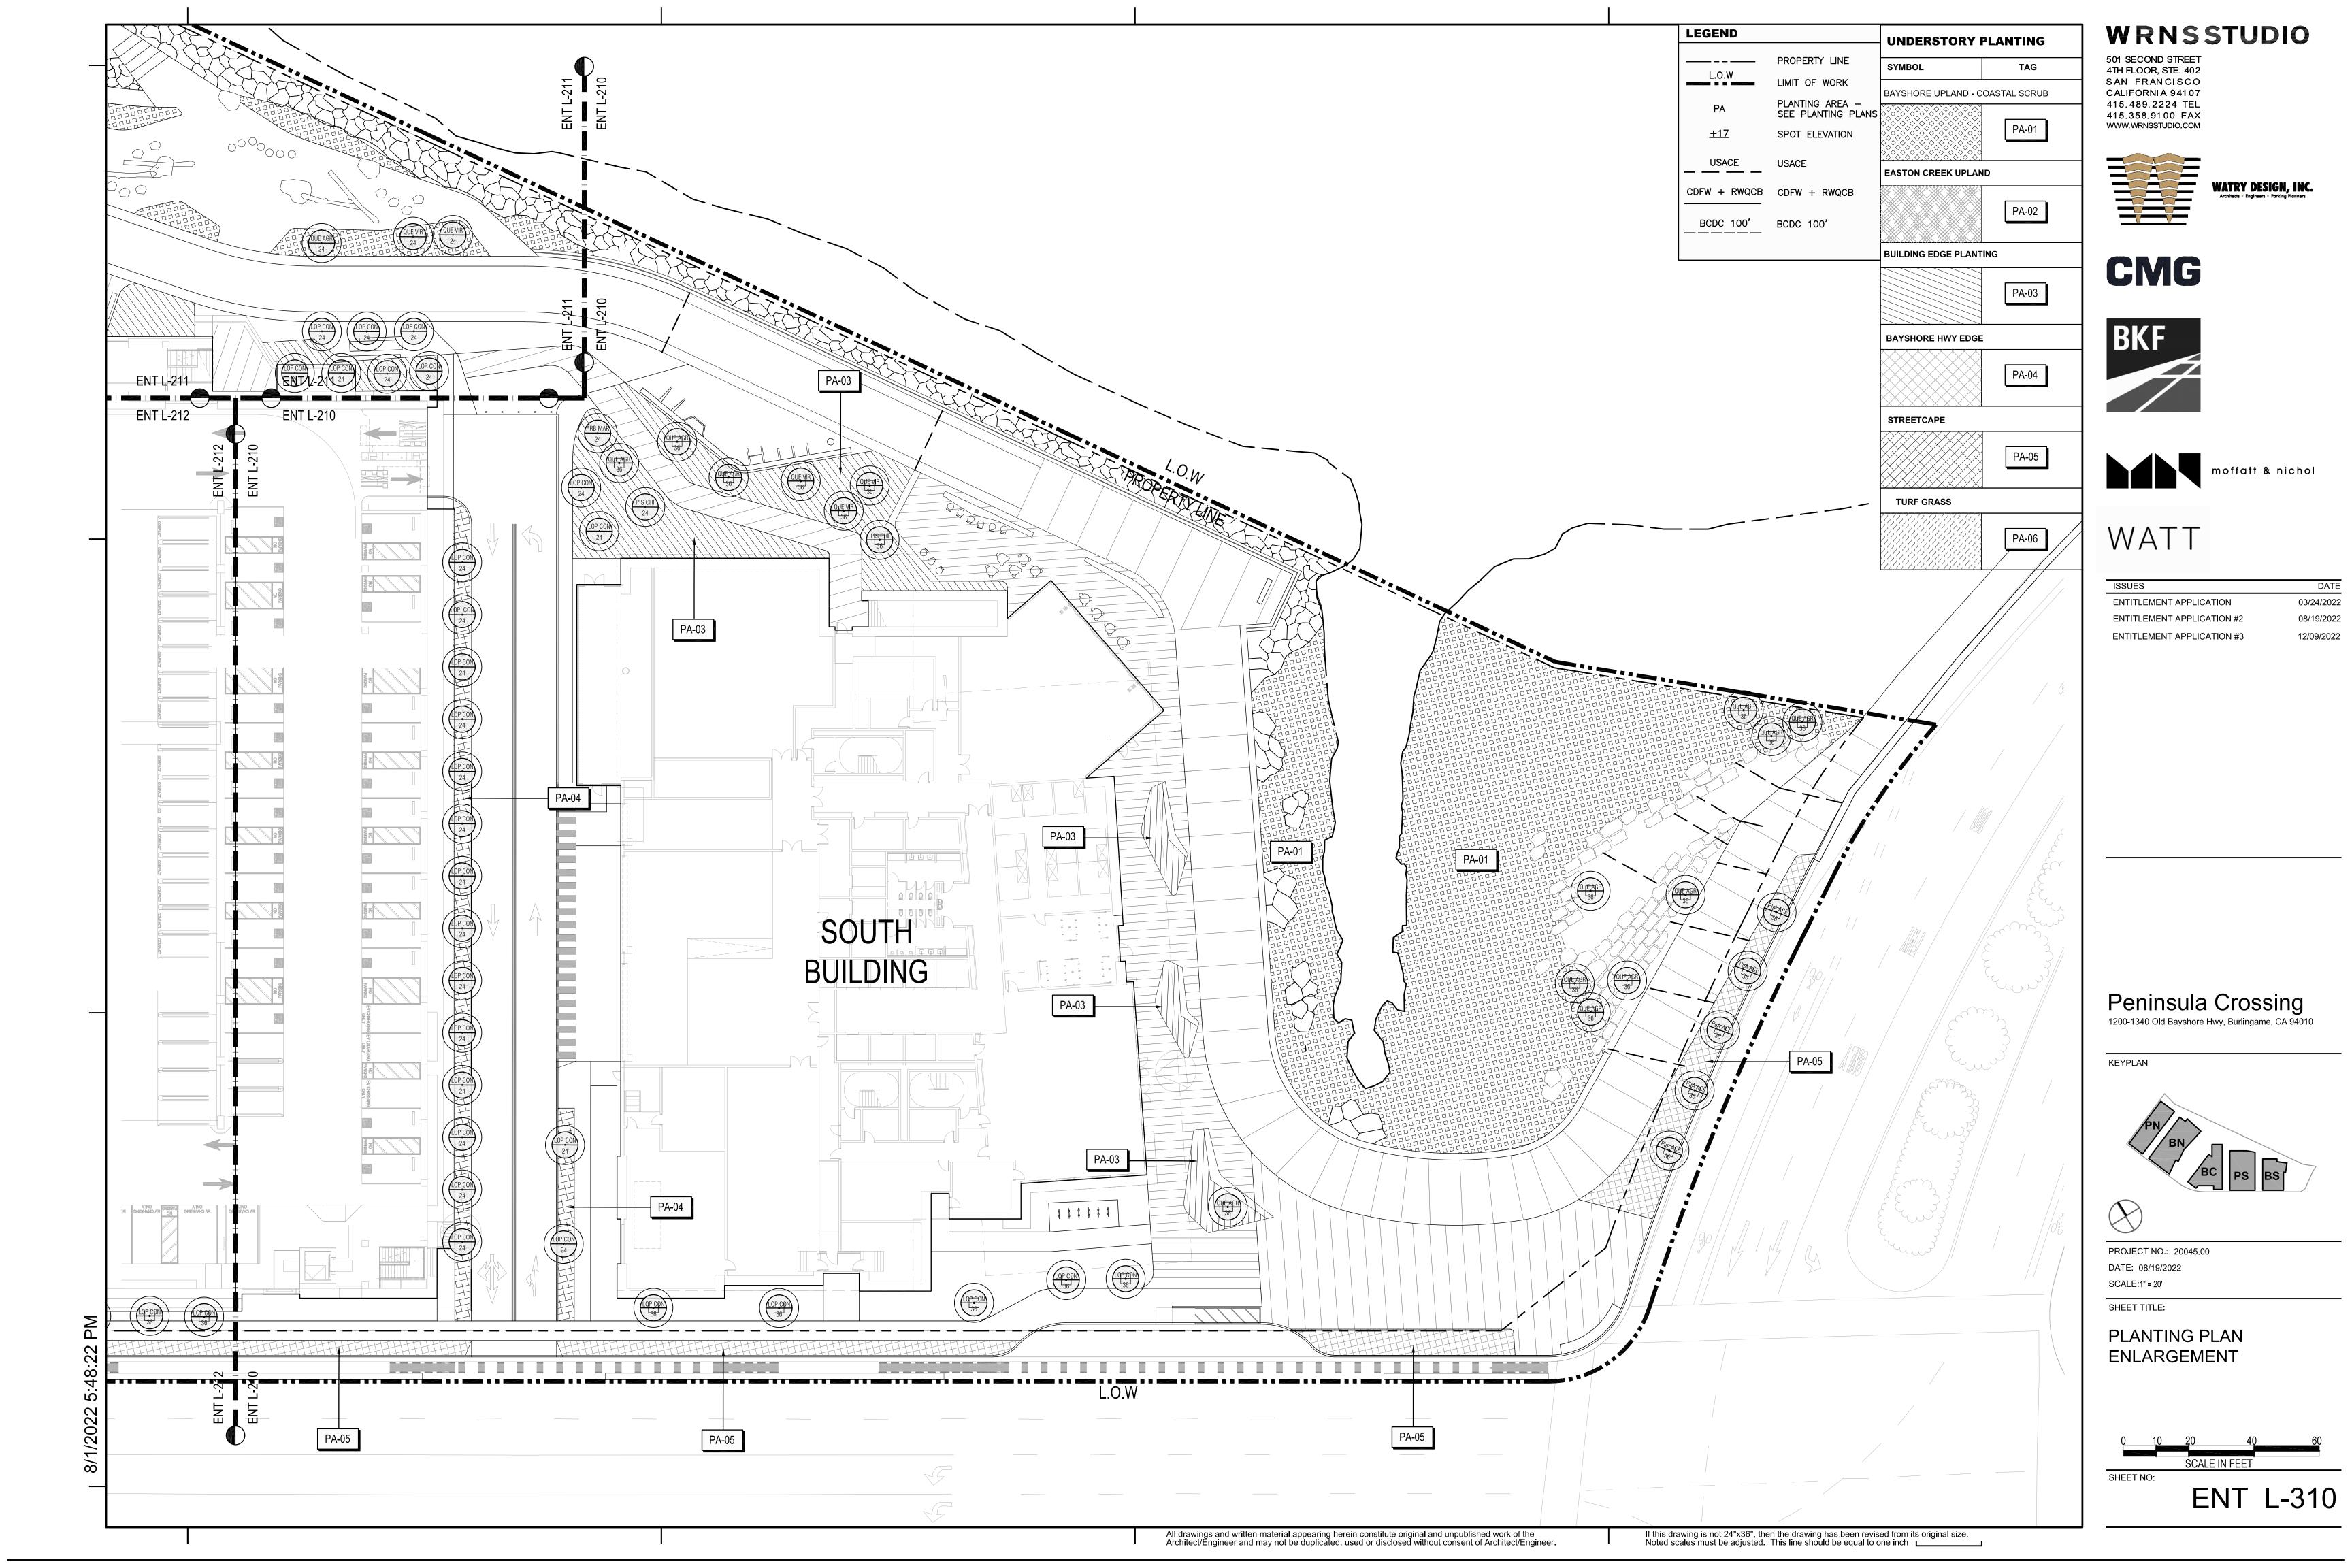

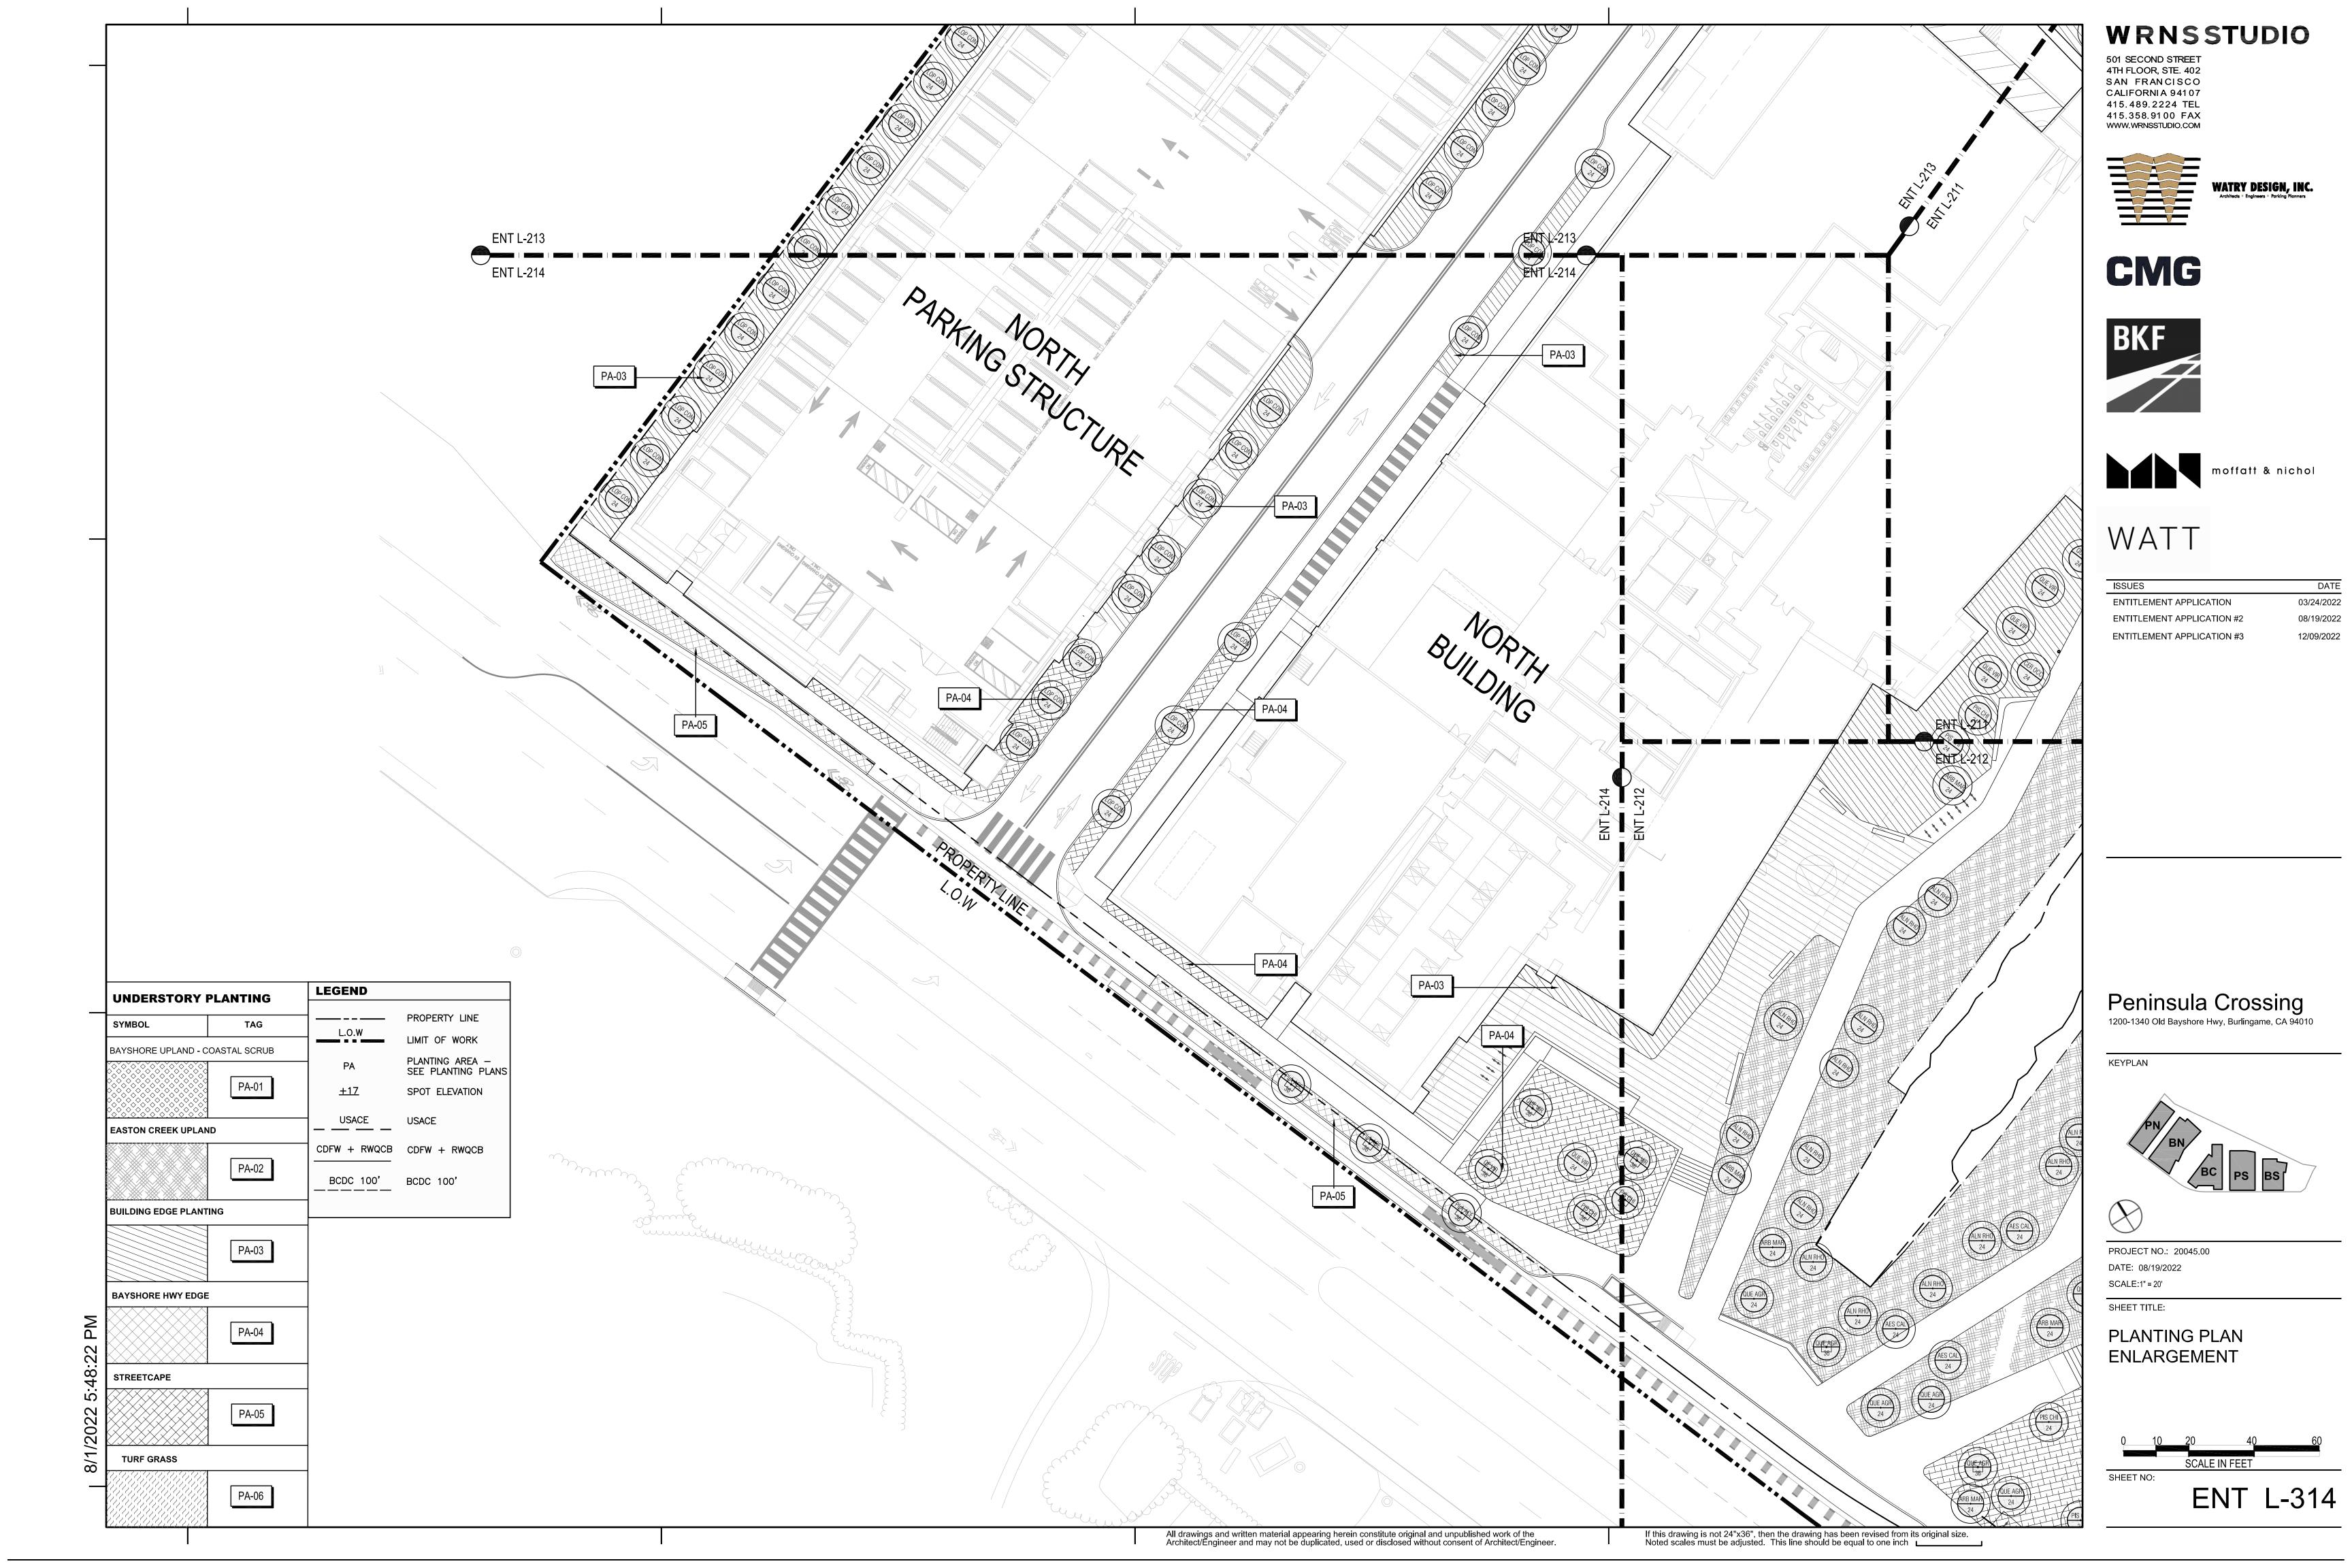



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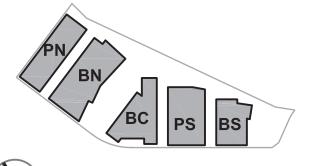
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ISSUES [
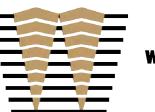
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Peninsula Crossing
1200-1340 Old Bayshore Hwy, Burlingame, CA 94010

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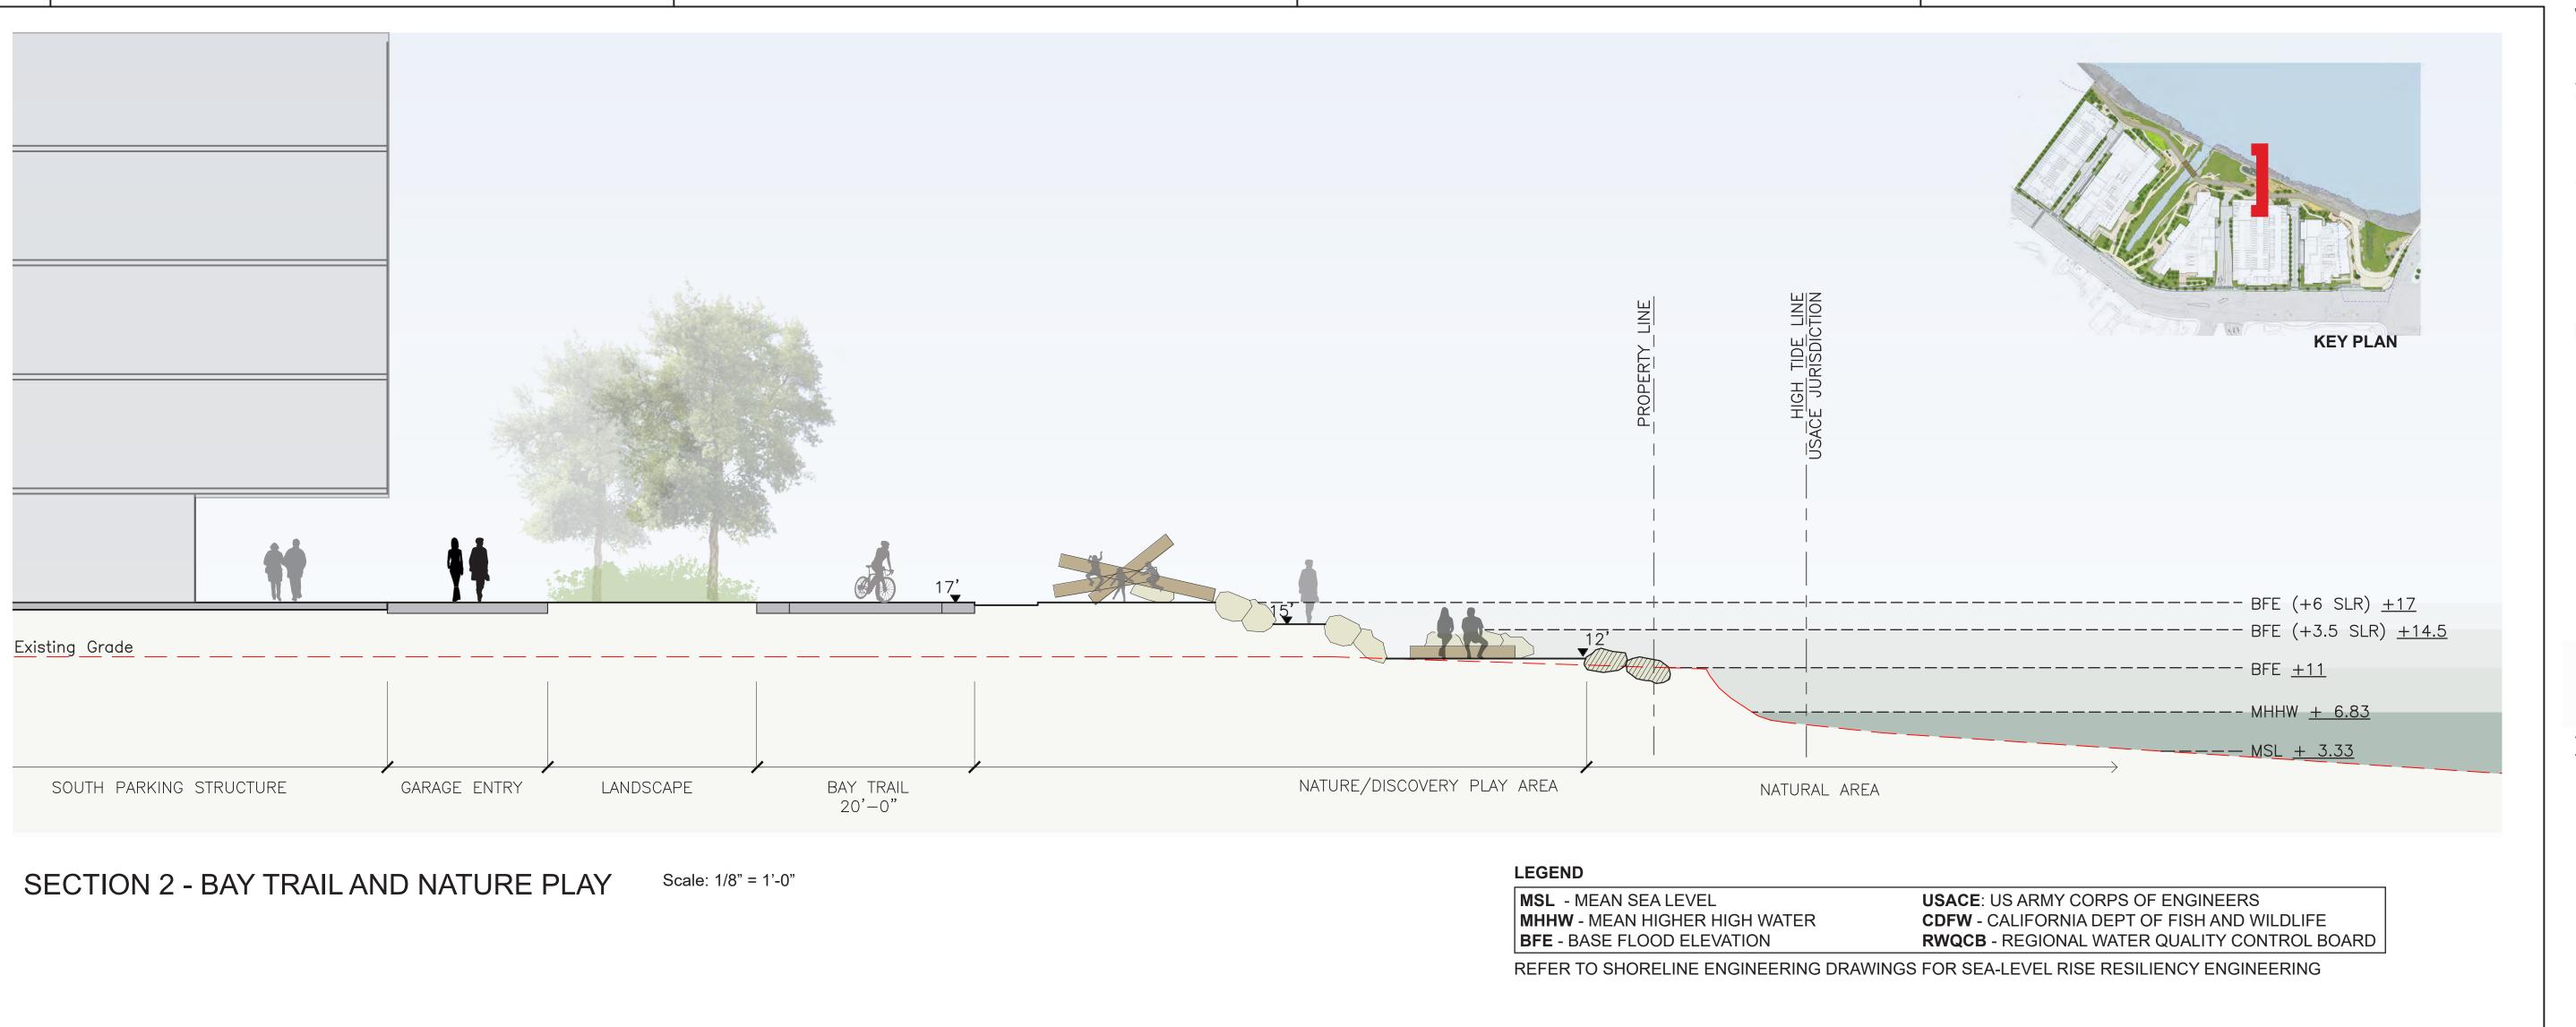



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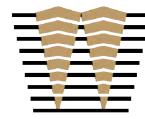
PLANT AND TREE IMAGES

SHEET NO:





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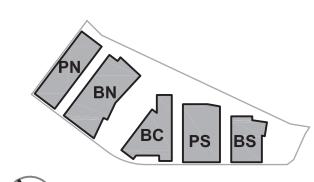

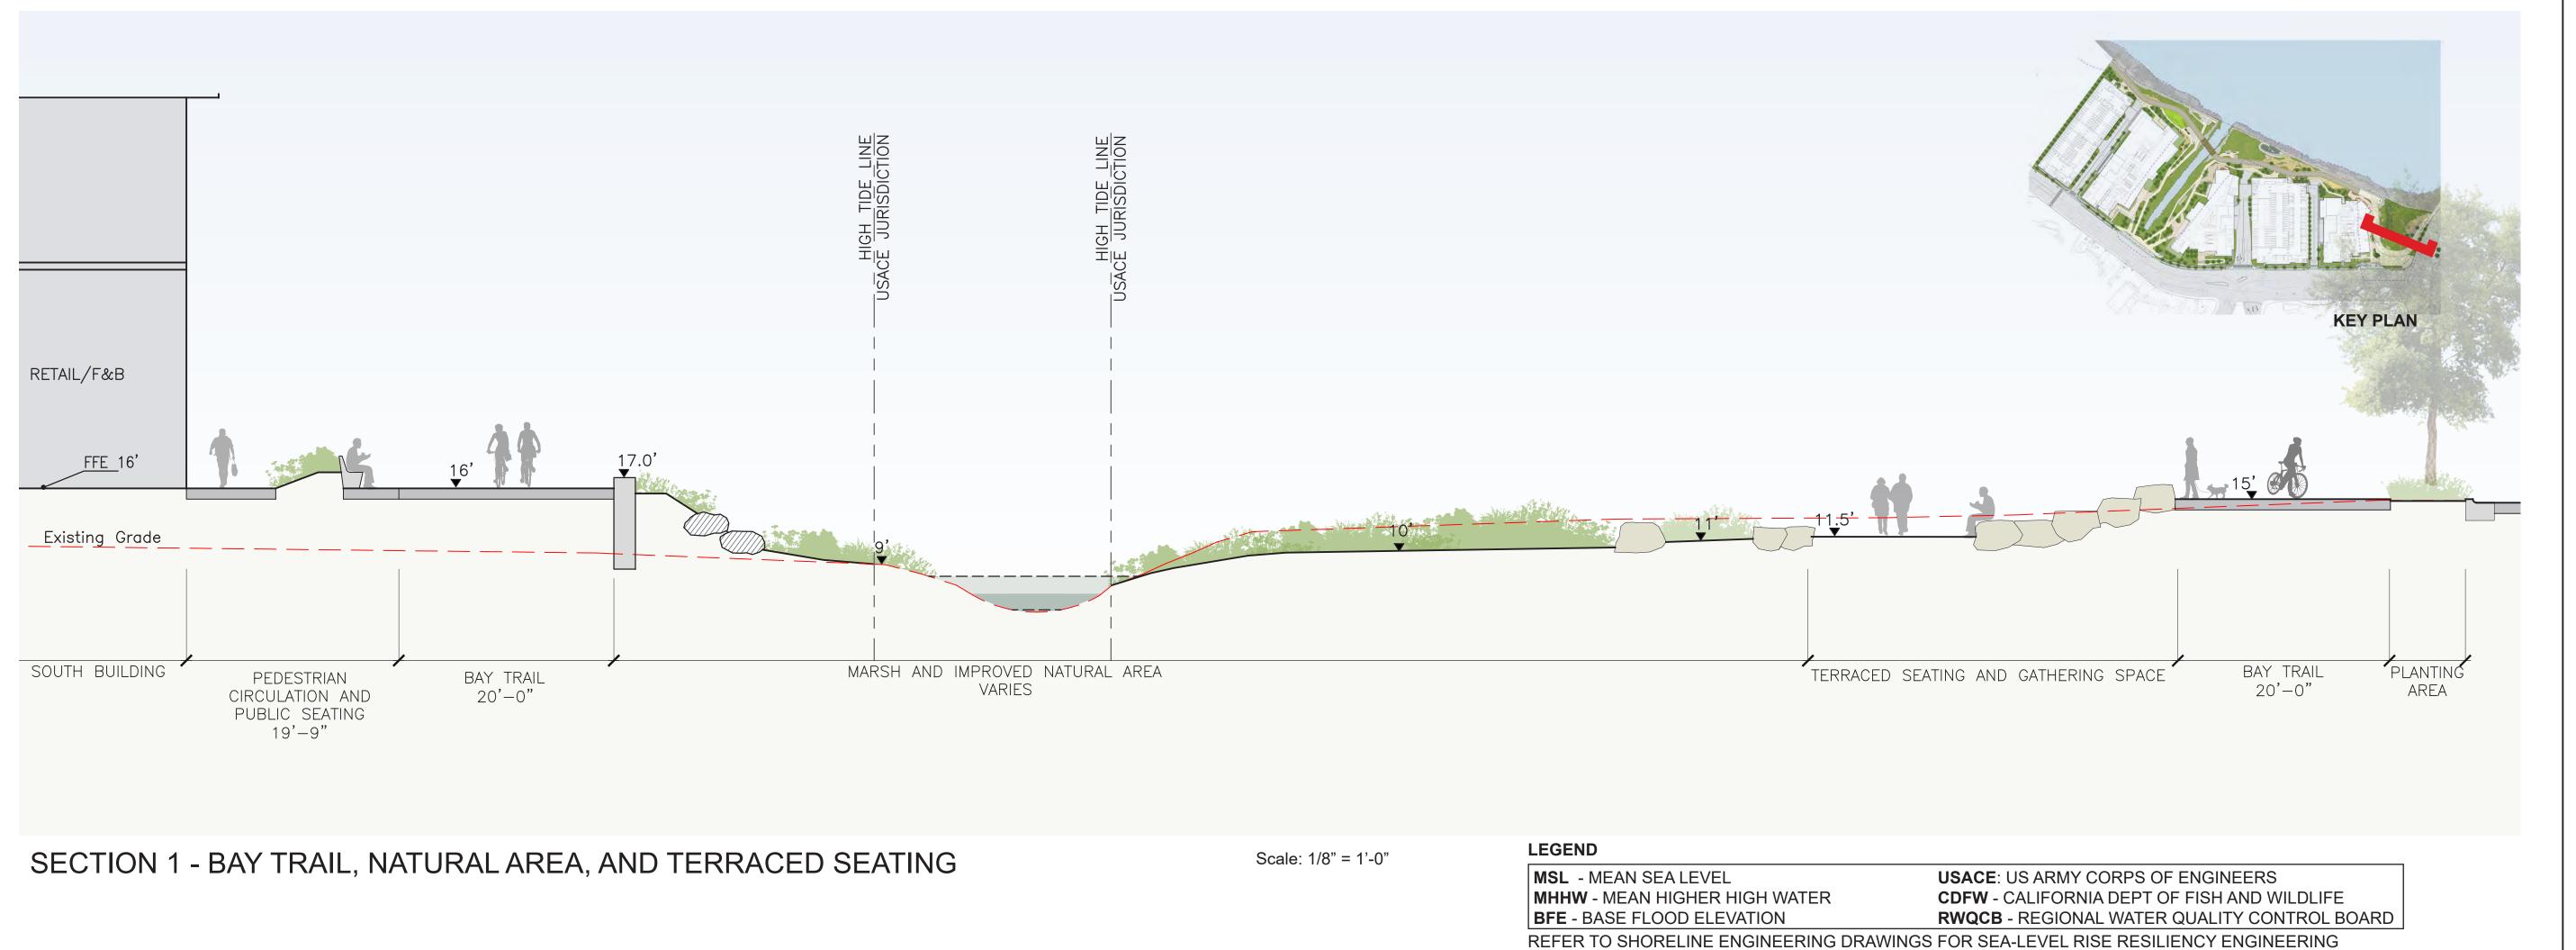
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Peninsula Crossing 1200-1340 Old Bayshore Hwy, Burlingame, CA 94010

KEYPLAN





PROJECT NO.: 20045.00 DATE: 08/19/2022 SCALE: 1/8" = 1'-0"


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SITE SECTIONS


**ENT L-401** 

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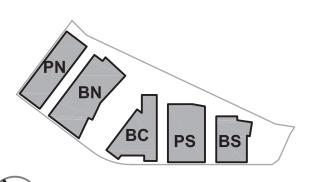


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KEYPLAN



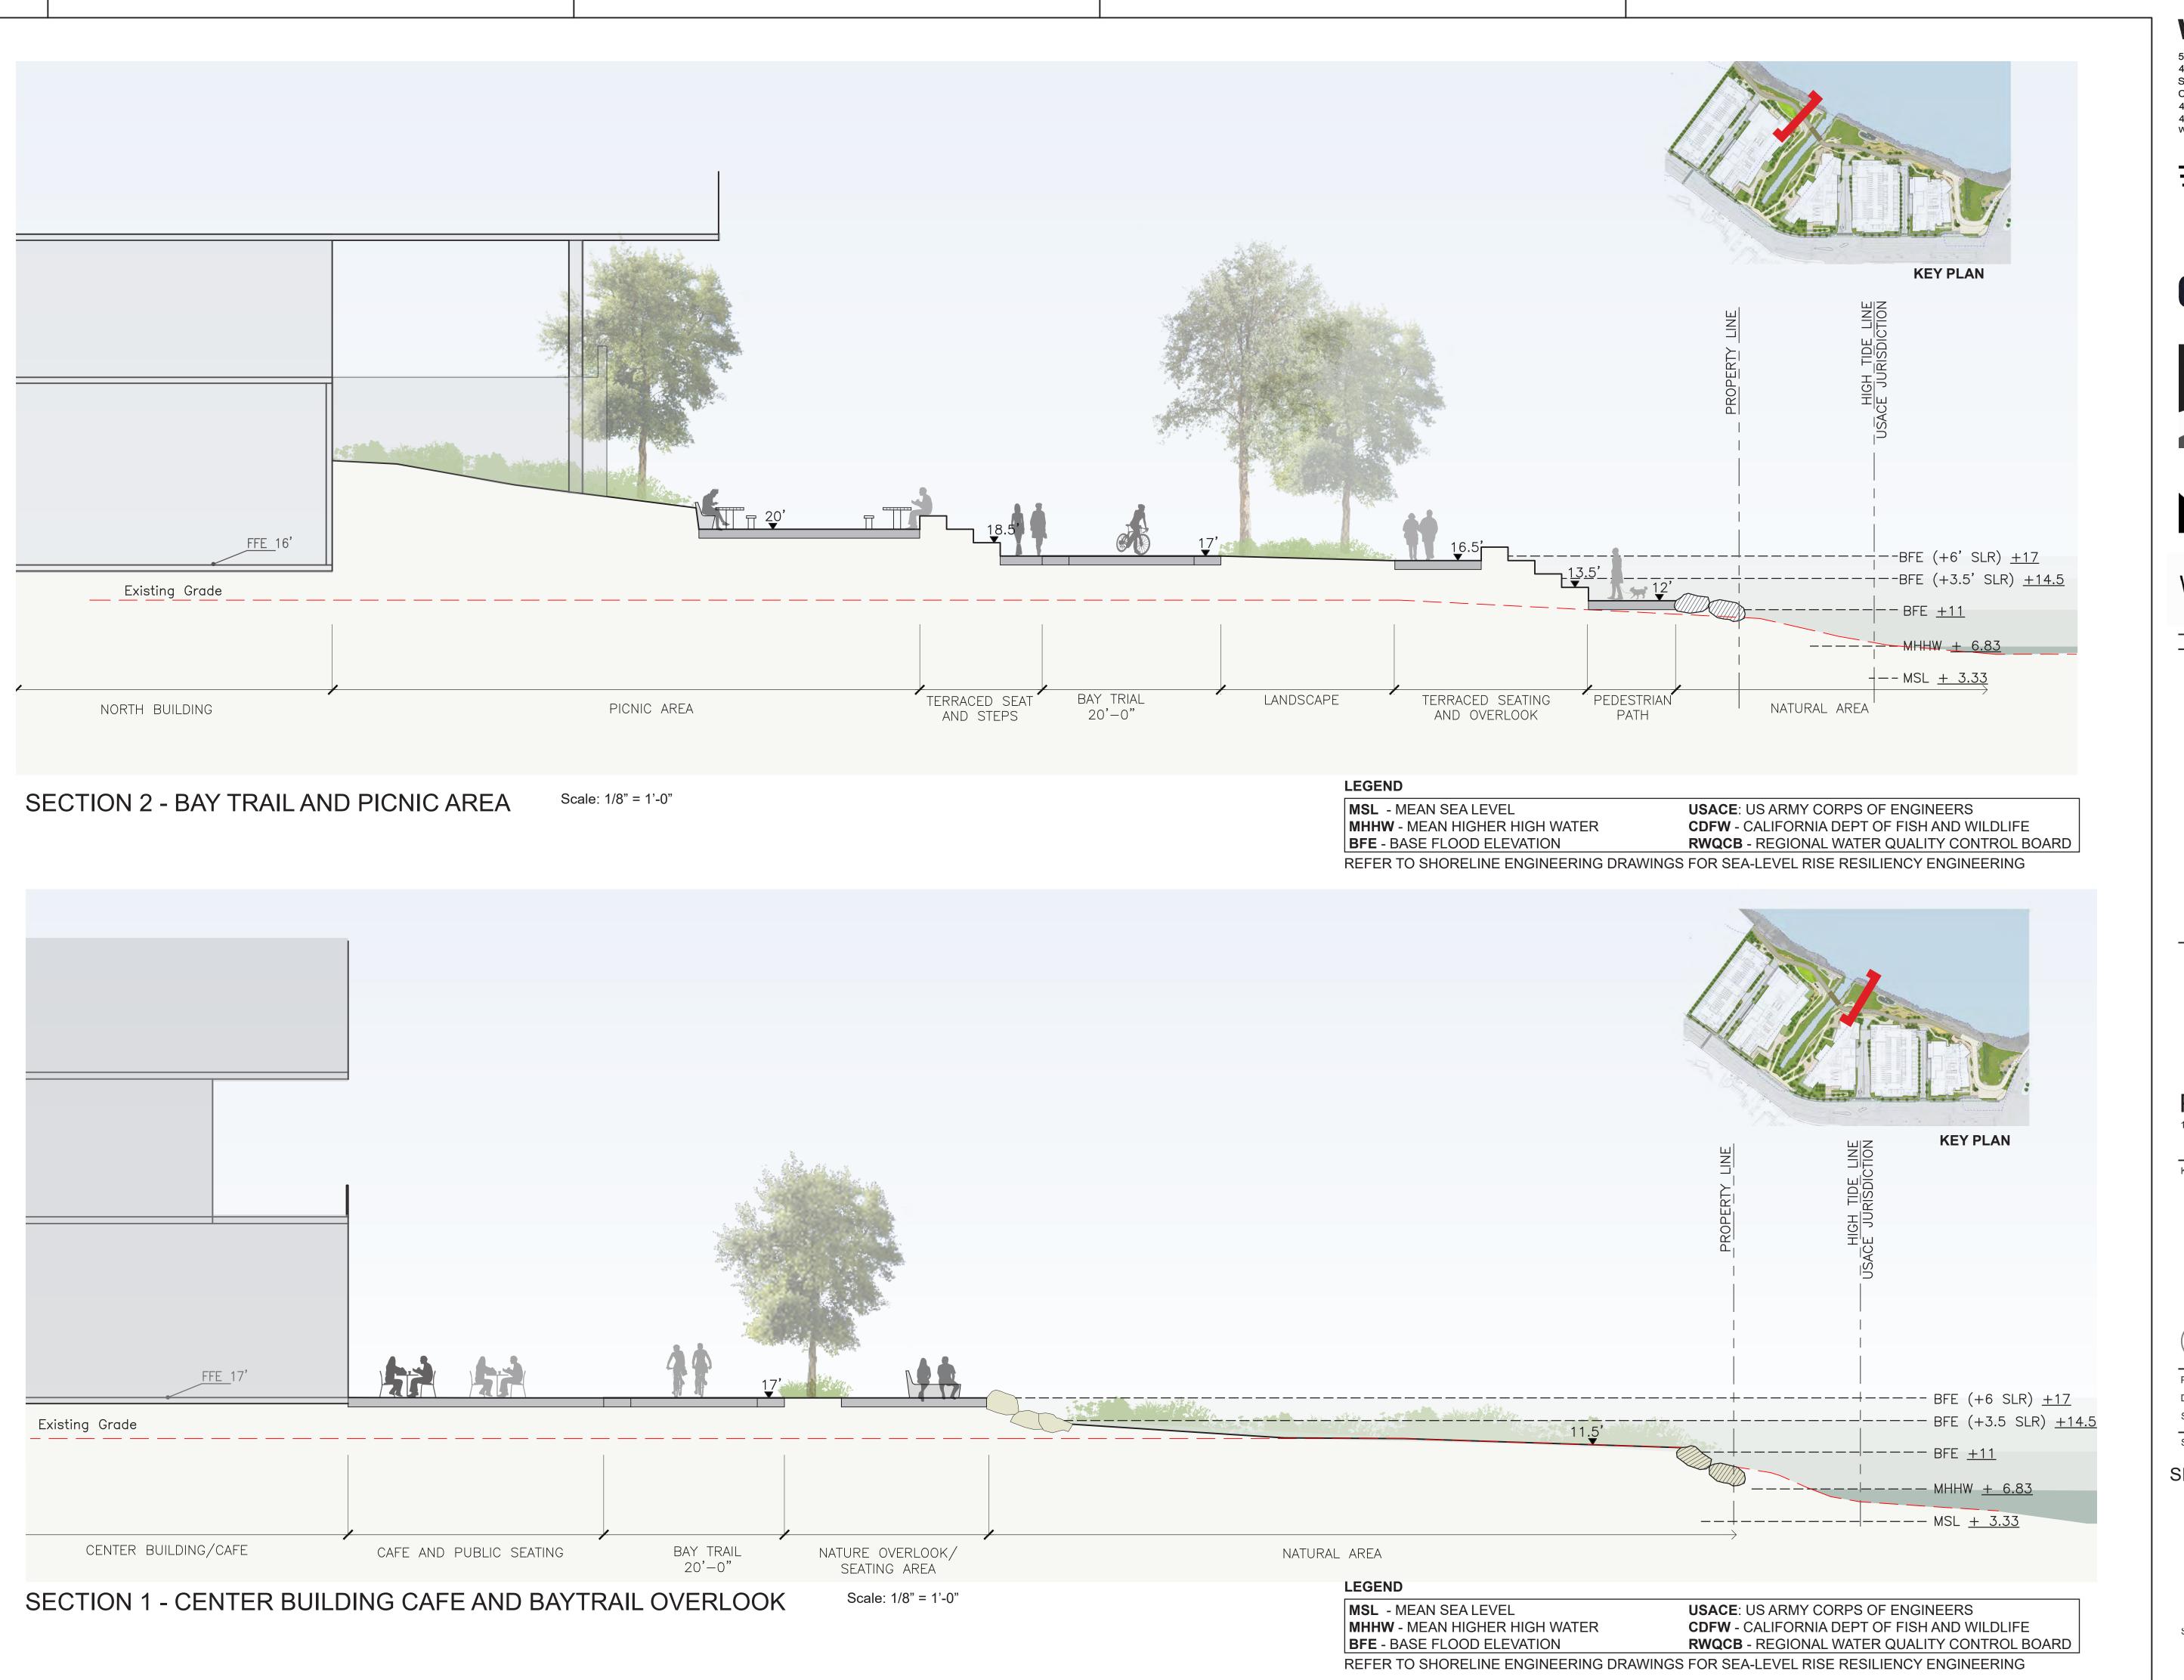

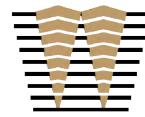PROJECT NO.: 20045.00 DATE: 08/19/2022 SCALE: 1/8" = 1'-0"

SHEET TITLE:


SITE SECTIONS

ENT L-402

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#### **LEGEND**

MSL - MEAN SEA LEVELUSACE: US ARMY CORPS OF ENGINEERSMHHW - MEAN HIGHER HIGH WATERCDFW - CALIFORNIA DEPT OF FISH AND WILDLIFEBFE - BASE FLOOD ELEVATIONRWQCB - REGIONAL WATER QUALITY CONTROL BOARD

Editing State

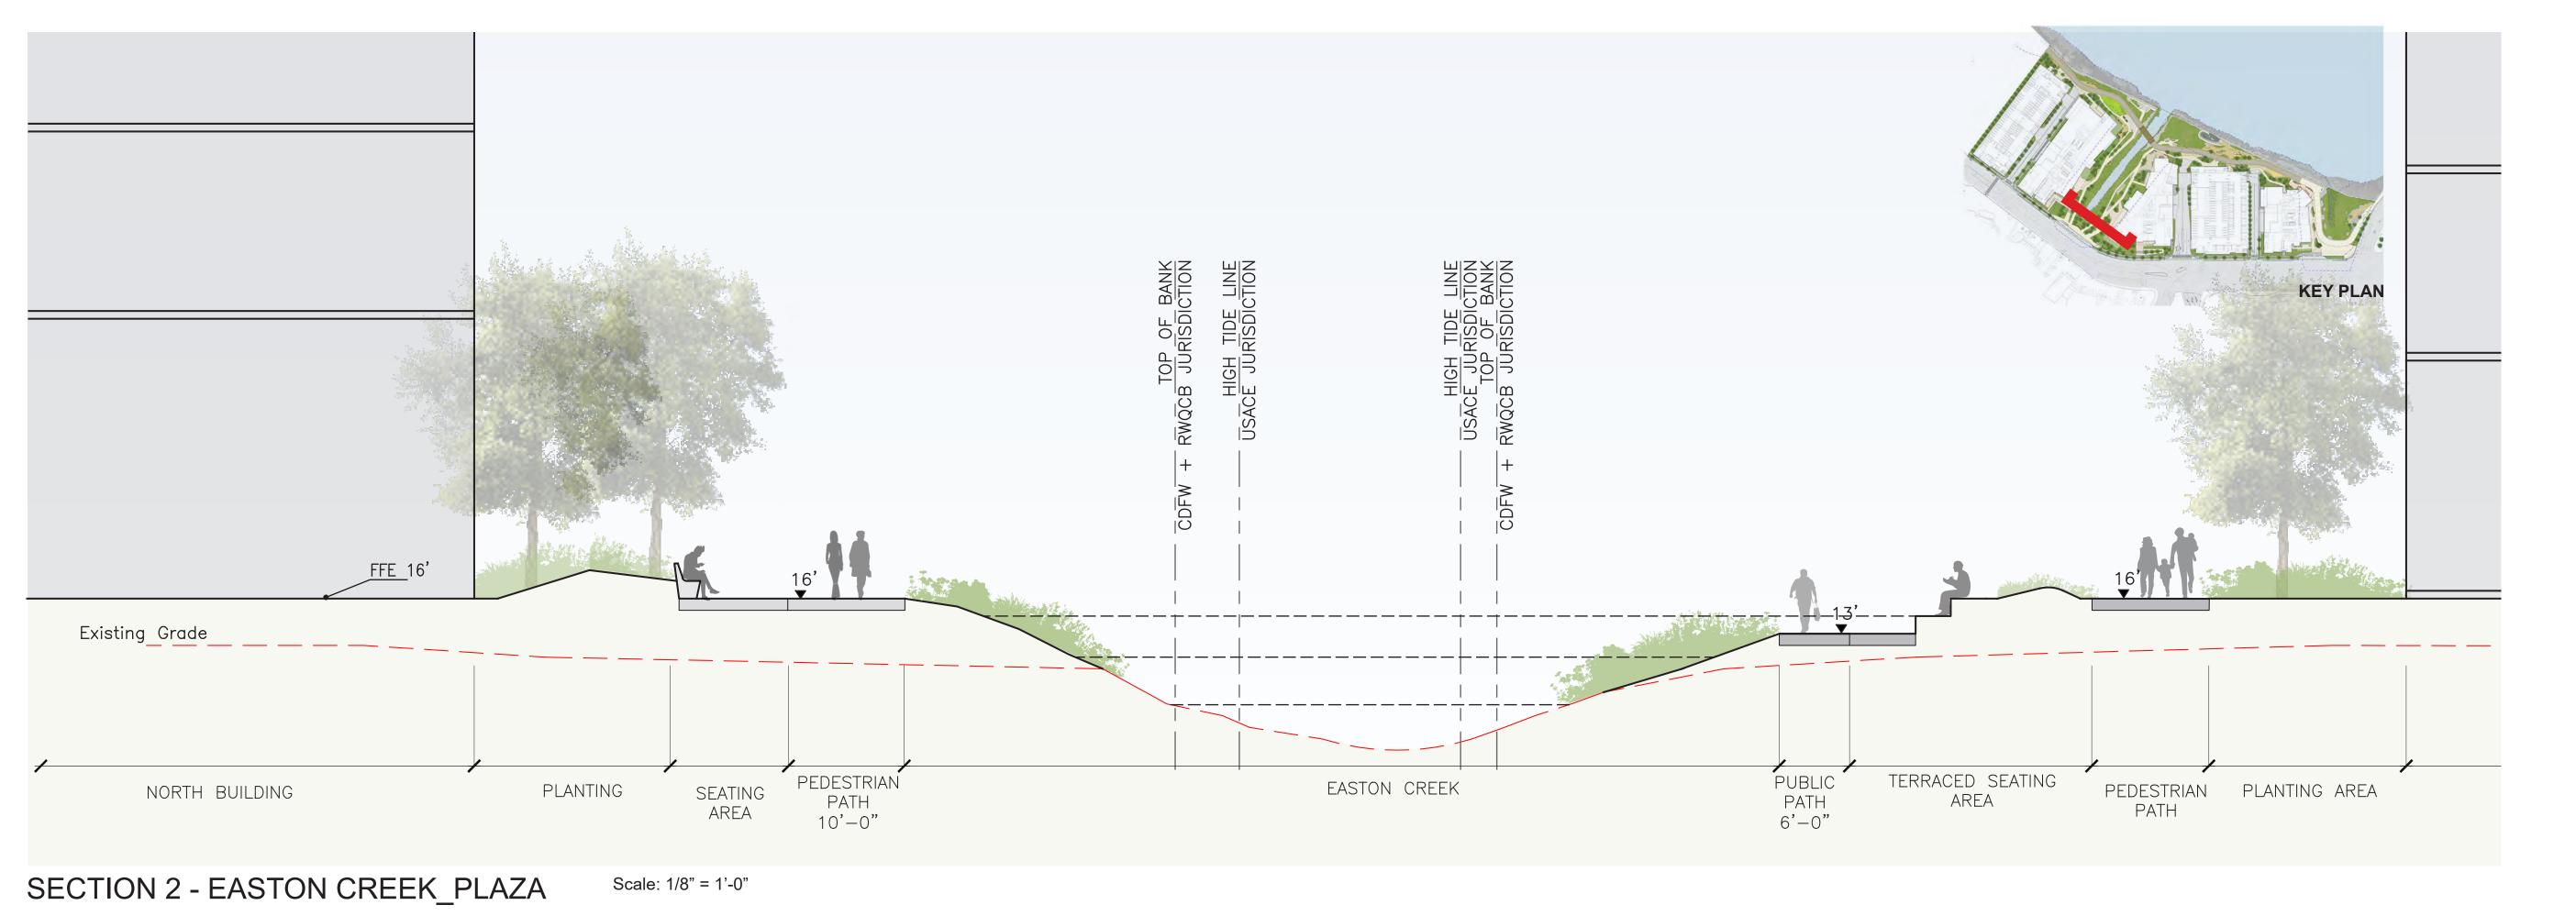NORTH BL LING

ACTUAL TIAN TO SHORE IN SERVICE FLAT TO SHORE BUILDING CONTROL TO DISC.

EAST O CREEK

PIR IC PAIN

FLAT DATE OF THE BUILDING CONTROL TO DISC.

EAST O CREEK

PIR IC PAIN

DUTOUR (AFE AT DEVICE BUILDING CONTROL TO DISC.)

SECTION 1 - EASTON CREEK\_EAST

LEGEND


MSL - MEAN SEA LEVEL
MHHW - MEAN HIGHER HIGH WATER
BFE - BASE FLOOD ELEVATION

USACE: US ARMY CORPS OF ENGINEERS
CDFW - CALIFORNIA DEPT OF FISH AND WILDLIFE
RWQCB - REGIONAL WATER QUALITY CONTROL BOARD

REFER TO SHORELINE ENGINEERING DRAWINGS FOR SEA-LEVEL RISE RESILIENCY ENGINEERING

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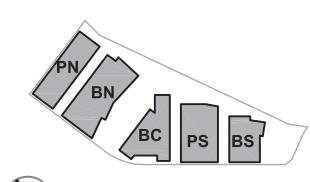
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Peninsula Crossing
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KEYPLAN



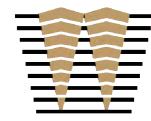

PROJECT NO.: 20045.00 DATE: 08/19/2022 SCALE: 1/8" = 1'-0"


SHEET TITLE:

SITE SECTIONS

ENT L-403

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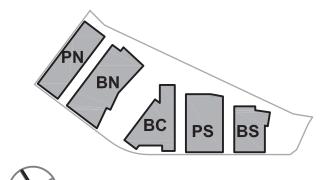


LANDSCAPED SLOPE

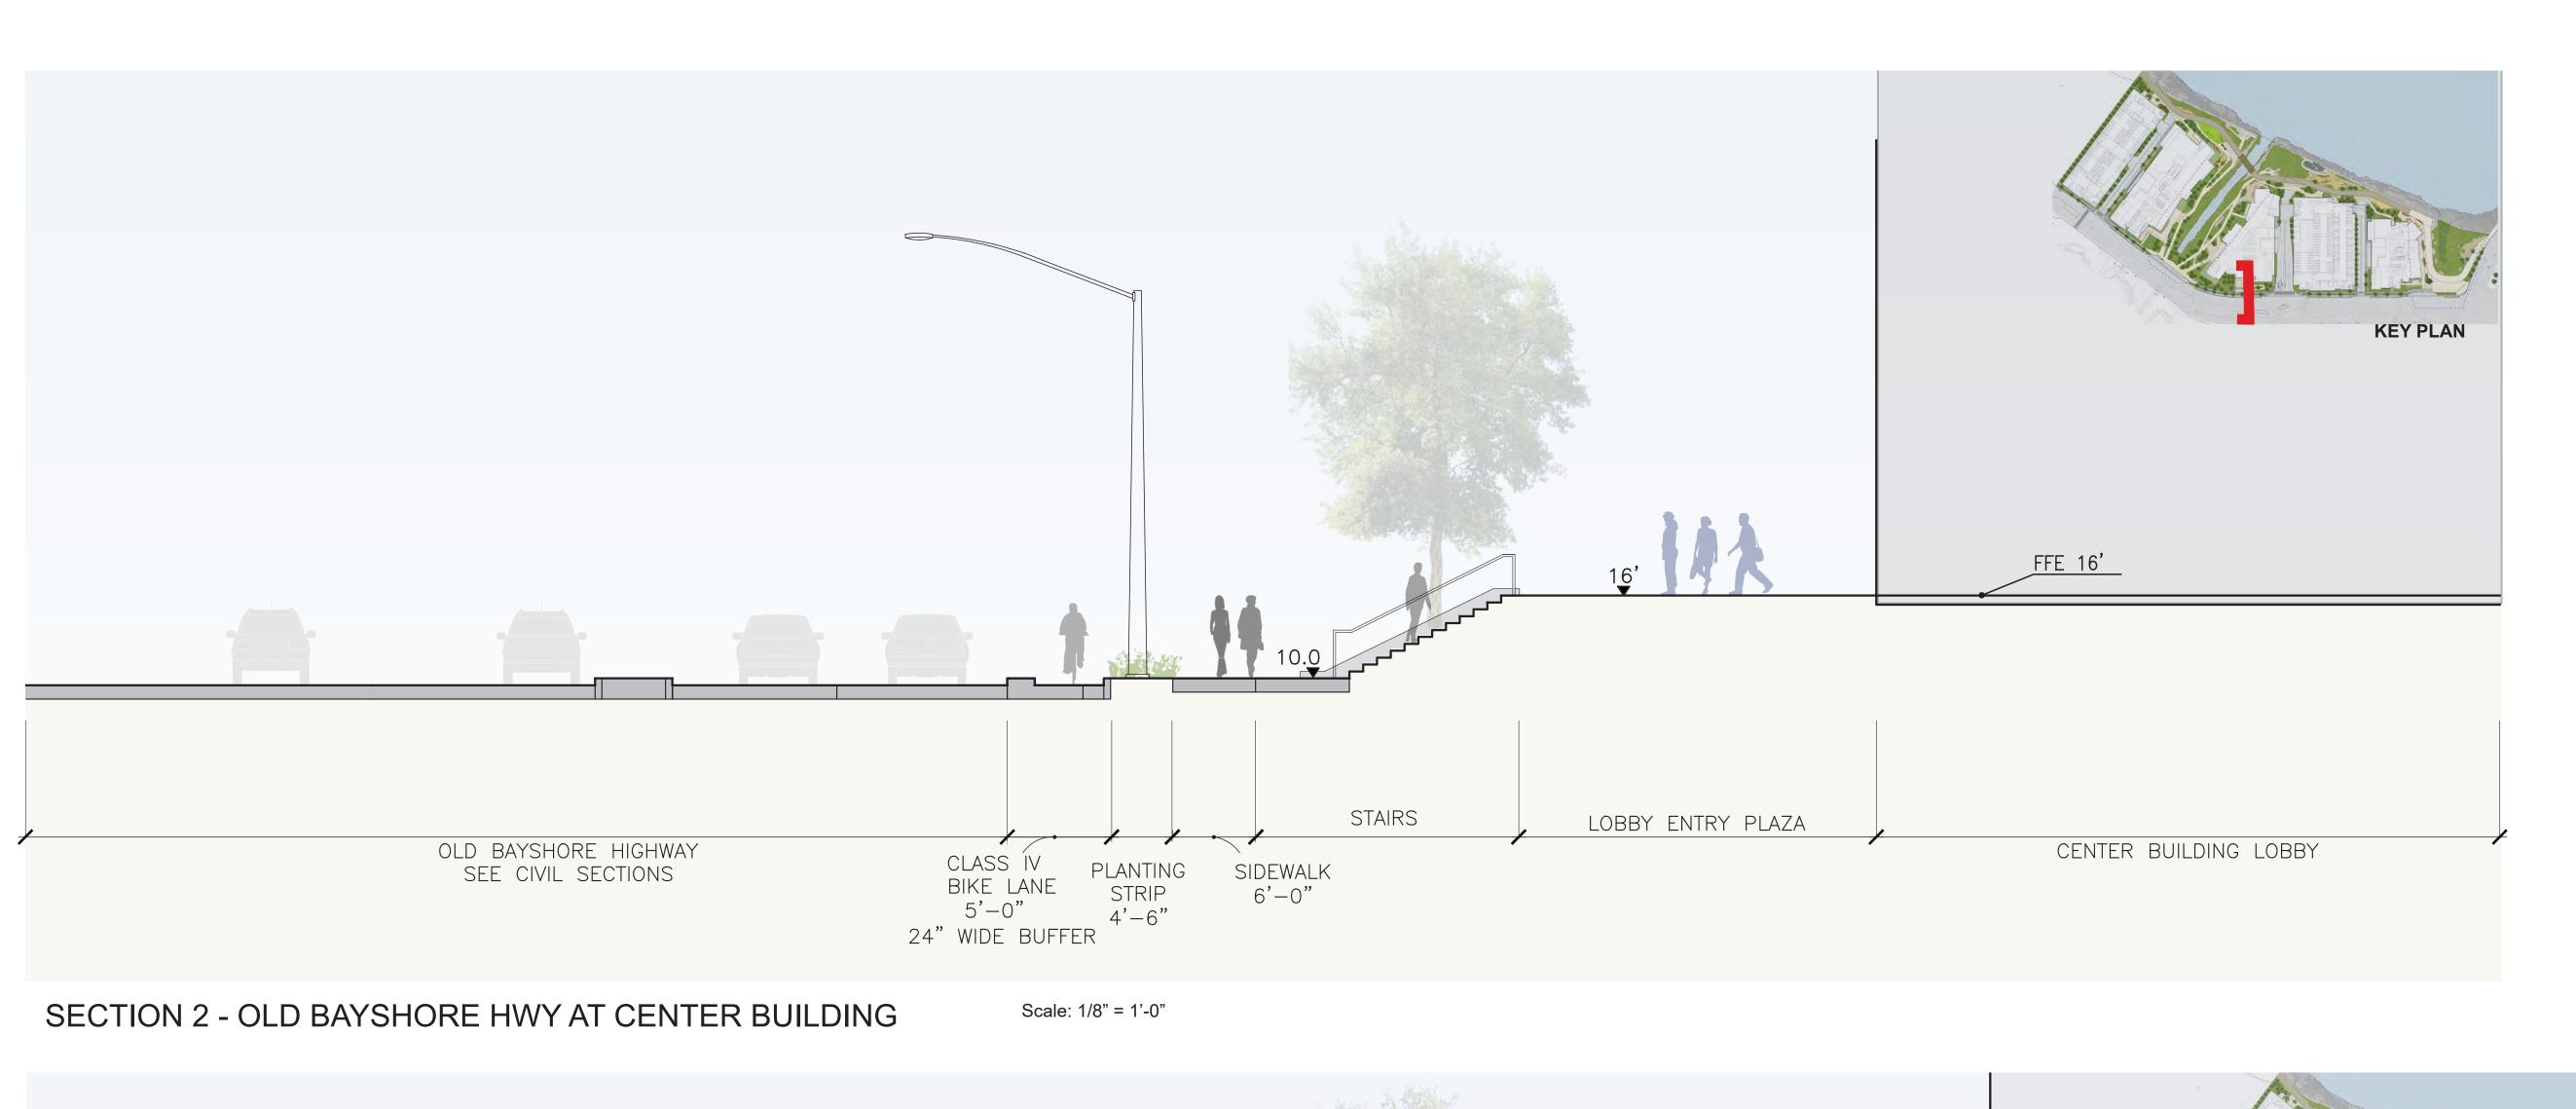**KEY PLAN** 

NORTH BUILDING LOBBY

KEYPLAN



Peninsula Crossing

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ENTITLEMENT APPLICATION

ENTITLEMENT APPLICATION #2

ENTITLEMENT APPLICATION #3

ISSUES



PROJECT NO.: 20045.00 DATE: 08/19/2022 SCALE: 1/8" = 1'-0"

SHEET TITLE:

SITE SECTIONS

**ENT L-404** 

Scale: 1/8" = 1'-0"

PLANTING SIDEWALK

STRIP

4'-6"

OLD BAYSHORE HIGHWAY

SEE CIVIL SECTIONS

SECTION 1 - OLD BAYSHORE HWY AT NORTH BUILDING

CLASS IV BIKE LANE 5'-0"

24" WIDE BUFFER

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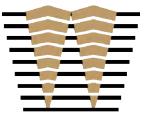
ACCESSIBLE RAMP

LOBBY ENTRY PLAZA

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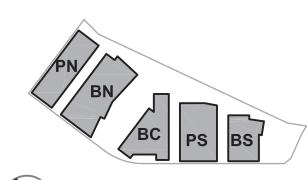


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KEYPLAN





PROJECT NO.: 20045.00 DATE: 08/19/2022 SCALE: 1"=50'


SHEET TITLE:

**CONCEPTUAL ART** PROGRAM PLAN





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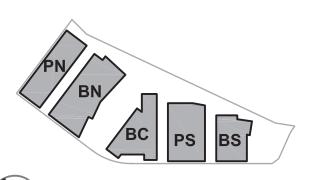
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KEYPLAN

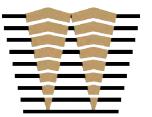




PROJECT NO.: 20045.00 DATE: 08/19/2022

SCALE: 1"=50'
SHEET TITLE:

CONCEPTUAL SIGNAGE PLAN

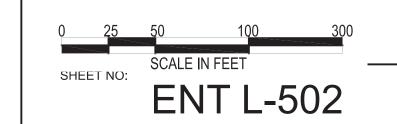

#### **CIVIL NOTES:**

TIDAL PLANE	NAVD88 DATUM (FEET)
KING TIDE	+8.41
MEAN HIGHER HIGH WATER (MHHW)	+6.83
MEAN HIGH WATER (MHW)	+6.21
MEAN SEA LEVEL (MSL)	+3.33
MEAN LOW WATER (MLW)	+0.40
NORTH AMERICAN VERTICAL DATUM OF 1988 (NAVD88)	0.00
MEAN LOWER LOW WATER (MLLW)	-0.79
FEMA ONE PERCENT ANNUAL CHANCE FLOOD ELEVATIONS	NAVD88 DATUM (FEET)
BASE FLOOD ELEVATION (SAN FRANCISCO BAY)	+11.0
BASE FLOOD ELEVATION (EASTON CREEK)	+10.0

+10.3


#### STRUCTURAL NOTES:


STILLWATER ELEVATION (SWEL)


#### 1. DESIGN LOADING:

- a. SEISMIC DESIGN: CALTRANS SEISMIC DESIGN CRITERIA (SDC), VERSION 2.0, DATED APRIL 2019.
- b. DEADLOAD: 150 pcf FOR REINFORCED CONCRETE 490 pfc FOR STEEL.
- c. LIVELOAD: HL-93 WITH "LOWBAY" AND P-15 DESIGN VEHICLE COMBINED WITH 90 psf PEDESTRIAN LOADING.
- d. EARTH LOADS: AT-REST PRESSURE = 60pcf
  STATIC ACTIVE PRESSURE = 35 pcf
  SEISMIC ACTIVE INCREMENT PRESSURE = 25 pcf

#### CROSS-REFERENCE LEGEND

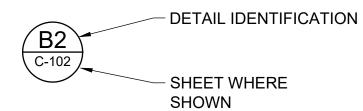

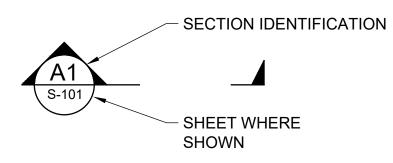

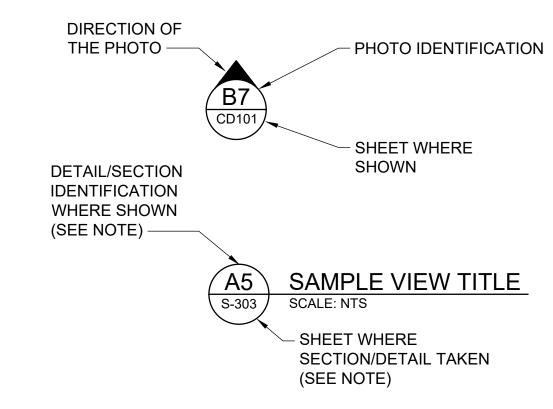

#### **ABBREVIATIONS**:

AASHTO	AMERICAN ASSOCIATION OF STATE HIGHWAY AND TRANSPORTATION OFFICIALS

ABUT ABUTMENT

ACBM ARTICULATED CONCRETE BLOCK MAT

APPROX APPROXIMATELY

BB BEGIN BRIDGE

BCDC BAY CONSERVATION AND DEVELOPMENT COMMISSION

BFE BASE FLOOD ELEVATION

BIV BOX-IV

CA CALIFORNIA

CIP CAST-IN-PLACE

CLSM CONTROLLED LOW STRENGTH MATERIAL

CONC CONCRETE

(E) EXISTING

EB END BRIDGE

ELEV ELEVATION

FEMA FEDERAL EMERGENCY MANAGEMENT AGENCY

FFE FINISH FLOOR ELEVATION

HTL HIGH TIDE LINE

L.O.W LIMIT OF WORK

MHHW MEAN HIGHER HIGH WATER

MHW MEAN HIGH WATER

MIN. MINIMUM

MSL MEAN SEA LEVEL

NAVD88 NORTH AMERICAN VERTICAL DATUM OF 1988

PC PRECAST

PCF POUNDS PER CUBIC FEET

PS PRESTRESSED

PSF POUNDS PER SQUARE FEET

RSP ROCK SLOPE PROTECTION

SD STORM DRAIN

SS SHORELINE STRUCTURE(S)

ST STANDARD

TYP TYPICAL

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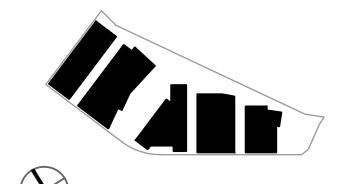



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### WATT

ISSUES	DATE
ENTITLEMENT APPLICATION	03/24/2022
ENTITLEMENT APPLICATION #2	08/19/2022
ENTITLEMENT APPLICATION #3	12/09/2022

KEYPLAN



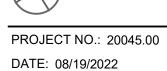

SCALE: NTS
SHEET TITLE:


NOTES, LEGEND, AND ABBREVIATIONS

SHEET NO:

**ENT SS-001** 

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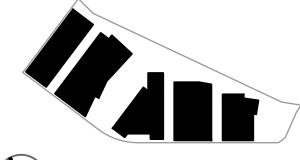




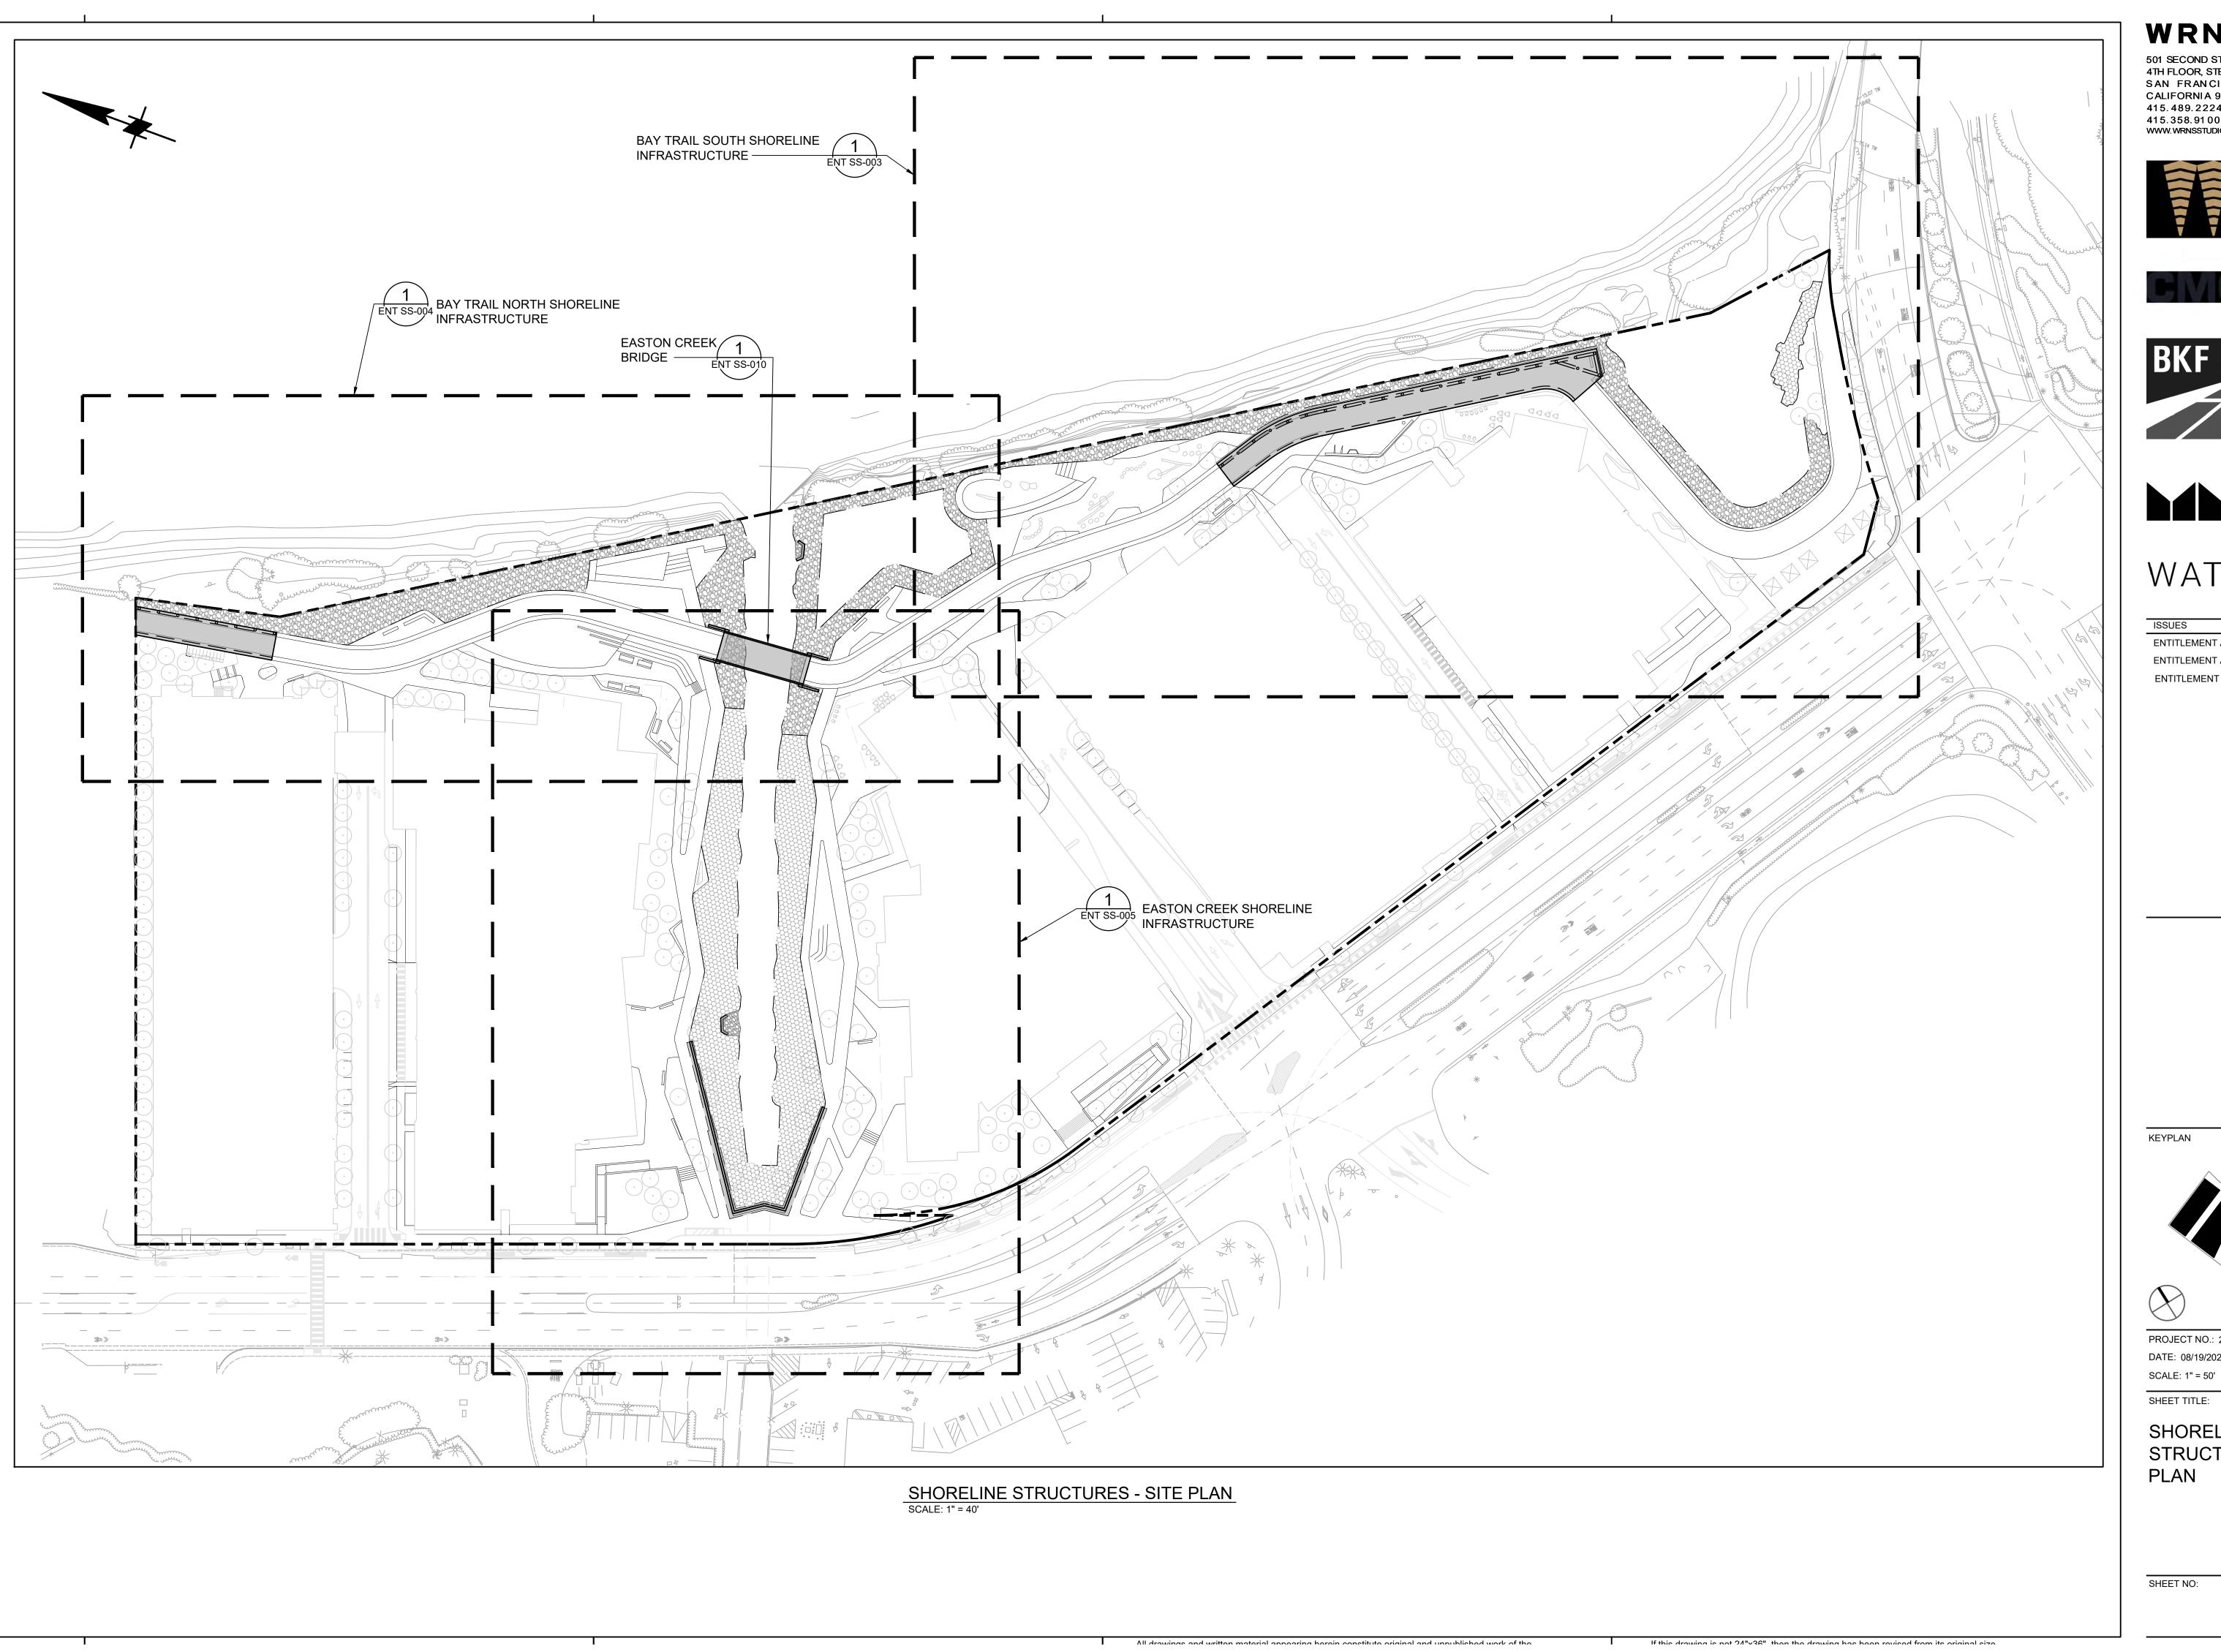


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PROJECT NO.: 20045.00 DATE: 08/19/2022

SHORELINE STRUCTURES - SITE



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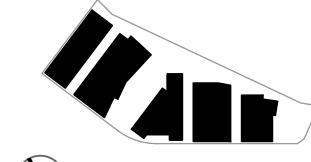


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ISSUES	DATE
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ENTITLEMENT APPLICATION #3	12/09/2022

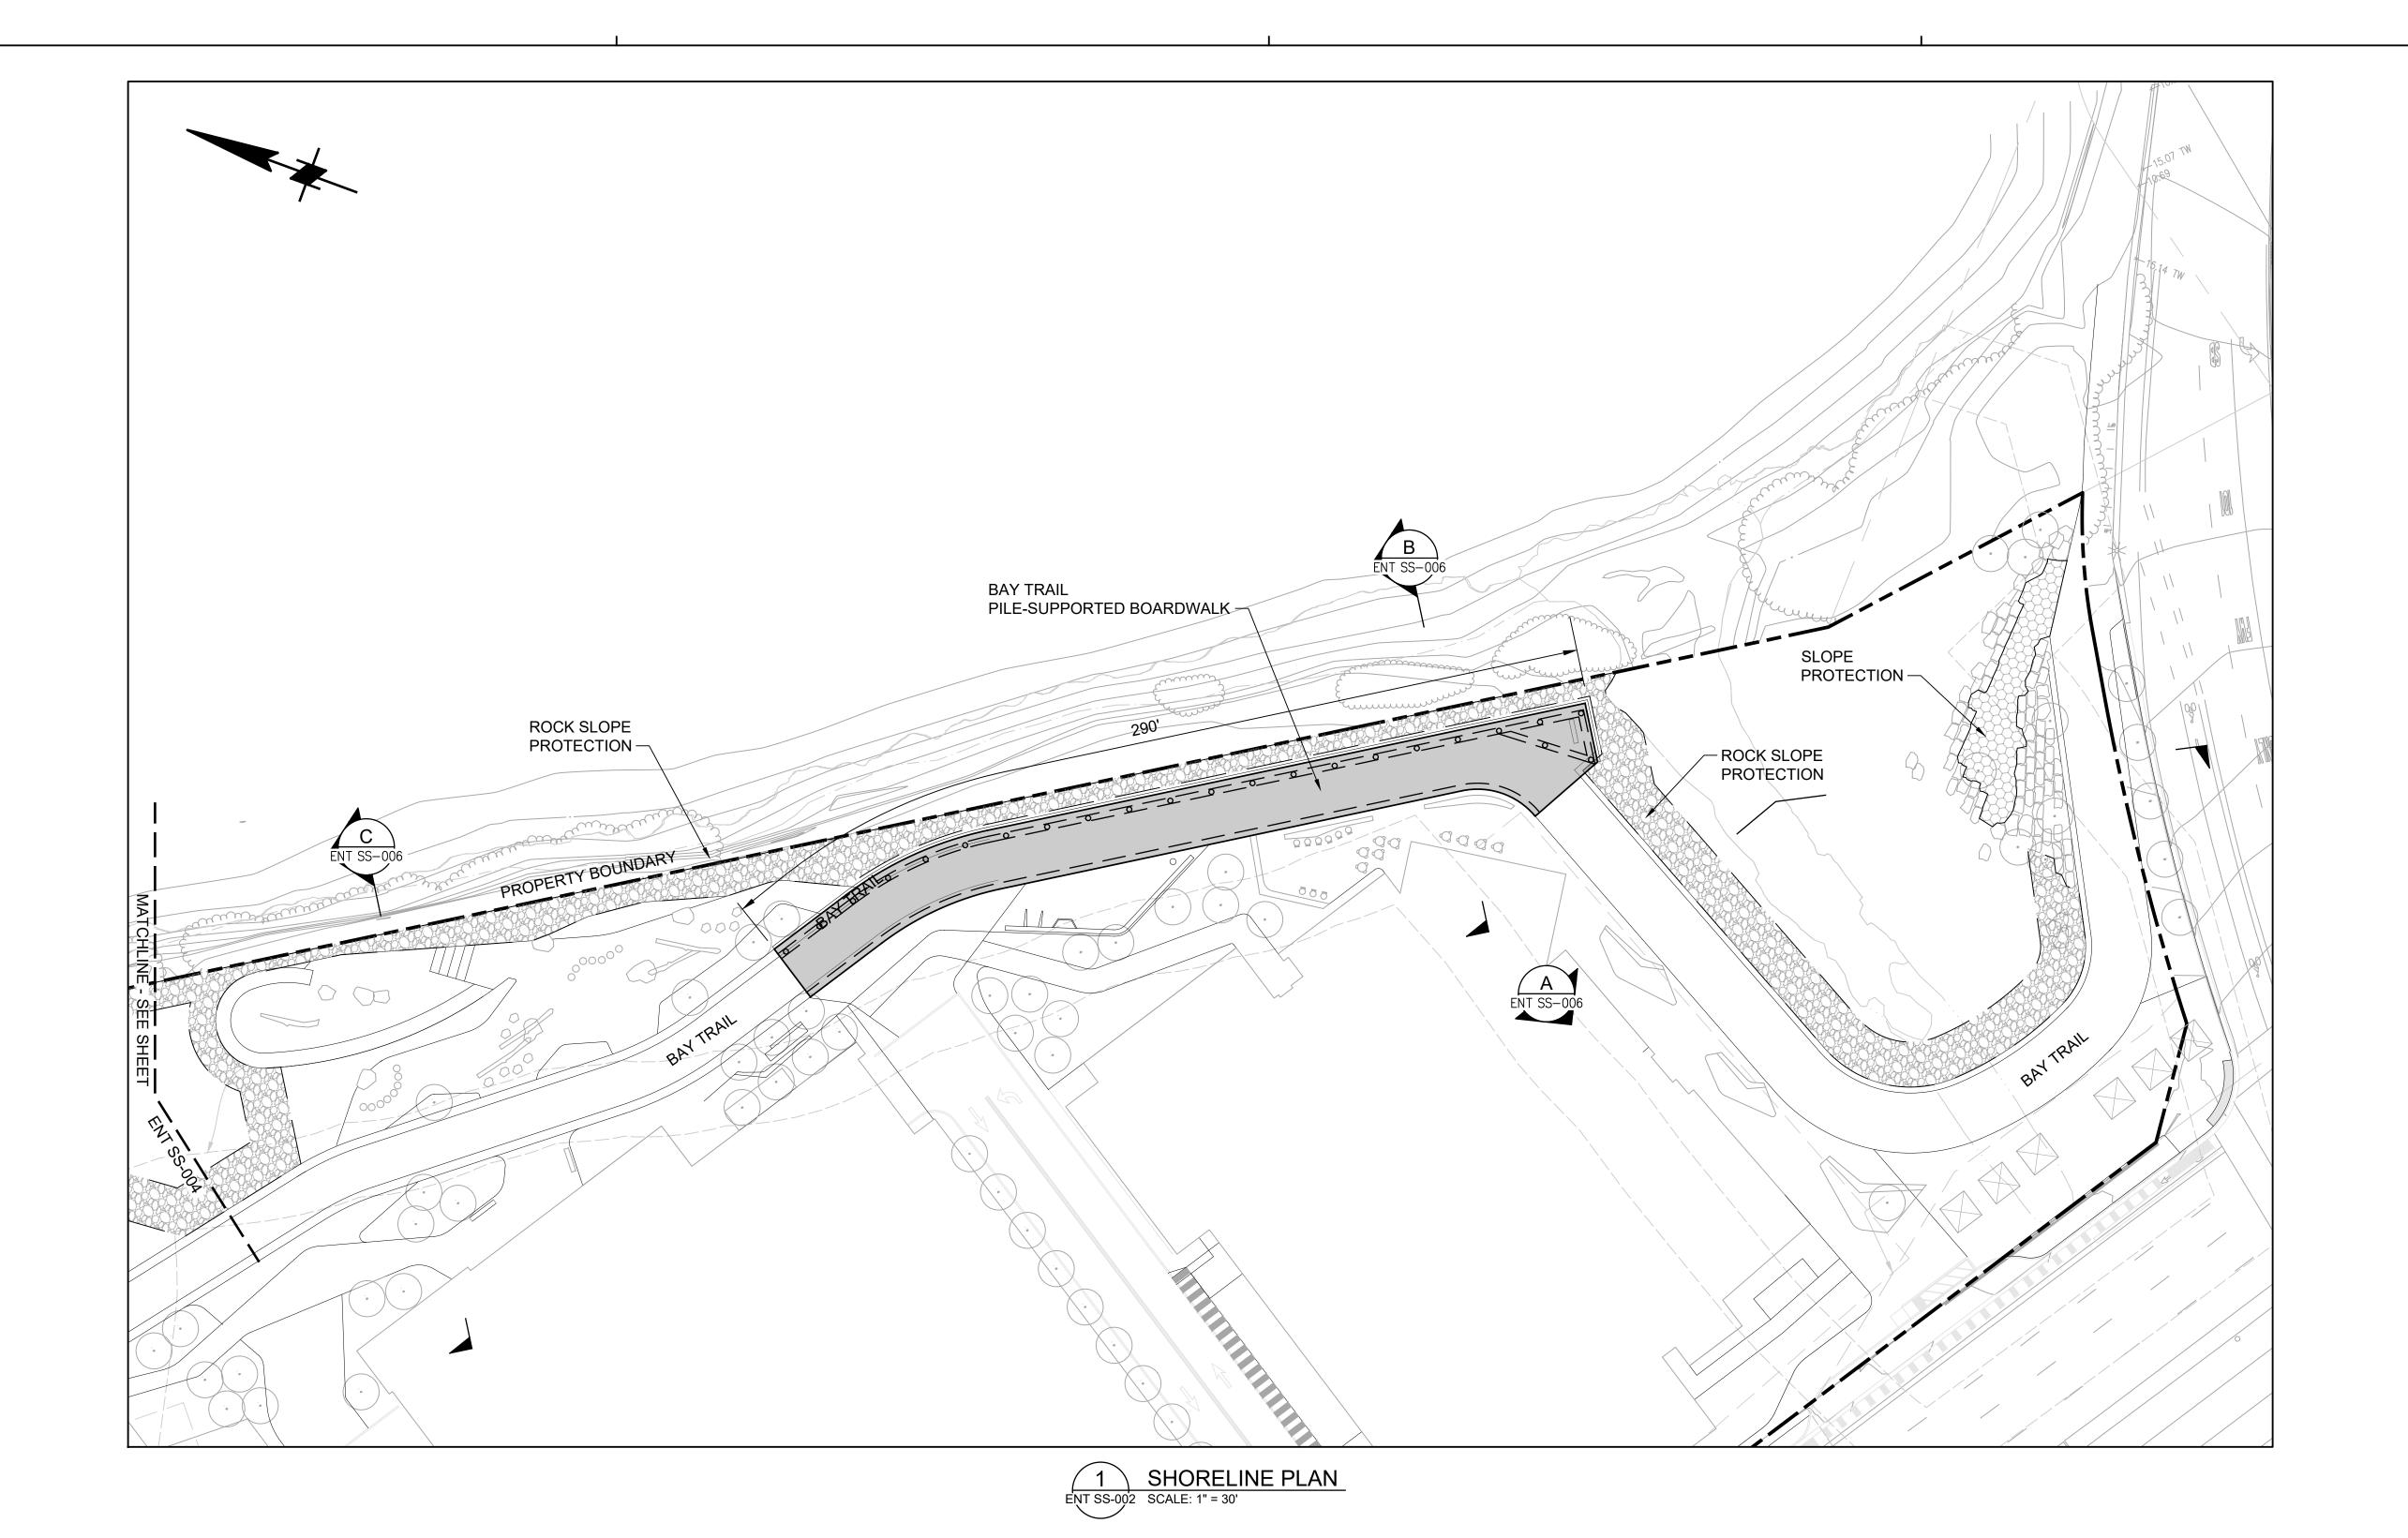KEYPLAN






PROJECT NO.: 20045.00 DATE: 08/19/2022 SCALE: 1:30

SHEET TITLE:

SHORELINE STRUCTURES PLAN - SOUTH

SHEET

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SHORELINE PLAN
ENT SS-002 SCALE: 1" = 30'
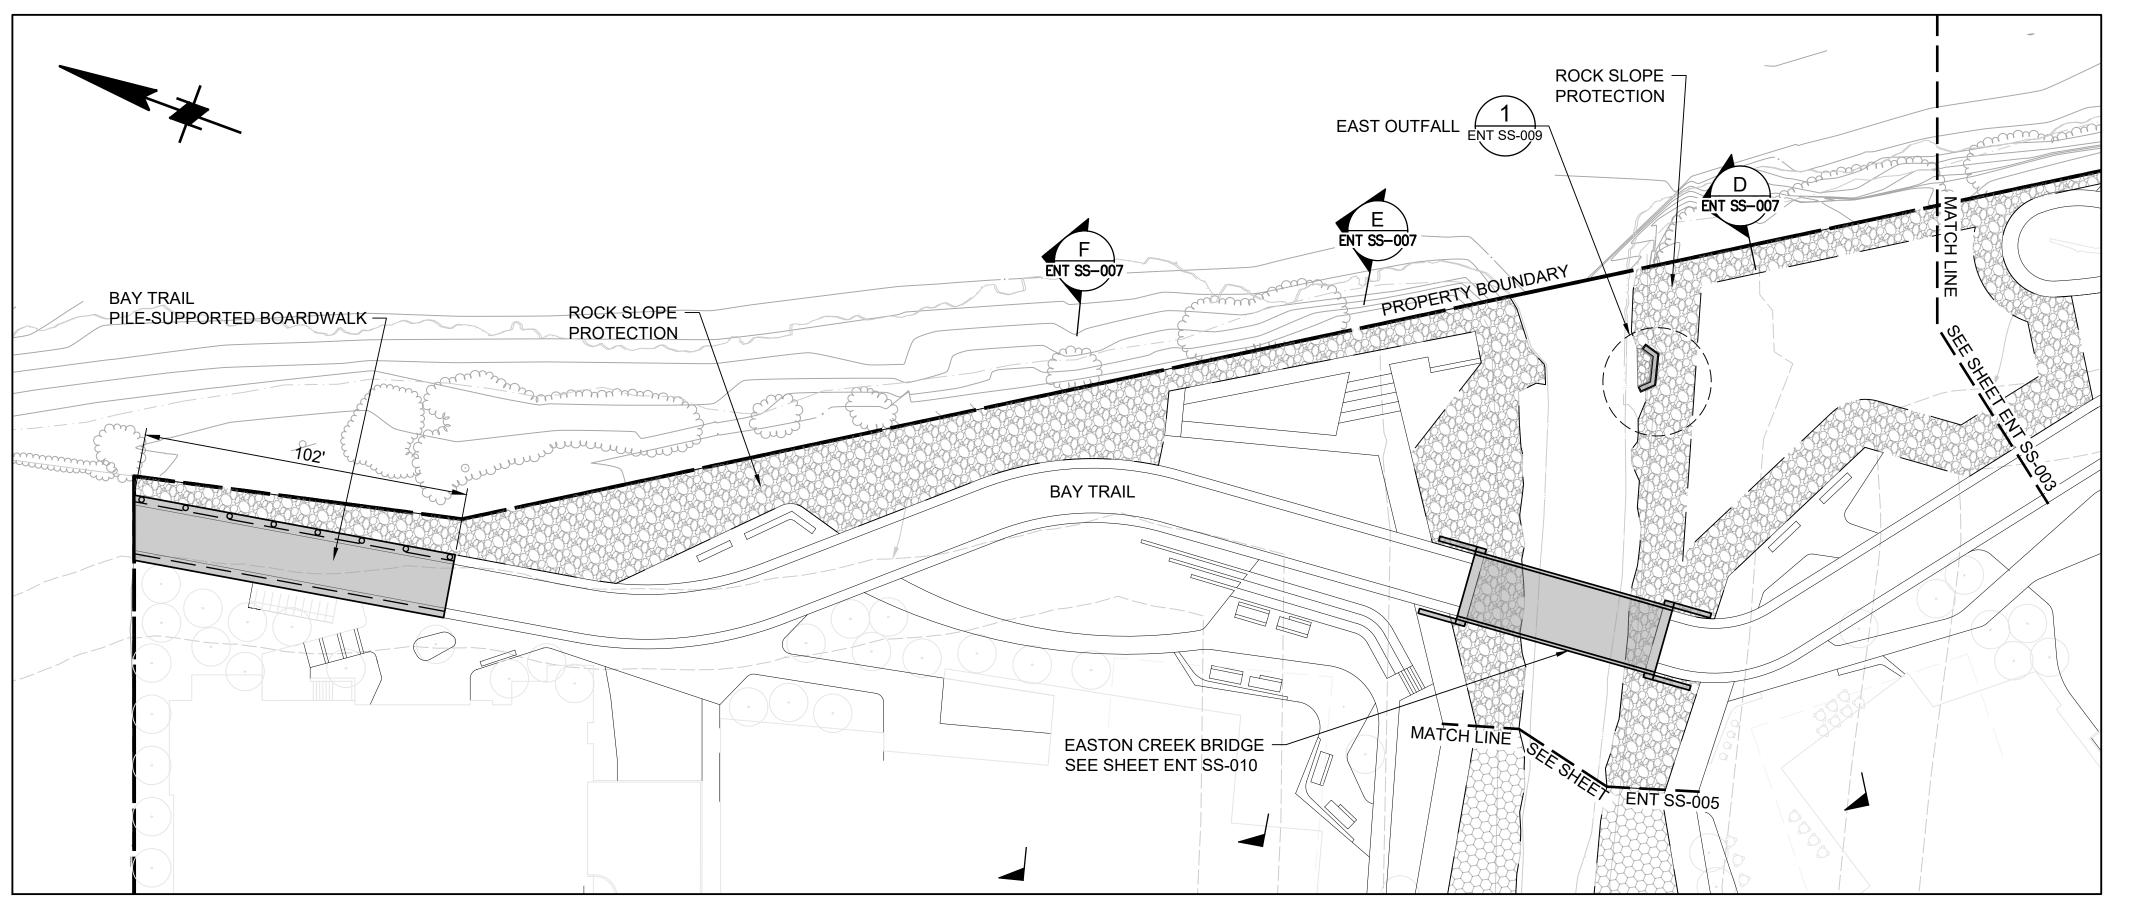
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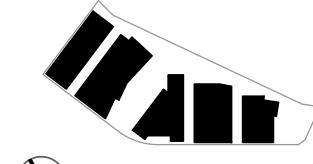




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ENTITLEMENT APPLICATION #3	12/09/2022

KEYPLAN





PROJECT NO.: 20045.00 DATE: 08/19/2022 SCALE: 1:30

SHEET TITLE:

SHORELINE STRUCTURES PLAN -NORTH

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# SEE SHEET ENT SS-010 BAY TRAIL NORTH SHORELINE — INFRASTRUCTURE SEE SHEET ENT SS-004 MATCHLINE SLOPE PROTECTION SLOPE PROTECTION WEST OUTFALL $\left(\frac{2}{\text{ENT}}\right)$ – (E) CONCRETE RETAINING WALL EASTON CREEK SHORELINE RETAINING WALL EASTON CREEK SHORELINE RETAINING WALL - (E) CULVERT SHORELINE PLAN ENT SS-002 SCALE: 1" = 30'

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EASTON CREEK BRIDGE -

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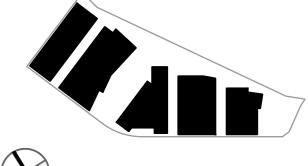


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KEYPLAN






PROJECT NO.: 20045.00 DATE: 08/19/2022 SCALE: 1:30

SHEET TITLE:

SHORELINE STRUCTURES PLAN -EASTON CREEK

SHEET NO

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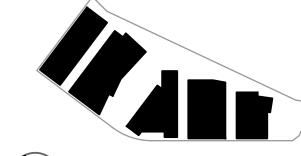


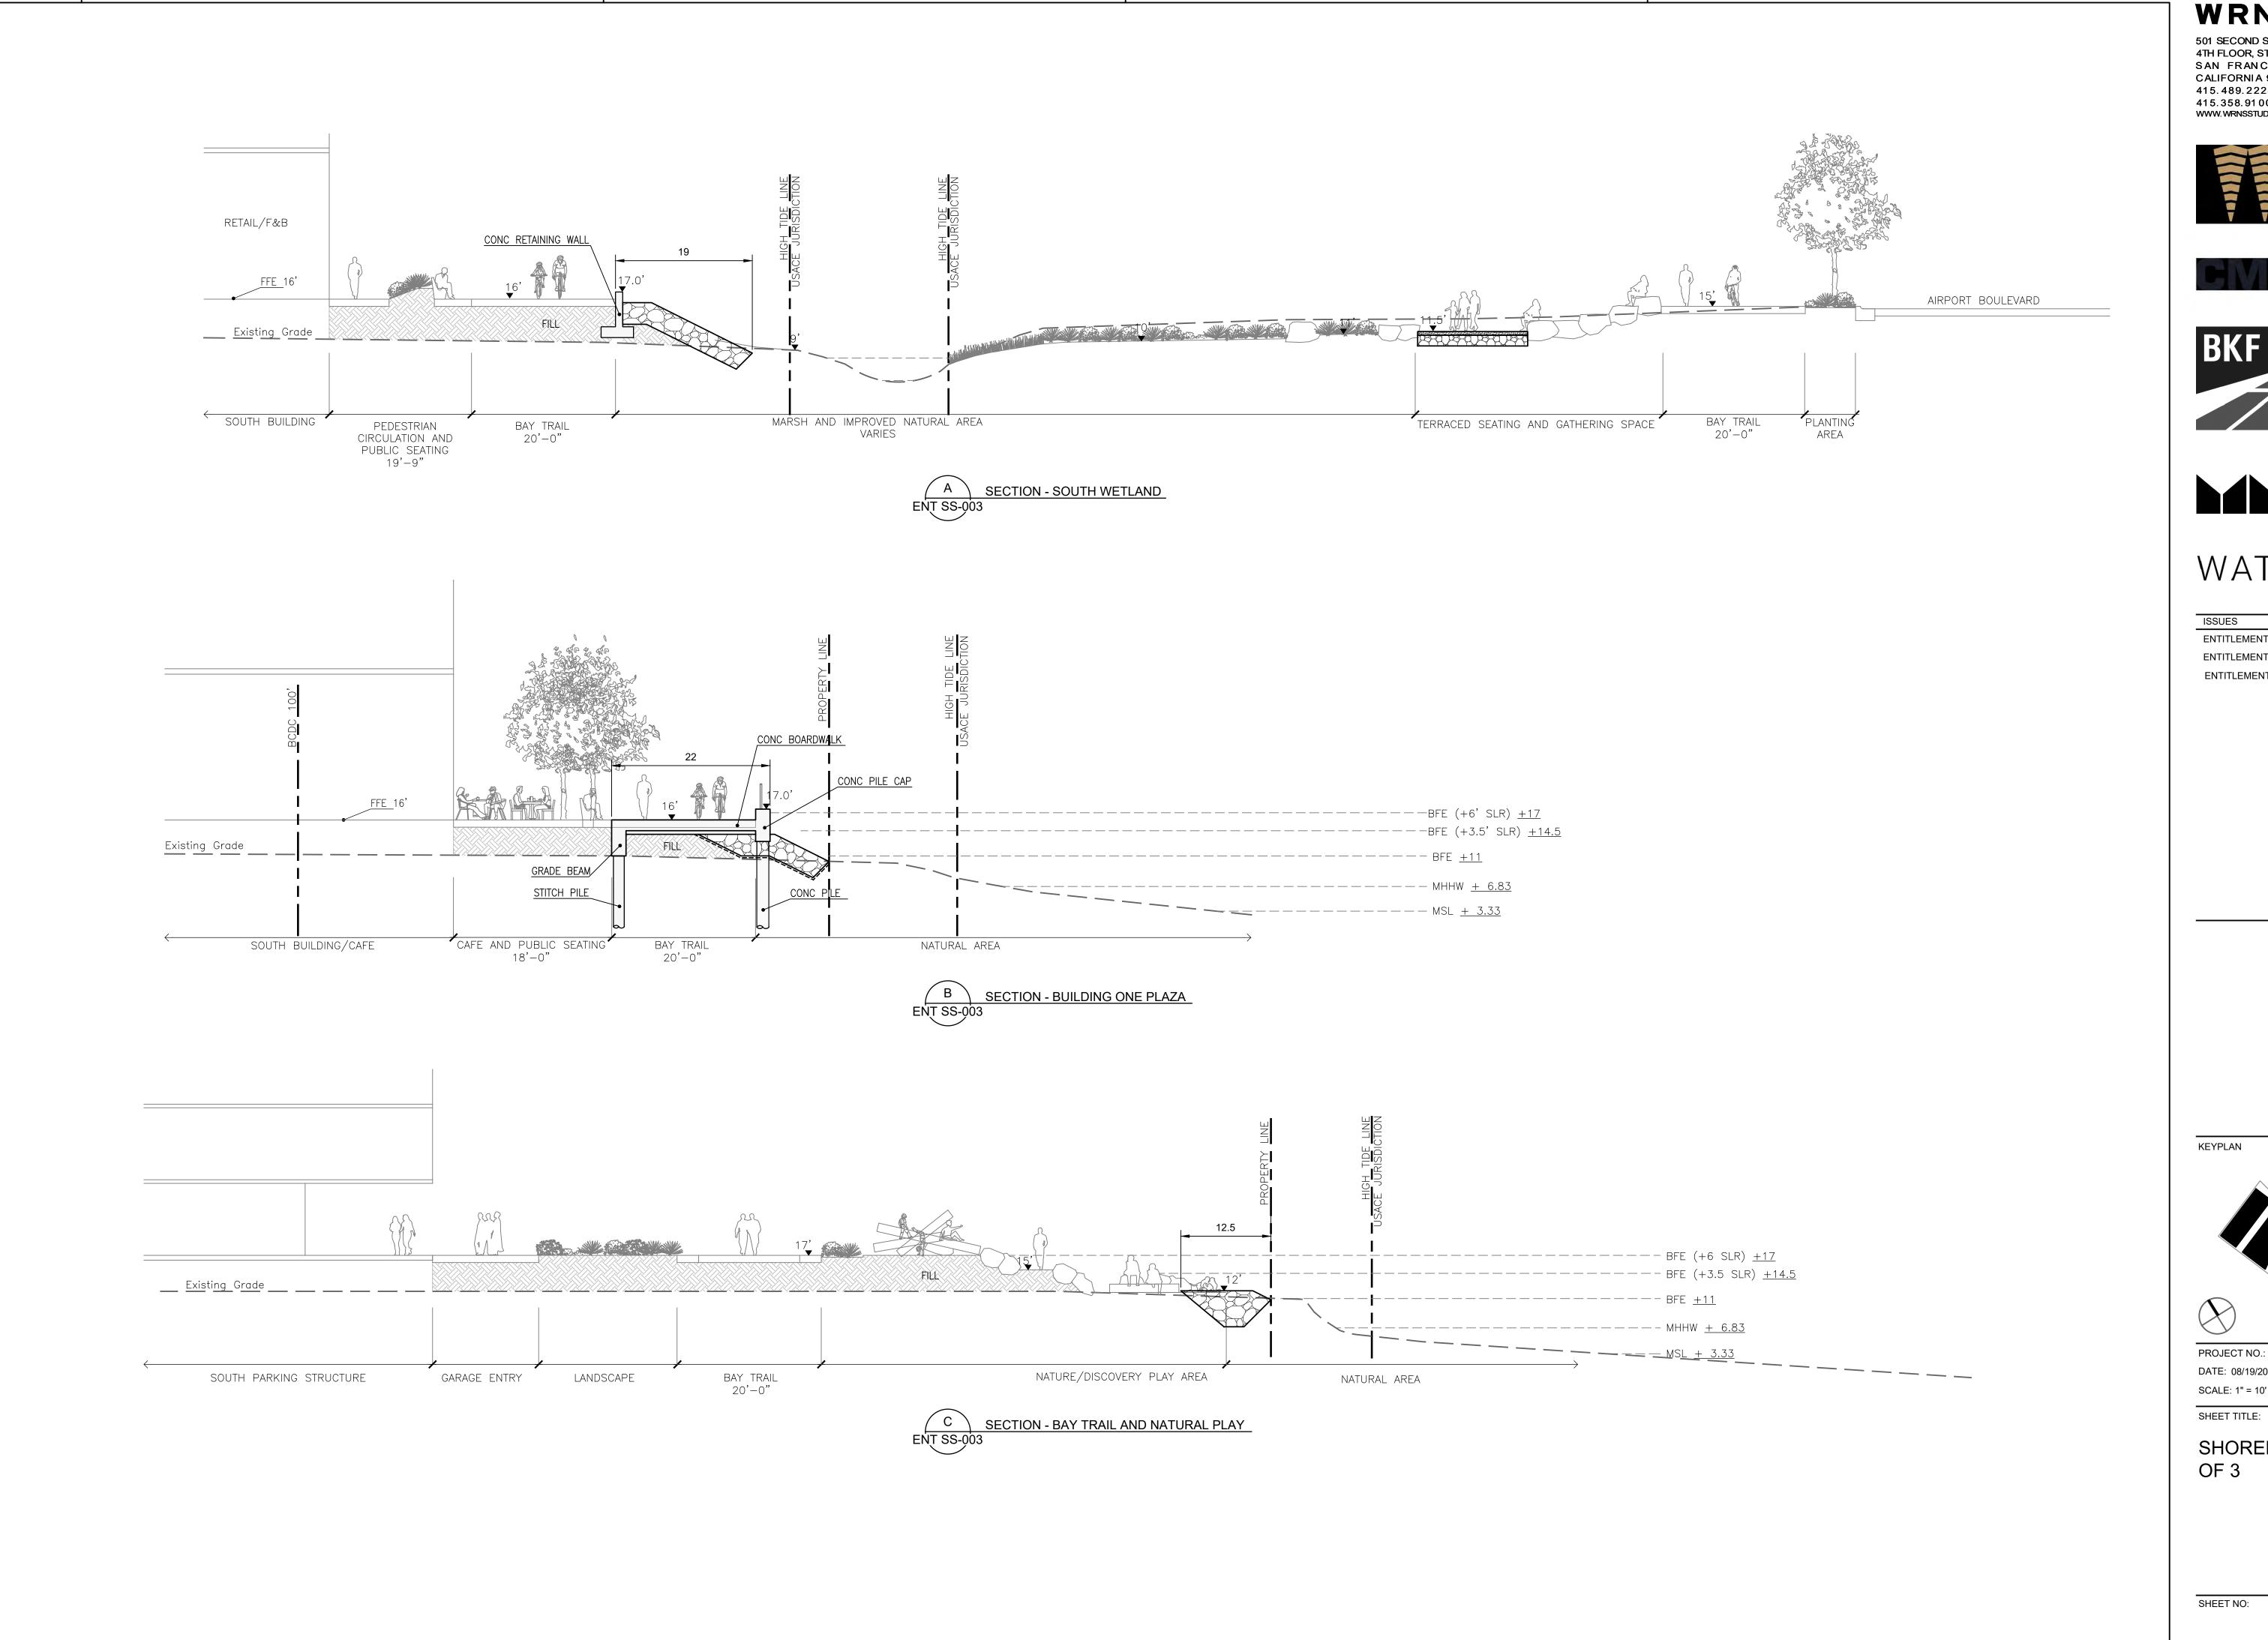



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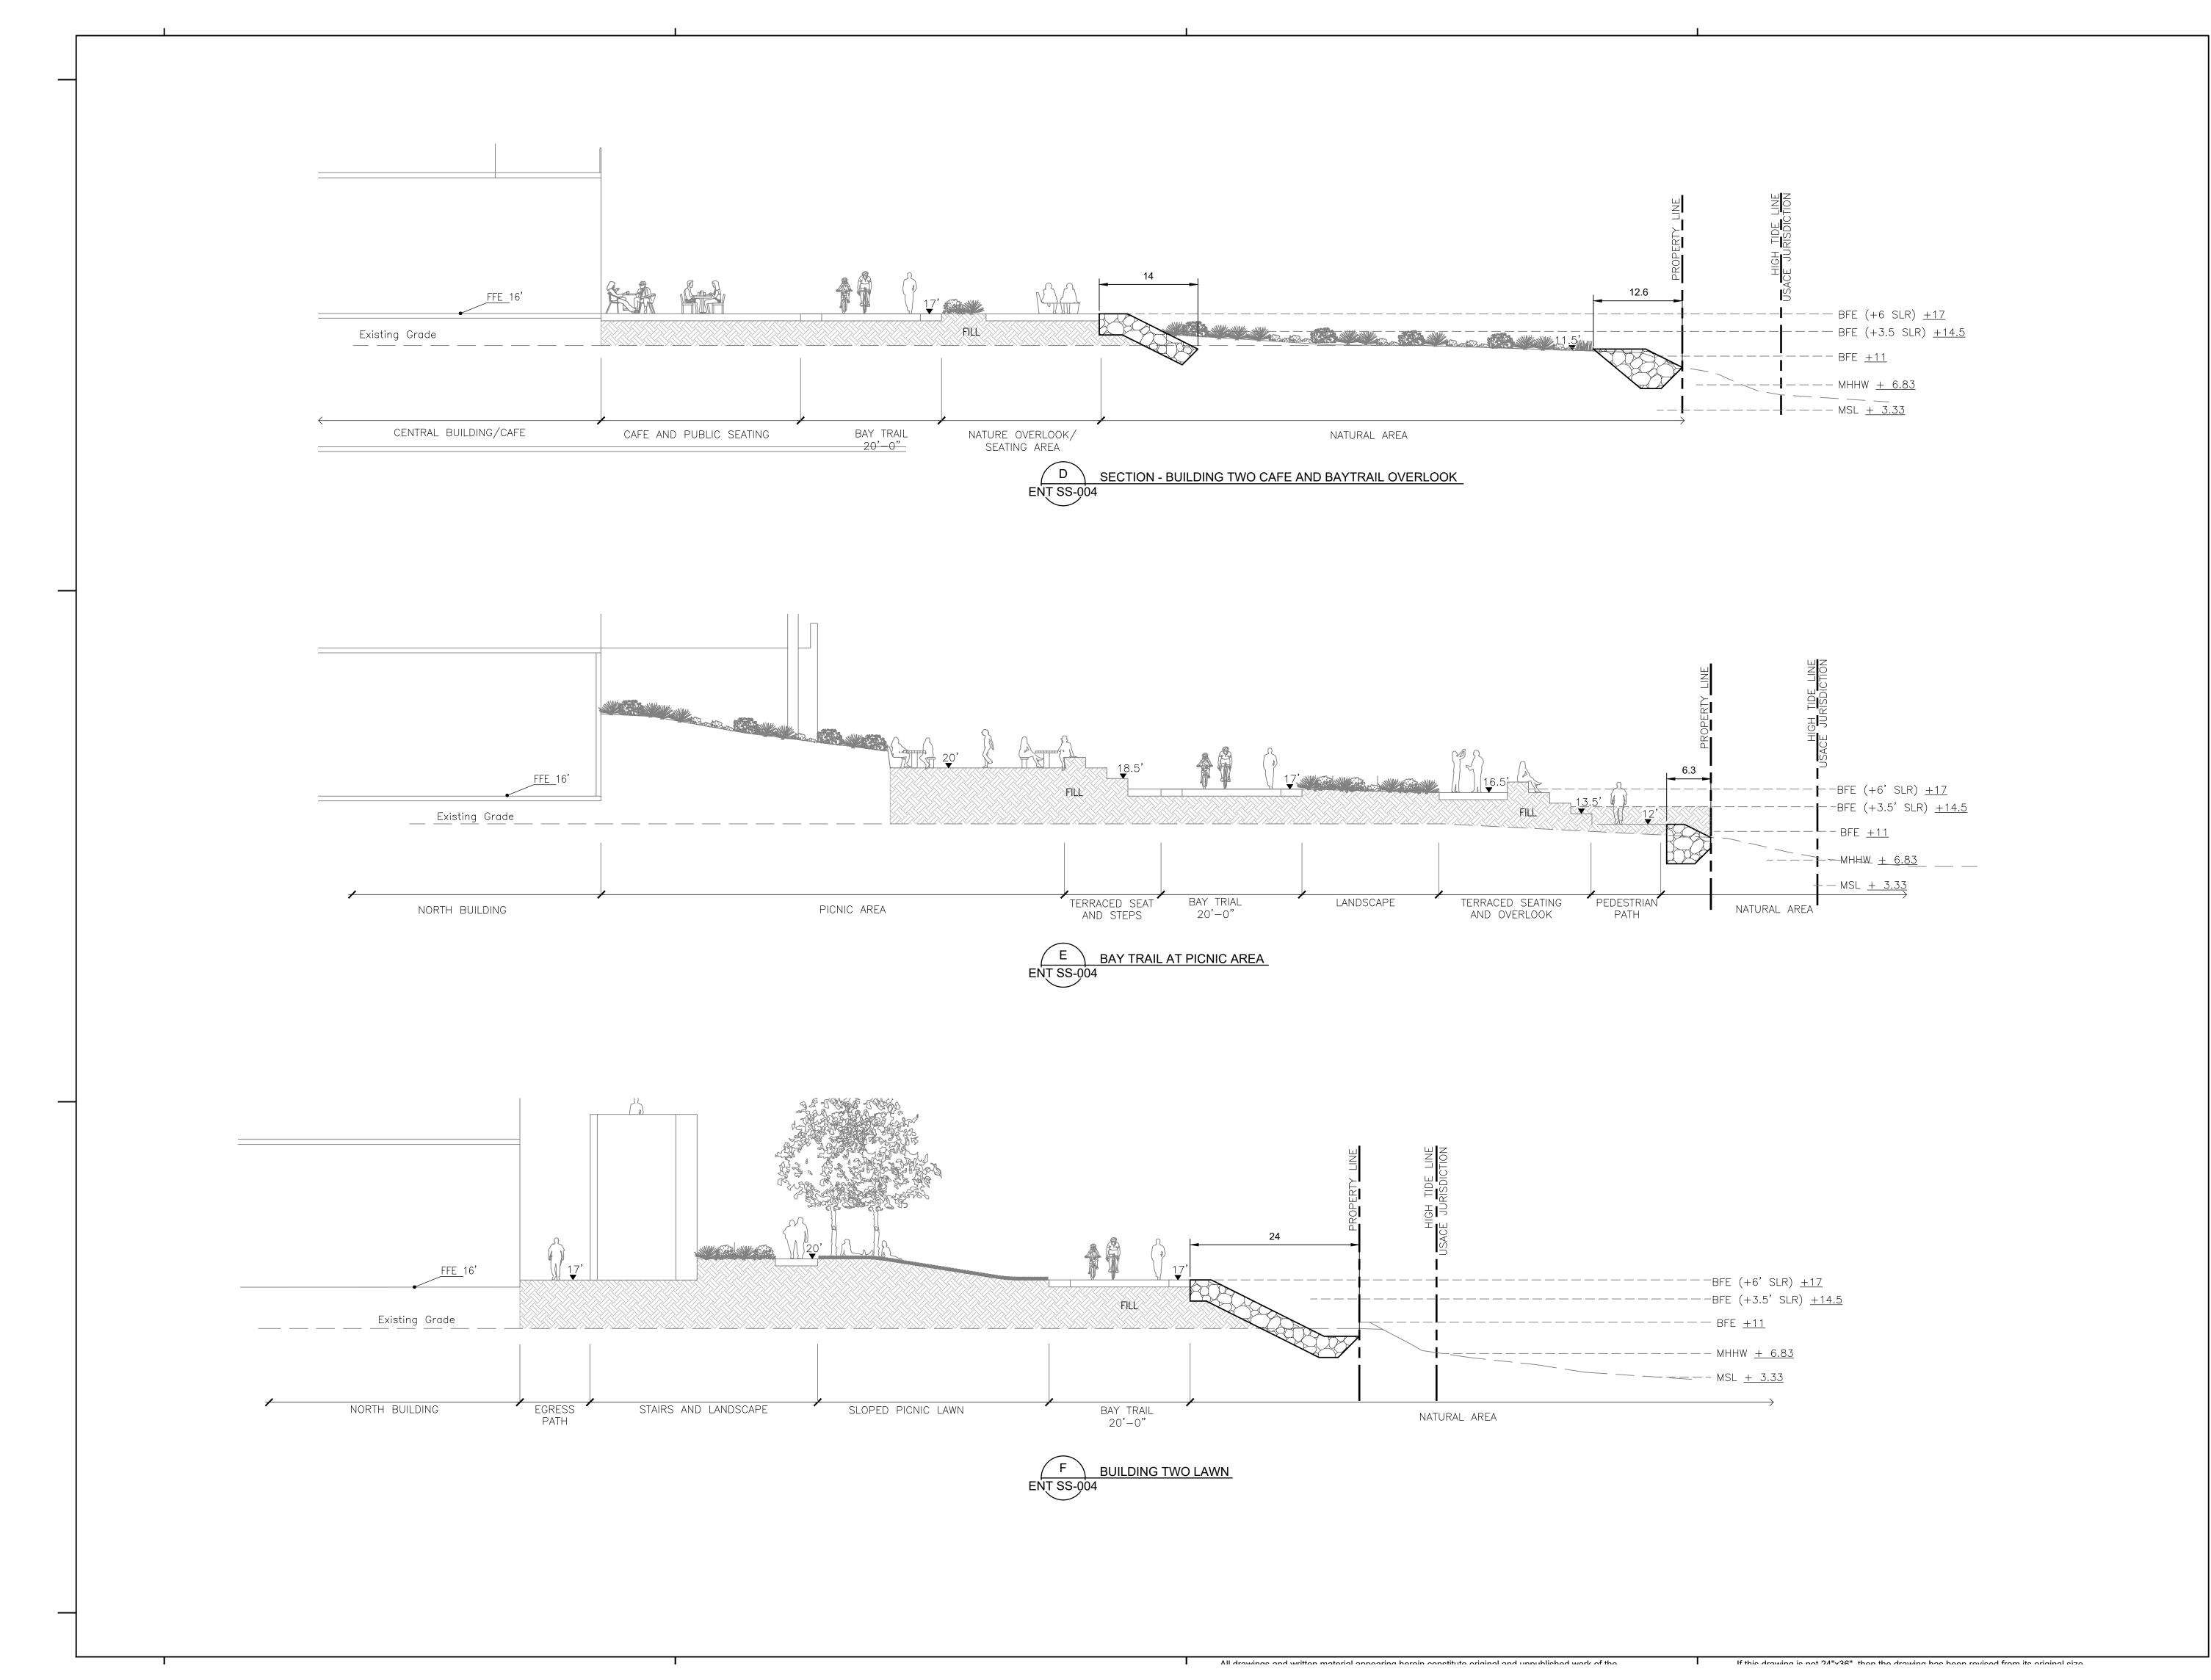
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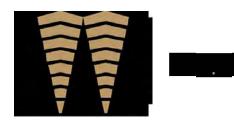
PROJECT NO.: 20045.00 DATE: 08/19/2022 SCALE: 1" = 10'

SHORELINE SECTIONS 1 OF 3

If this drawing is not 21"v26" than the drawing has been revised from its original size



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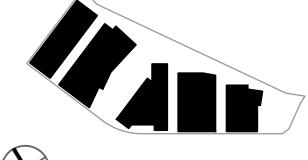


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ENTITLEMENT APPLICATION #3	12/09/2022

KEYPLAN






PROJECT NO.: 20045.00 DATE: 08/19/2022 SCALE: 1" = 10'

SHEET TITLE:

SHORELINE SECTIONS 2 OF 3

SHEET NO:

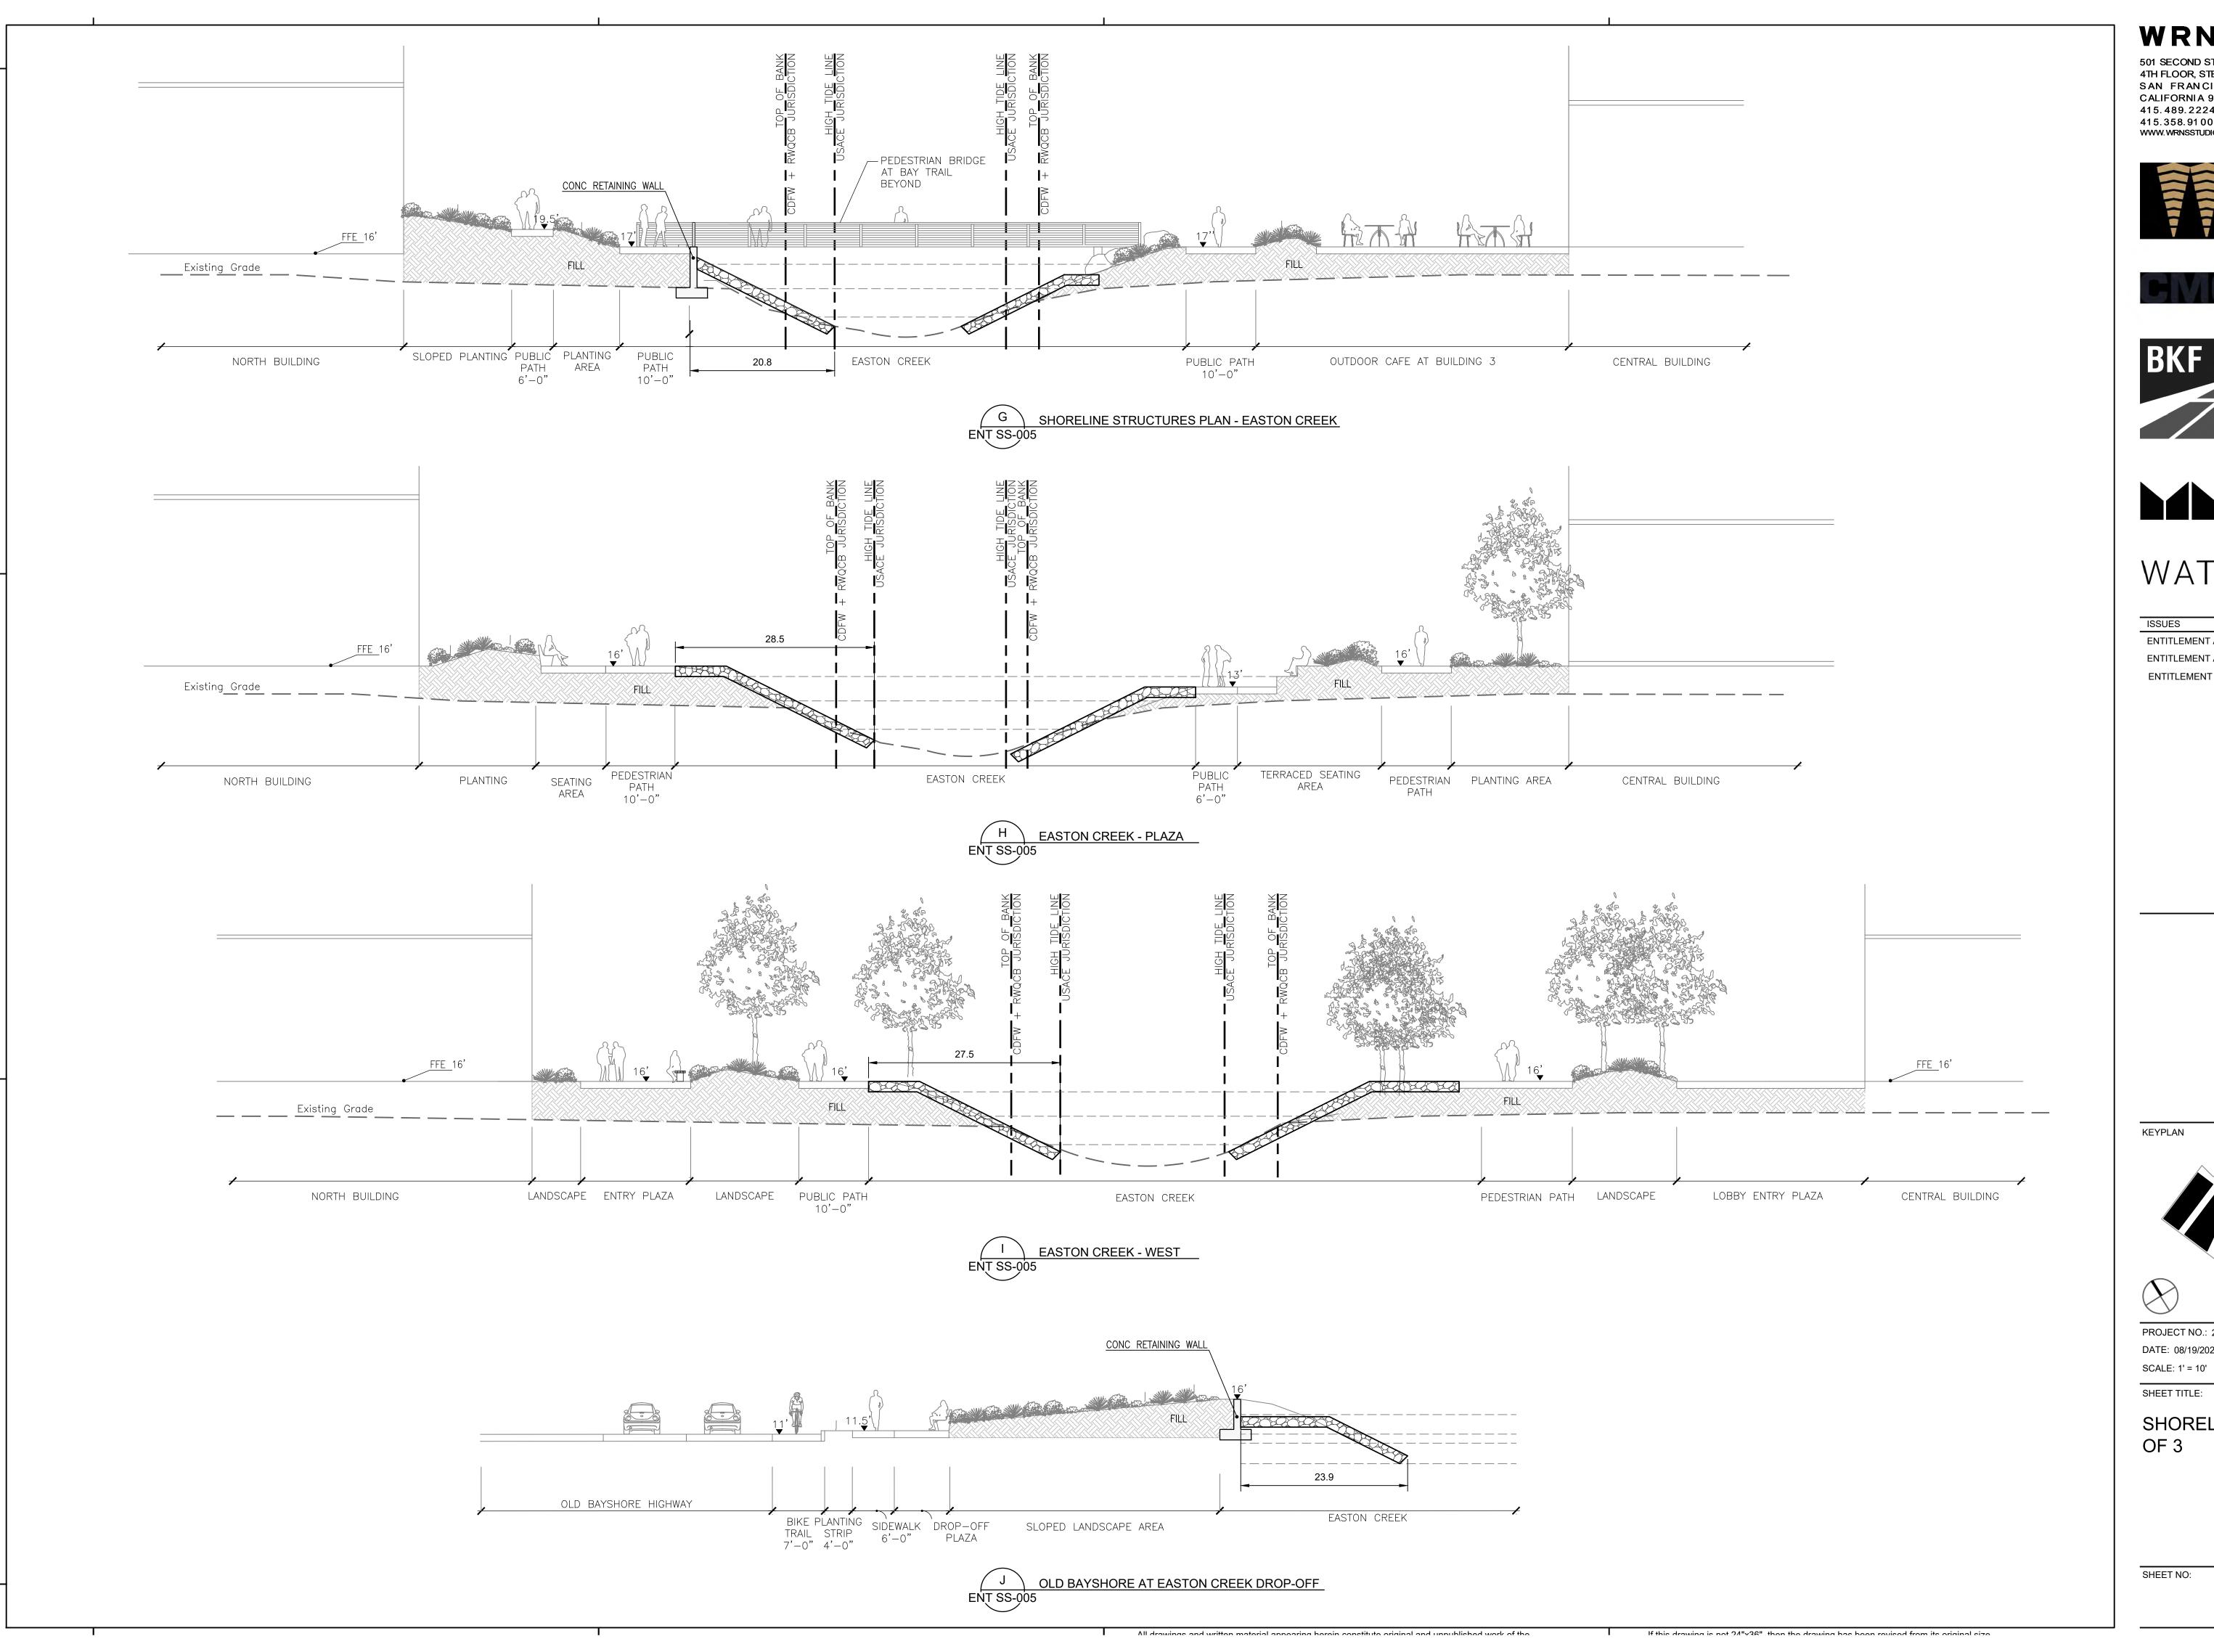

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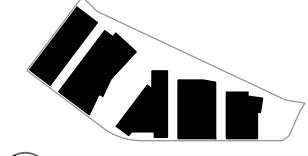




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KEYPLAN






PROJECT NO.: 20045.00 DATE: 08/19/2022

SHEET TITLE:

SHORELINE SECTIONS 3 OF 3

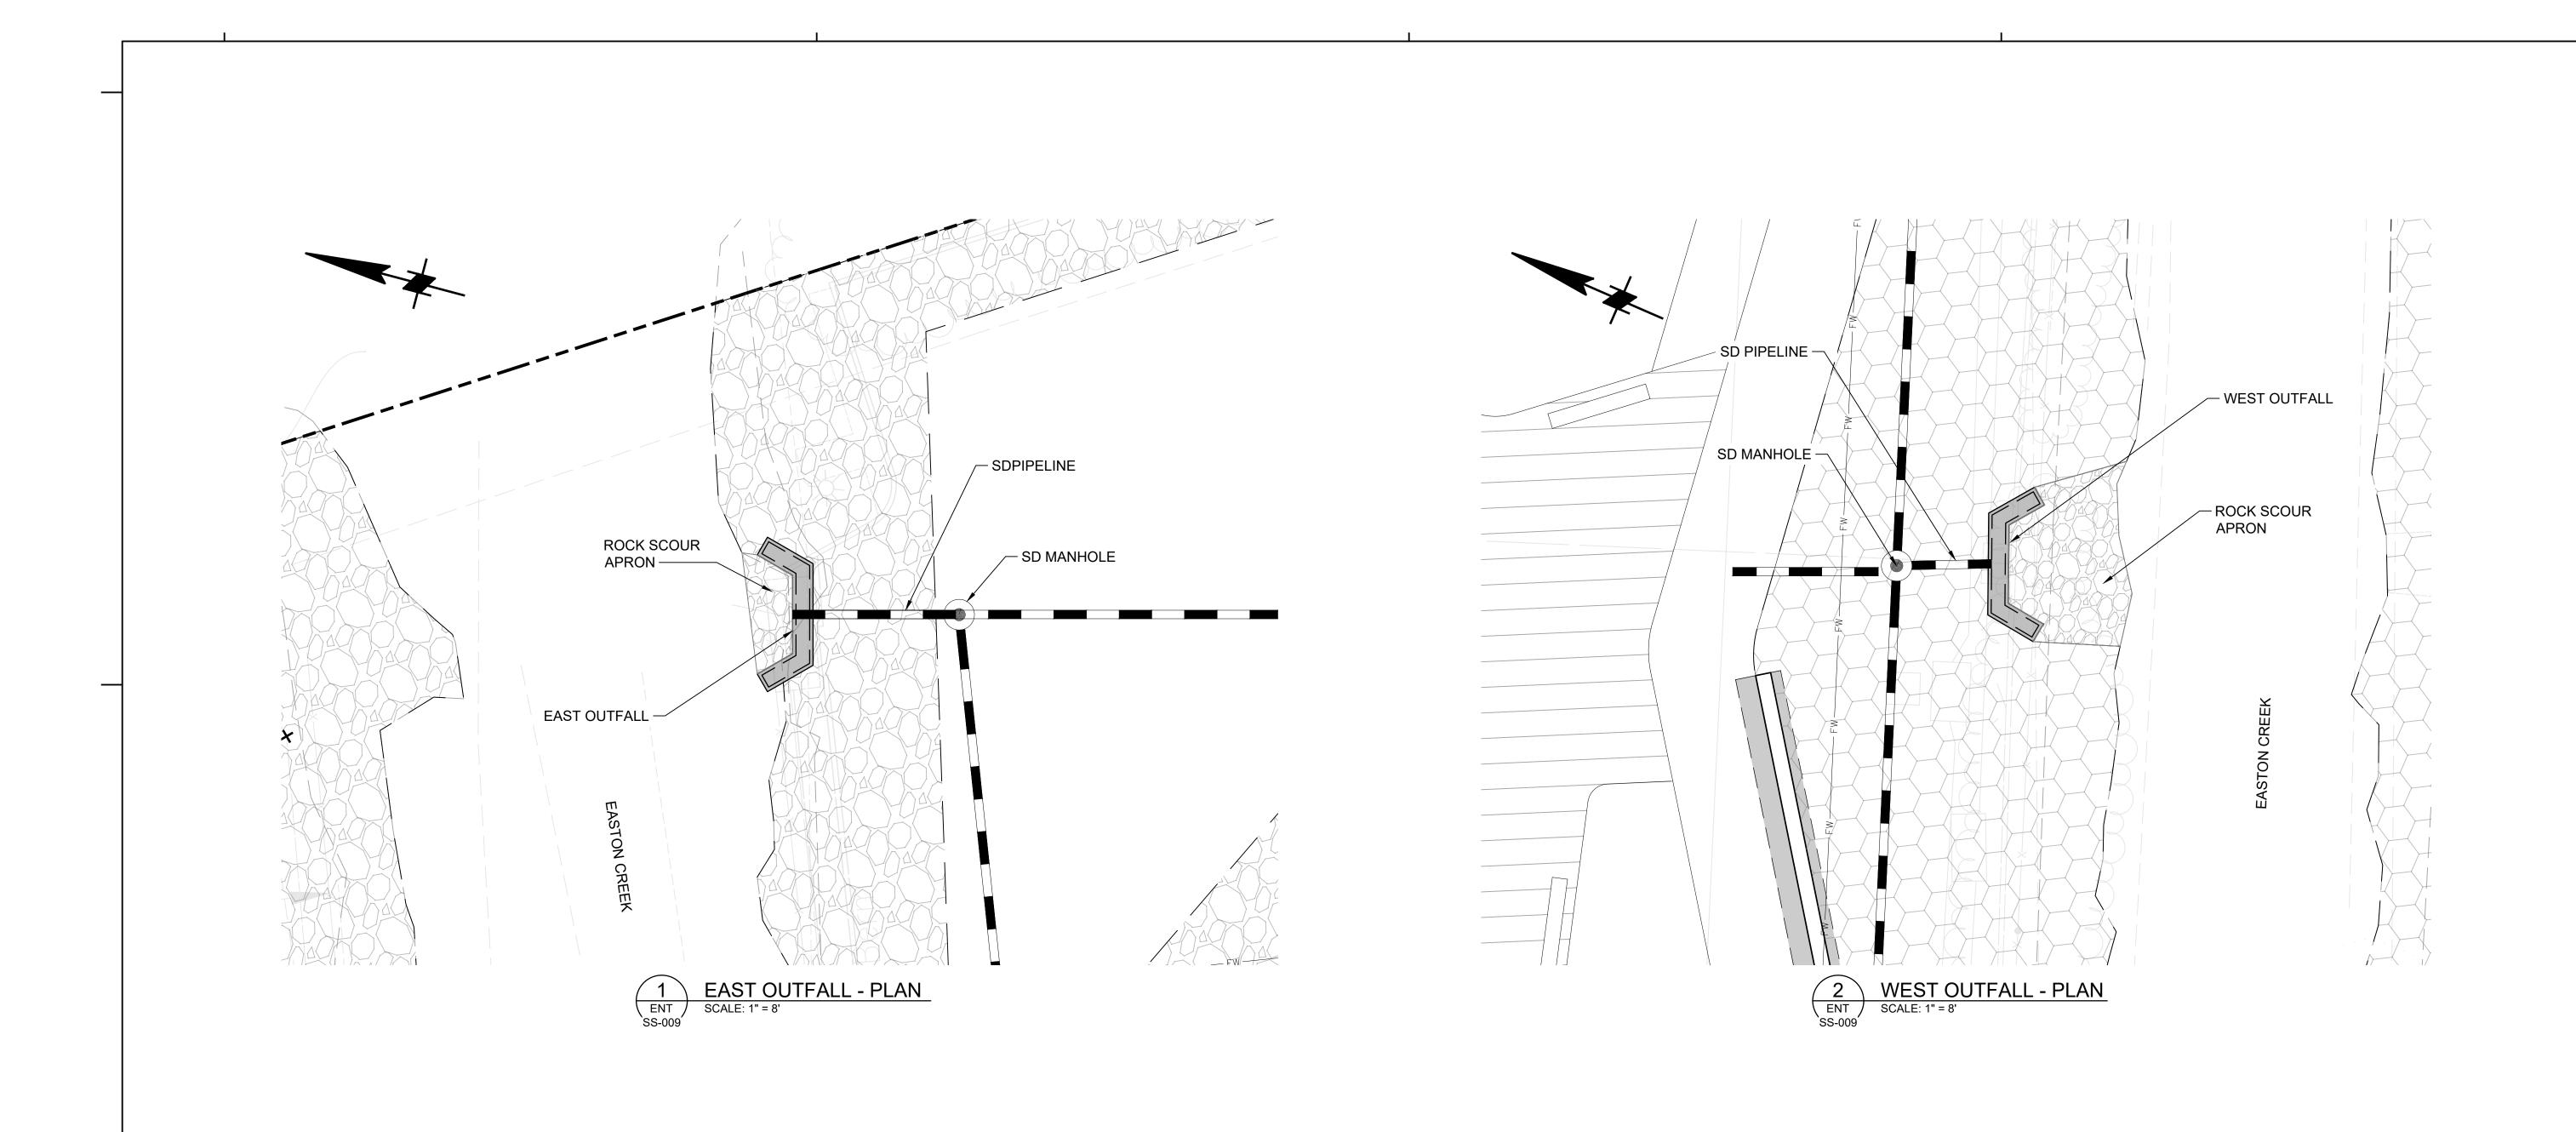

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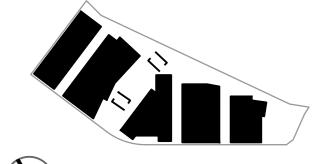


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PROJECT NO.: 20045.00

DATE: 08/19/2022


SCALE: AS SHOWN

SHEET TITLE:

STORMWATER OUTFALL

SHEET NO

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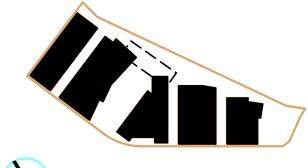


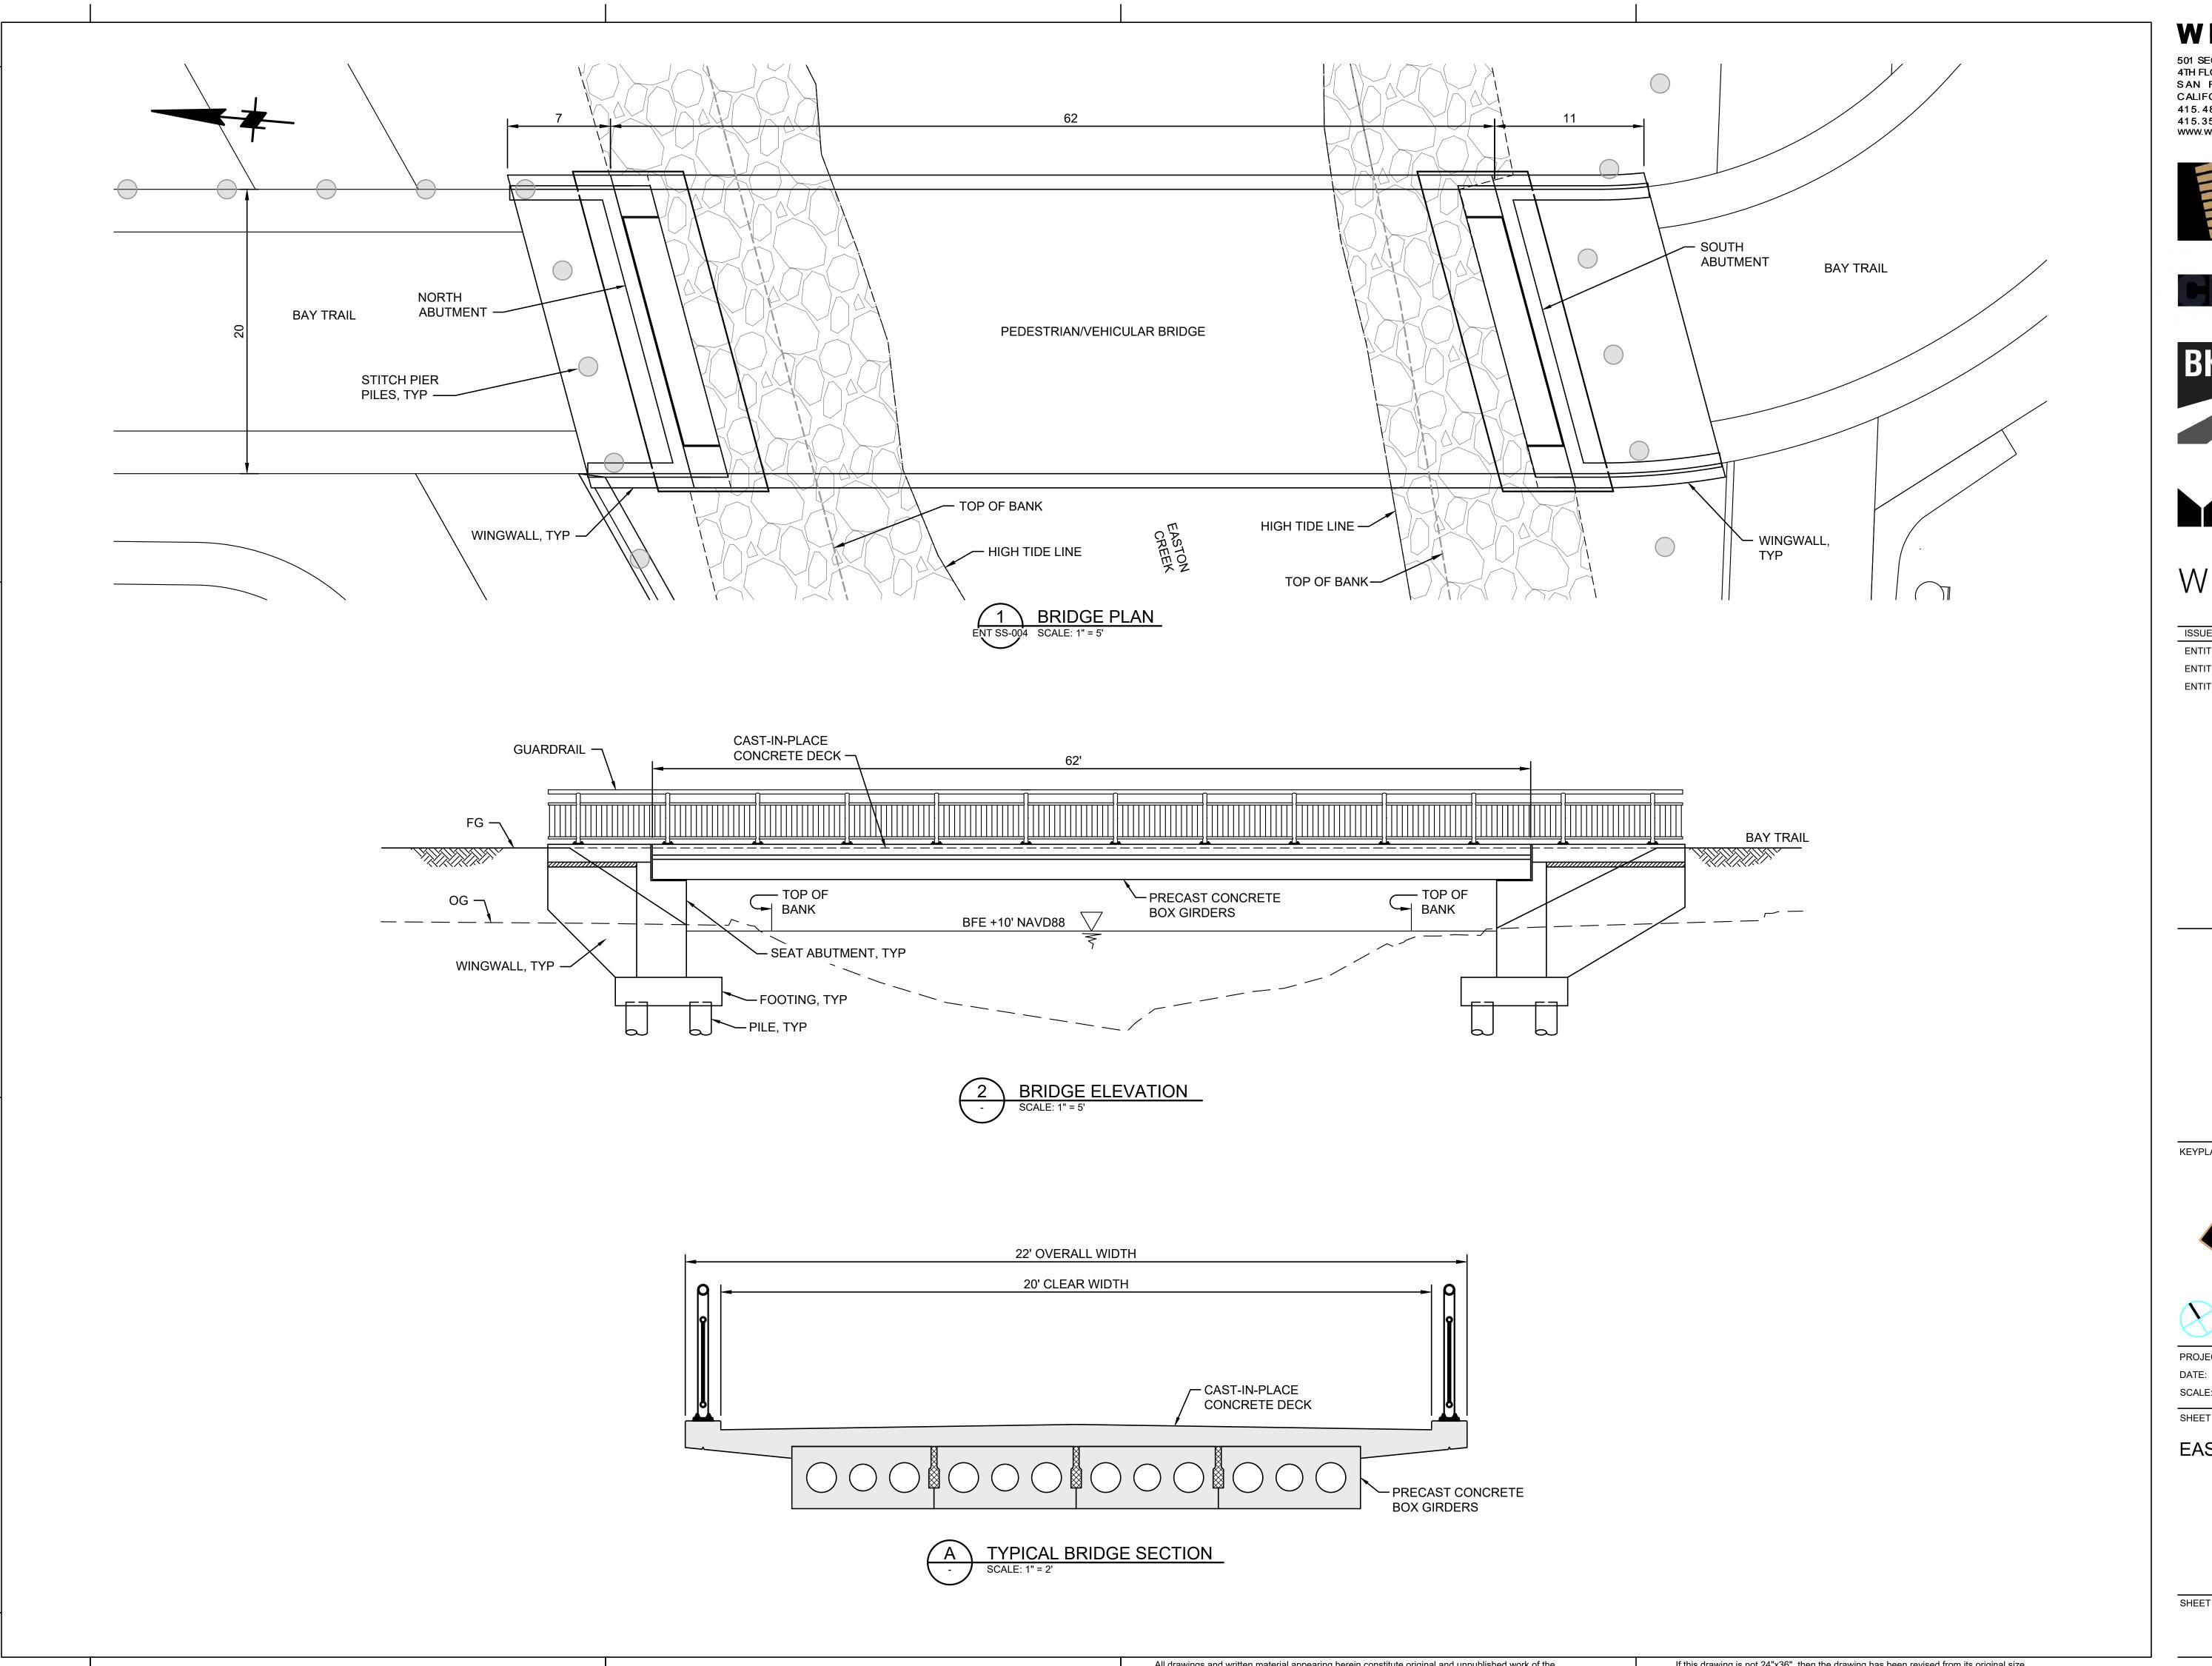

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ENTITLEMENT APPLICATION #3	12/14/2022

KEYPLAN





PROJECT NO.:

SCALE: AS SHOWN

SHEET TITLE:

EASTON CREEK BRIDGE



1 ILLUSTRATIVE SITE LIGHTING PLAN (not to scale)


### <u>Lighting Character - Precedent Images</u>










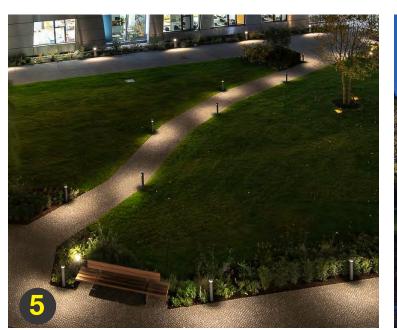






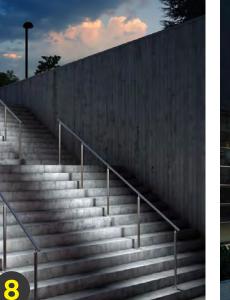



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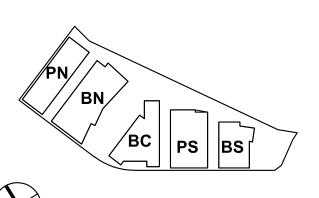
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	ISSUES	DATE
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	ENTITLEMENT APPLICATION #3	12/09/2022
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### 1200-1340 OLD BAYSHORE HIGHWAY

Burlingame, CA 94010

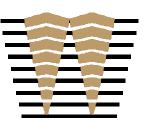KEYPLAN





PROJECT NO.: 20045.00

DATE: 08/19/2022

SCALE: NOT TO SCALE

SHEET TITLE:

ILLUSTRATIVE SITE LIGHTING PLAN

CHEET NO

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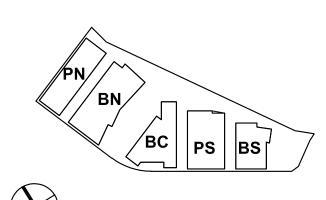



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ENTITLEMENT APPLICATION #3	12/09/2022

### 1200-1340 OLD BAYSHORE HIGHWAY Burlingame, CA 94010

KEYPLAN



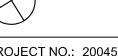

PROJECT NO.: 20045.00 DATE: 08/19/2022 SCALE: 1" = 60'

SHEET TITLE:

SITE LIGHTING PHOTOMETRICS

Charter and Charter	Pedestrian Activity Level Classification			
unctional Classification	High	Medium	Low	E <sub>avg</sub> /E <sub>min</sub>
Major/Major	34/3.2	26/2.4	18/1.7	3.0
Major/Collector	29/2.7	22/2.0	15/1.4	3.0
Major/Local	26/2.4	20/1.9	13/1.2	3.0
Collector/Collector	24/2.2	18/1.7	12/1.1	4.0
Collector/Local	21/2.0	16/1/5	10/0.9	4.0
Local/Local	18/1.7	14/1.3	8/0.7	6.0

Project will use these IES target light levels @ intersections based on expected pedestrian activity

3

#### TARGET ILLUMINATION FOR INTERSECTIONS

#### Table 11-1. Lighting Design Criteria for Streets

(Source: IES-RP8-2021, Recommended Practice: Lighting Roadway and Parking Facilities)

Street Classification	Pedestrian Activity Classification*	Average Luminance* L <sub>avg</sub> (cd/m²)	Average Uniformity Ratio  Lavg/Lmin	Maximum Uniformity Ratio
Major (Old Bayshore Hwy)	High	1.2 (1.7fc)	3.0	5.0
	Medium	0.9	3.0	5.0
	Low	0.6	3.5	6.0
Collector (Airport Blvd)	High	0.8 (1.1fc)	3.0	5.0
	Medium	0.6	3.5	6.0
	Low	0.4	4.0	8.0
Local (Service Roads)	High	0.6	6.0	10.0
	Medium	0.5 (0.7fc)	6.0	10.0
	Low	0.3	6.0	10.0

PEDESTRIAN CLASSIFICATIONS (Source: IES-RP8-2021)

HIGH = over 100 pedestrians/hour

**MEDIUM** = 1 to 100 pedestrians / hour


LOW = 10 or fewer pedestrians / hour

\* Equivalent illuminance level (in footcandles) shown in red for R2 / R3 pavement types



8/1/2022 5:48:22 PM

#### TARGET ILLUMINATION FOR ROADWAYS

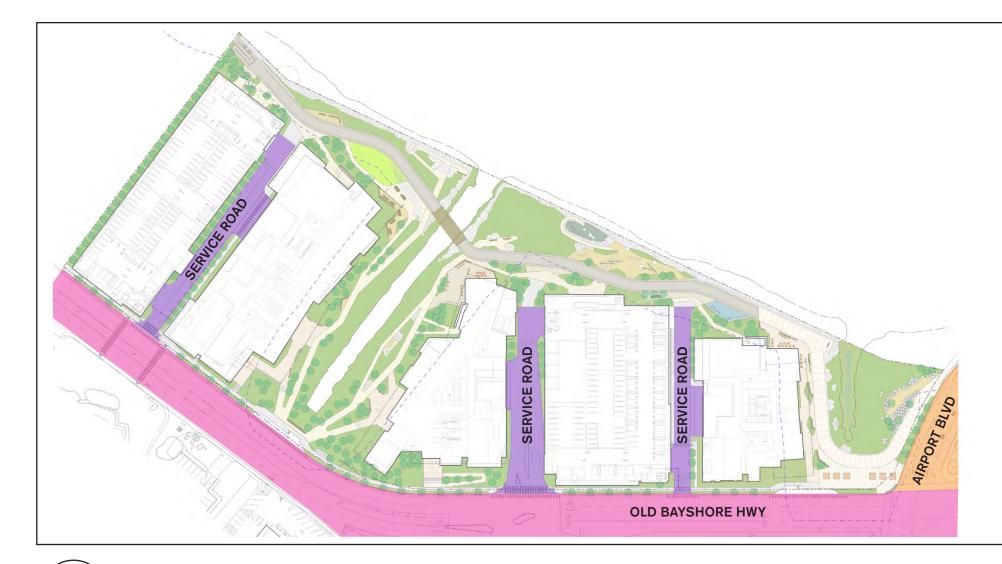

ROADWAY CLASSIFICATIONS: (Source: IES-RP8-2021)

**MAJOR** = Principal network for throughtraffic flow [but not Freeway or Expressway]; often known as "arterials or thoroughfares."

**COLLECTOR** = Roadways servicing traffic between major and local streets.

**LOCAL** = Primarily for direct access to residential, commercial, industrial, or other abutting property.

Traffic-scale "cobrahead" roadway fixture per Caltrans and City of Burlingame standards


- Type POE01
- Caltrans "Type 15" standard pole @ nominal 30' pole height with
- 12' length arm (fixture mounting height @ nominal 34').
- LED "cobrahead" fixture, Type III Medium lighting distribution, 15,900 delivered lumens @ 4000K color temperature, 203 Watts.
- Exact manufacturer and catalog number of POE01 fixture head to be confirmed by Caltrans and City of Burlingame.

standard.

• Type POE02

Pedestrian-scale roadway fixture per City of Burlingame

- Nominal 19.5' height with tapered pole
- LED fixture, Type III Short lighting distribution, 4,530 delivered lumens @ 4000K color temperature, 50.6 Watts.
- Exact manufacturer and catalog number of POE02 fixture head to be confirmed by City of Burlingame.

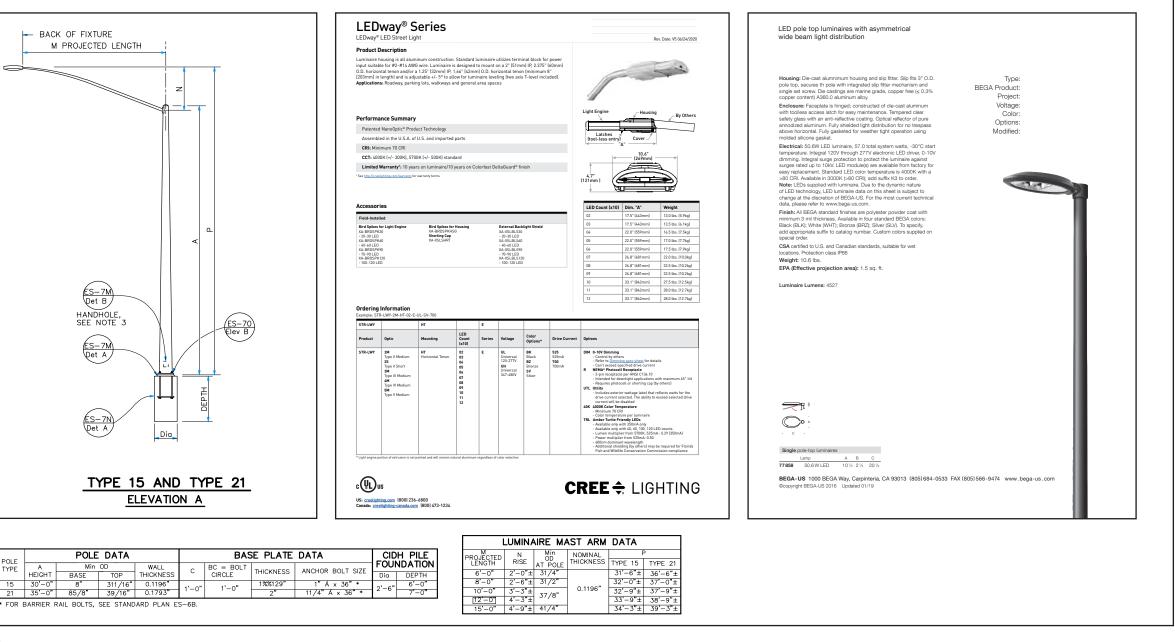

# 6

#### STREET LIGHTING EQUIPMENT (OLD BAYSHORE HWY & AIRPORT BLVD)

OLD BAYSHORE HWY SIDEWALK	1.3fc Average*
AIRPORT BLVD SIDEWALK	0.9fc Average*
SERVICE ROAD SIDEWALK	0.6fc Average*

\* IES recommends that sidewalk illumination (adjacent roadways) be 80% of roadway, using conversion factor  $1cd/m^2 = 15lux (1.5fc)$ 



### TARGET ILLUMINATION FOR SIDEWALKS

# Table 11-2. Recommended Design Criteria for Walkways [and Bikeways] Within Road Right of Way (Source: IES-RP8-2021, Recommended Practice: Lighting Roadway and Parking Facilities)

Condition	E <sub>avg</sub> , lux (fc)	E <sub>v,avg</sub> lux (fc)	E <sub>avg</sub> /E <sub>min</sub> *
High pedestrian activity	10 (0.9)	5 (0.5)	5.0
Medium pedestrian activity	5 (0.5)	2 (0.2)	5.0
Low pedestrian activity	2 (0.2)	1 (0.1)	10.0

4

TARGET ILLUMINATION FOR BIKEWAYS WITHIN ROAD RIGHT OF WAY (aka Bike Lanes)

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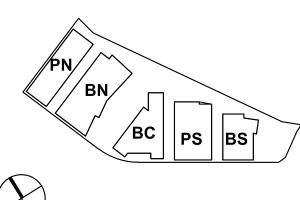





DATE
03/24/2022
08/19/2022
12/09/2022

### 1200-1340 OLD BAYSHORE HIGHWAY Burlingame, CA 94010

\_\_\_\_KEYPLAN



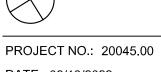

PROJECT NO.: 20045.00


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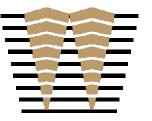
SHEET TITLE:

SITE LIGHTING CHARACTER

CHEET NO.



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Architects • Engineers • Parking Planners

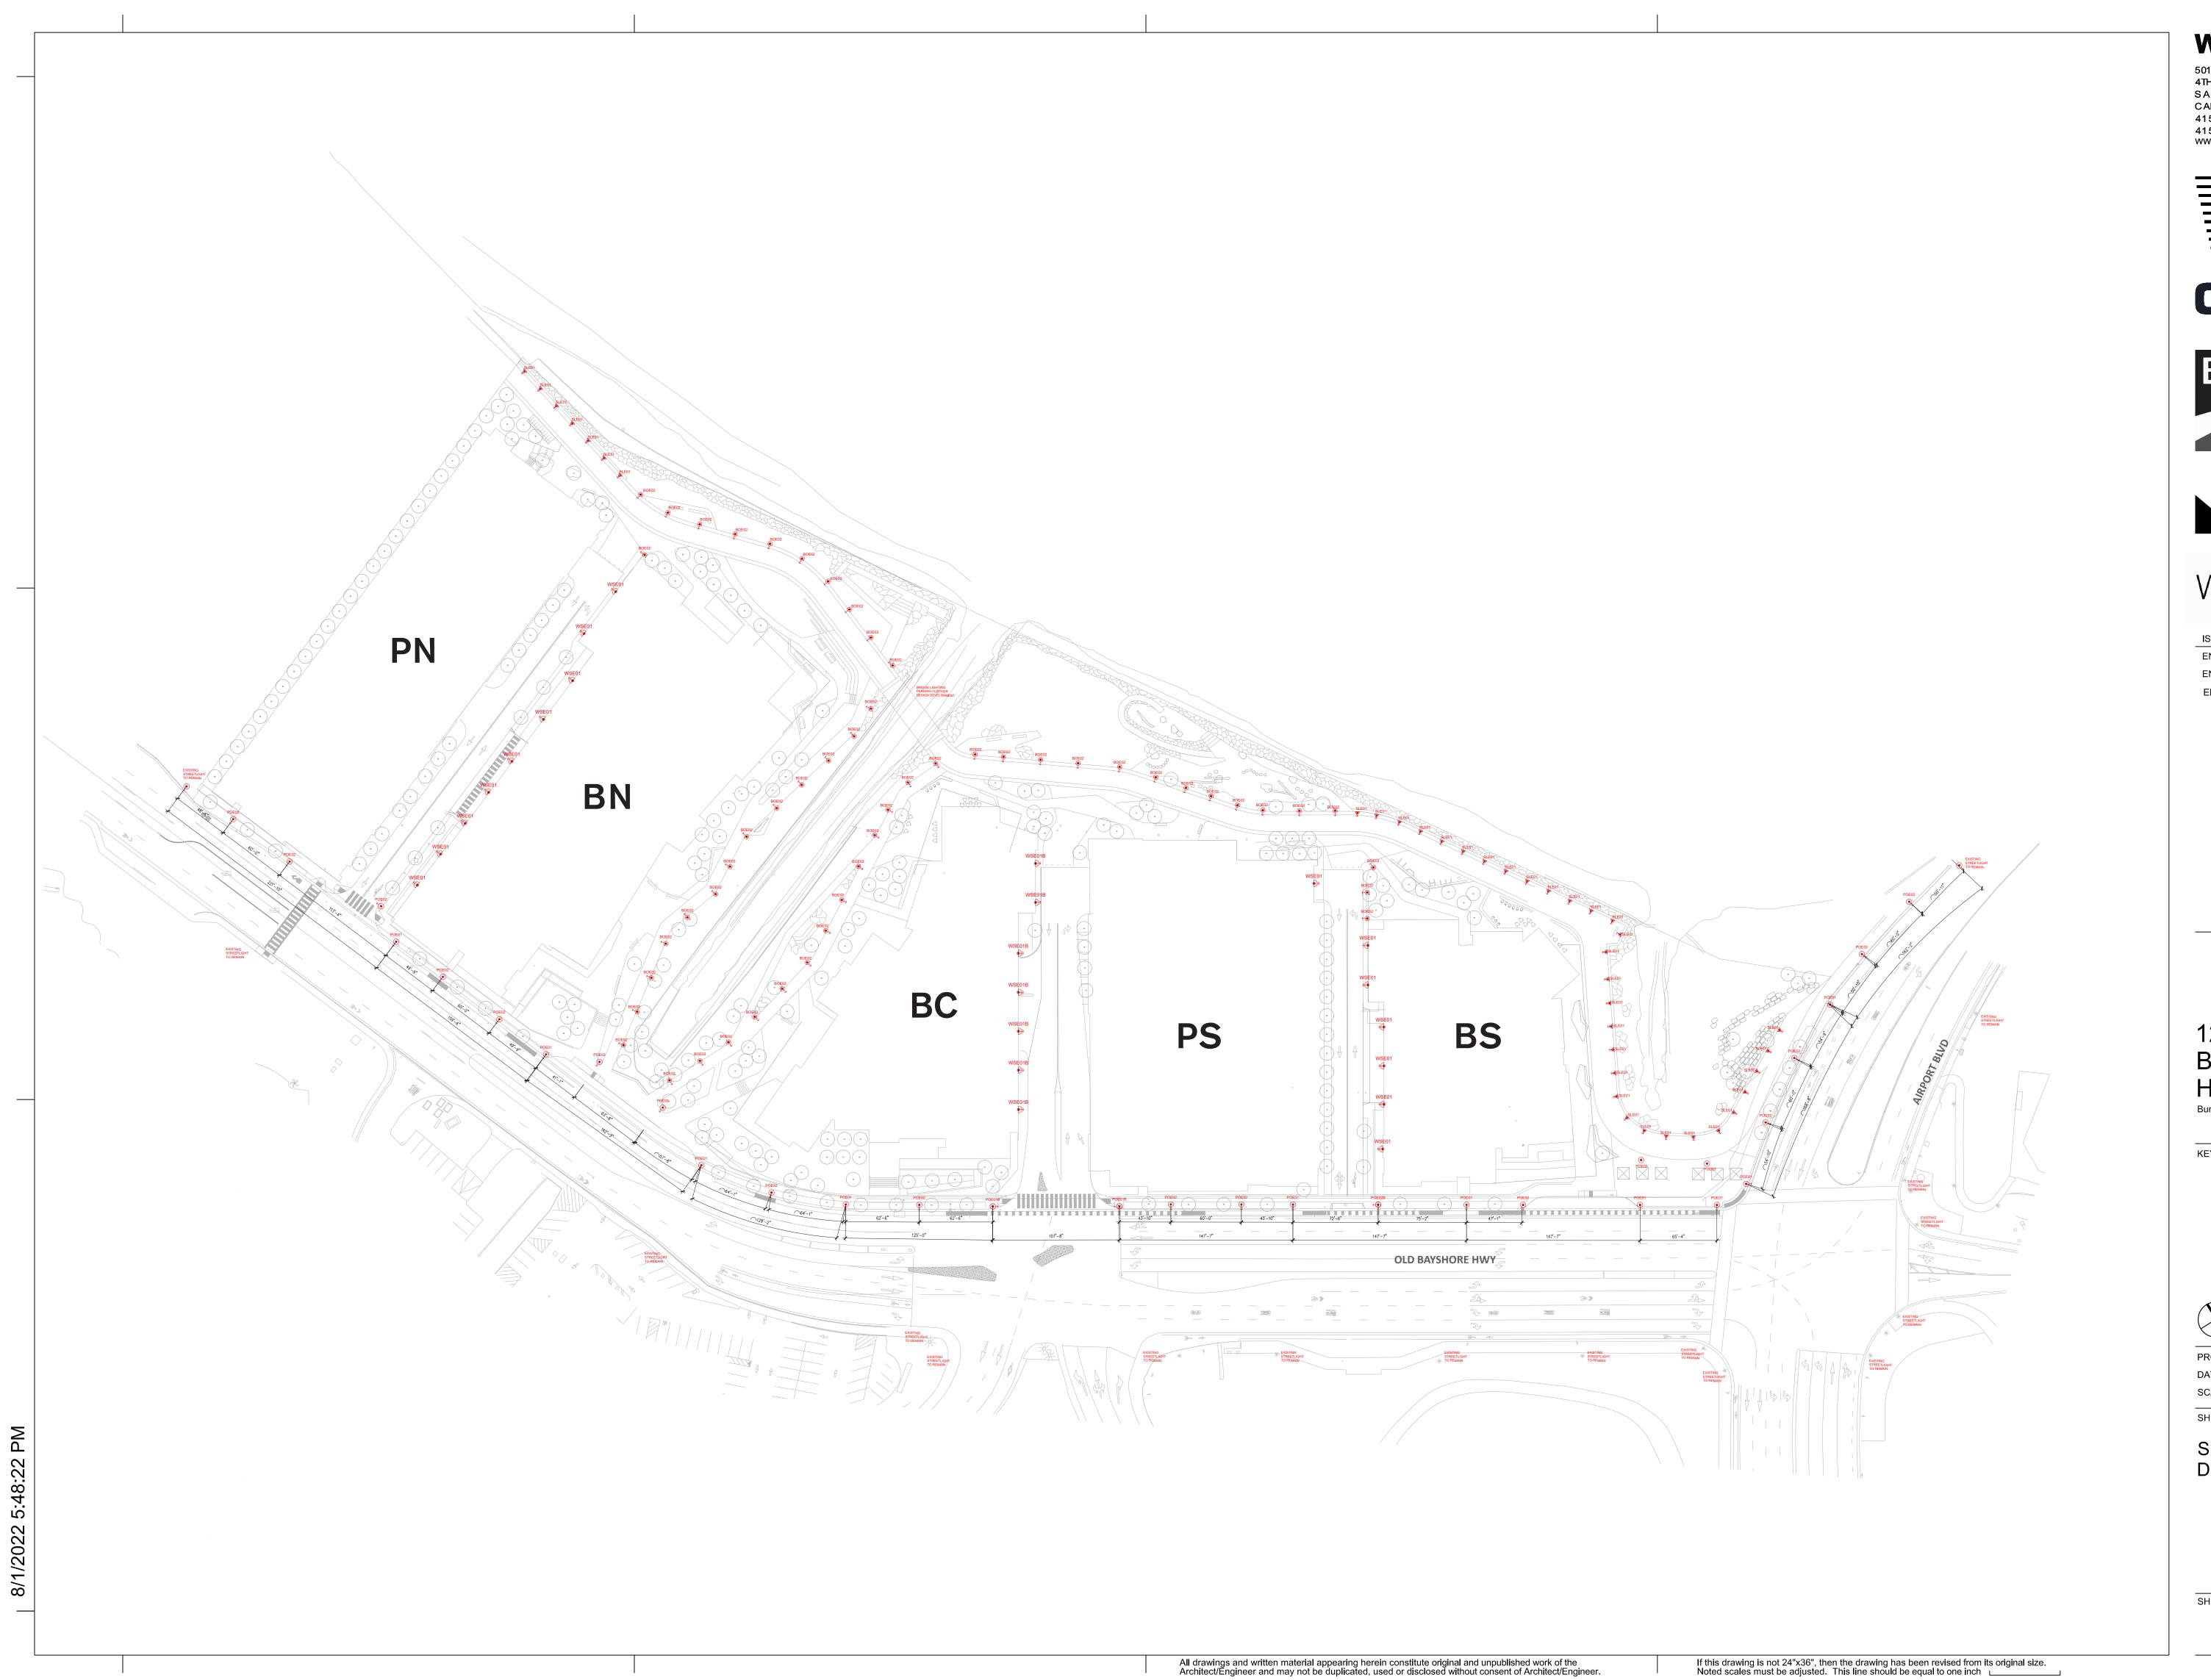






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ENTITLEMENT APPLICATION #3	12/09/2022

### 1200-1340 OLD BAYSHORE HIGHWAY Burlingame, CA 94010

KEYPLAN



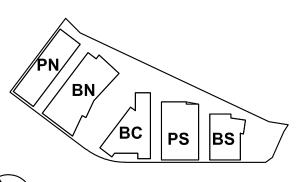

PROJECT NO.: 20045.00

DATE: 08/19/2022

SCALE: 1" = 60'

SHEET TITLE:

SITE LIGHTING DIMENSIONS

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